


# CITY OF PITTSBURG

## PUBLIC WORKS ENGINEERING DIVISION CRESTVIEW DRIVE SAFETY IMPROVEMENTS PROJECT

PROJECT NO. 2028 HSIPSL-5127 (040)

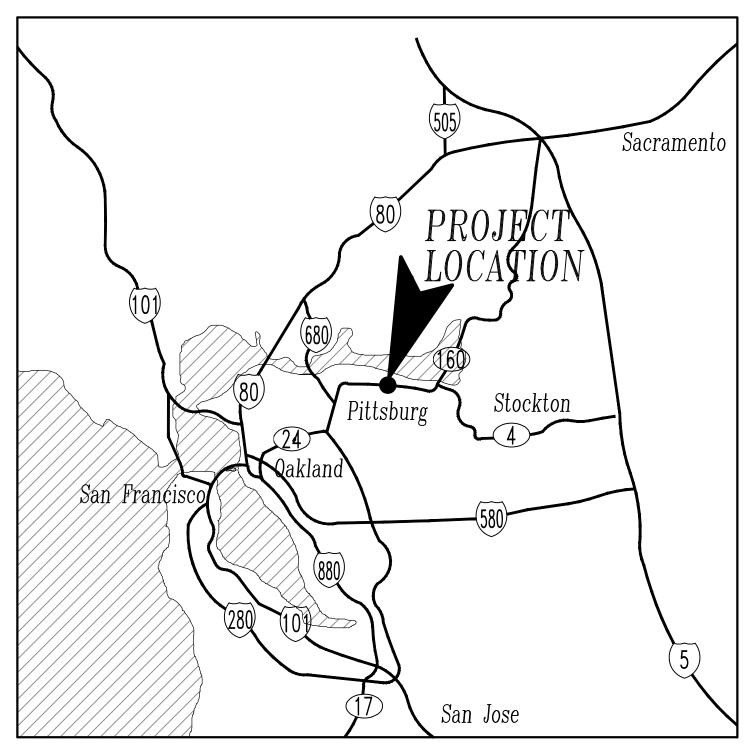

**VICINITY MAP** 

JOHN SAMUELSON, P.E., CITY ENGINEER DATE: 3/6/2024

ACCEPTANCE OF THESE IMPROVEMENT PLANS BY THE CITY ENGINEER SHALL NOT RELIEVE THE ENGINEER OF RECORD FOR THE DESIGN NOR FROM ANY DEFICIENCIES RESULTING FROM THE DESIGN THEREOF.

COPY FORMAT. A "RECORD DRAWING" SHALL BE SUBMITTED TO THE CITY

THROUGH ELECTRONIC OR HARD COPY PRIOR TO ACCEPTANCE OF THE WORK AS COMPLETE.

## SHEET INDEX

23

SHT. NO. DRAWING TITLE

**COVER SHEET** 

**GENERAL NOTES** 


PITTSBURG

DEMOLITION PLAN - CRESTVIEW DRIVE AND ATHERTON AVENUE DEMOLITION PLAN - CRESTVIEW DRIVE AND KINGSBERRY PLACE IMPROVEMENT PLAN - CRESTVIEW DRIVE AND WILLIAM WAY IMPROVEMENT PLAN - CRESTVIEW DRIVE AND ATHERTON AVENUE IMPROVEMENT PLAN - CRESTVIEW DRIVE AND KINGSBERRY PLACE GRADING PLAN - CRESTVIEW DRIVE AND WILLIAM WAY GRADING PLAN - CRESTVIEW DRIVE AND ATHERTON AVENUE HORIZONTAL CONTROL PLAN - CRESTVIEW DRIVE AND WILLIAM WAY 12 13 HORIZONTAL CONTROL PLAN - CRESTVIEW DRIVE AND ATHERTON AVENUE HORIZONTAL CONTROL PLAN - CRESTVIEW DRIVE AND KINGSBERRY PLACE CIVIL DETAILS CIVIL DETAILS ELECTRICAL, SIGNING, AND STRIPING PLANS NOTES AND DETAILS SIGNING AND STRIPING PLANS - CRESTVIEW DRIVE AND CRESTVIEW LANE SIGNING AND STRIPING PLANS - CRESTVIEW DRIVE AND WILLIAM WAY 20 SIGNING AND STRIPING PLANS - CRESTVIEW DRIVE AND ATHERTON AVENUE 21 SIGNING AND STRIPING PLANS - CRESTVIEW DRIVE AND KINGSBERRY PLACE 22 SIGNING AND STRIPING PLANS - CRESTVIEW DRIVE AND SUNNYHILL WAY/ALTA VISTA CIRCLE

SIGNING AND STRIPING PLANS - CRESTVIEW DRIVE AND NINA PLACE

DEMOLITION PLAN - CRESTVIEW DRIVE AND WILLIAM WAY

ATTENTION IS DIRECTED TO THE PROVISIONS OF CHAPTER 9 OF DIVISION 3 OF THE BUSINESS AND PROFESSIONS CODE CONCERNING THE LICENSING OF CONTRACTORS. THE PRIME CONTRACTOR SHALL POSSESS A CALIFORNIA CLASS "A" OR "C-12" LICENSE AT THE TIME THIS CONTRACT IS AWARDED.

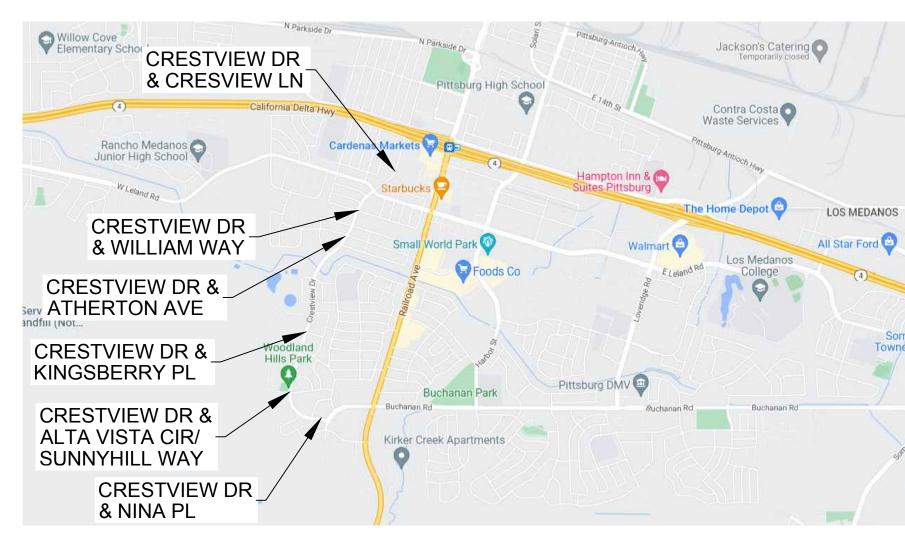

**LOCATION MAP** 

## THE CITY COUNCIL OF THE CITY OF PITTSBURG

JUAN ANTONIO BANALES, MAYOR JELANI KILLINGS. VICE-MAYOR DIONNE ADAMS. COUNCIL MEMBER ANGELICA LOPEZ, COUNCIL MEMBER SHANELLE SCALES-PRESTON.COUNCIL MEMBER


GARRETT EVANS, CITY MANAGER ALICE EVENSON, CITY CLERK JOHN SAMUELSON, DIRECTOR PUBLIC WORKS, CITY ENGINEER

CITY ENGINEER SHALL SIGN ANY REVISION PRIOR OR DURING CONSTRUCTION. A COPY OF THE REVISION SHALL BE SUBMITTED TO THE CITY THROUGH ELECTRONIC OR HARD

REV. DATE City of Pittsburg **Public Works Engineering Department** 65 Civic Avenue Pittsburg, CA 94565 Tel: (925) 252-4930 http://www.ci.pittsburg.ca.us/

CRESTVIEW DRIVE SAFETY IMPROVEMENTS PROJECT HSIPSL-5127(040)

**COVER SHEET** 

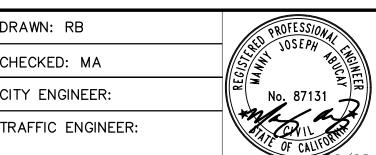



FEBRUARY 28, 2024 SHEET DATE: FEBRUARY 2024 SCALE: AS SHOWN 1 of 23

FILE NAME: 220082

BID SUBMITTAL

CALIFORNIA

a sanderson bellecci co.

### **ABBREVIATIONS:**

IRRIGATION

LINEAR FEET

LOW POINT

LEFT

	<del></del>		
λB	AGGREGATE BASE	МН	MANHOLE
ABDN	ABANDON	MISC	MISCELLANEOUS
AC	ASPHALT CONCRETE	MON	MONUMENT
AT&T	AMERICAN TELEPHONE & TELEGRAPH	N	NORTHING, NORTH
3C	BEGIN CURVE	NTS	NOT TO SCALE
3W	BACK OF WALK	OC	ON-CENTER
DDF	CONTROLLED DENSITY FILL	OH	OVERHEAD UTILITY LINE
OD. Cl	CAST IRON	PB	PACIFIC BELL
CL	CENTERLINE	PCC	PORTLAND CEMENT CONCRETE
CMP	CORRUGATED METAL PIPE	PG&E	PACIFIC GAS & ELECTRIC
CONC	CONCRETE	POC	POINT OF CONNECTION
CY	CUBIC YARD	PT	POINT
)  	DRAIN INLET	PVC	POLYVINYL CHLORIDE
)IFF	DIFFERENCE	R	RADIUS, RIGHT
)WY	DRIVEWAY	RC	RELATIVE COMPACTION
	ELECTRICAL, EASTING, EAST	RCP	REINFORCED CONCRETE PIPE
С	END CURVE	RT	RIGHT
LEC	ELECTRICAL	R/W	RIGHT OF WAY
P	EDGE OF PAVEMENT	S	SOUTH
X	EXISTING	SD	STORM DRAIN
DAC	FULL DEPTH ASPHALT CONCRETE	SDMH	STORM DRAIN MANHOLE
DC	FIRE DEPARTMENT CONNECTION	SDR	STANDARD DIMENSION RATIO
G	FINISH GRADE	SL	STATION LINE, STREET LIGHT
H	FIRE HYDRANT	SM	SURVEY MARKER
:L	FLOW LINE	SS	SANITARY SEWER
0	FIBER OPTICS	SSCO	SANITARY SEWER CLEANOUT
S	FIRE SERVICE	SSMH	SANITARY SEWER MANHOLE
W	FACE OF WALK	STA	STATION
3	GAS	STD	STANDARD
3B	GRADE BREAK	SW	SIDEWALK
IDPE	HIGH DENSITY POLYETHYLENE PIPE	TC	TOP OF CURB
<del>I</del> P	HIGH POINT	TEL	TELEPHONE, TELECOM
١V	HIGH VOLTAGE	TFL	THEORETICAL FLOW LINE
łYD	FIRE HYDRANT	TTC	THEORETICAL TOP OF CURB
NV	INVERT	TYP	TYPICAL
Ρ	IRON PIPE	VCP	VITRIFIED CLAY PIPE
	IDDICATION		MEST

WEST

WATER VALVE

W, WTR WATER

WV

## **GENERAL NOTES:**

- 1. ALL MATERIAL AND WORKMANSHIP SHALL FULLY CONFORM WITH THE SPECIFICATIONS, STANDARDS, AND ORDINANCES OF THE CITY OF PITTSBURG. STANDARD SPECIFICATIONS AND DETAILS ARE AVAILABLE IN THE OFFICE OF THE CITY ENGINEER.
- 2. THE ENGINEER SHALL BE NOTIFIED AT LEAST 24 HOURS IN ADVANCE OF ANY WORK.
- 3. IT SHALL BE THE CONTRACTOR'S RESPONSIBILITY TO DETERMINE THE EXISTENCE AND LOCATION OF ALL UTILITIES. THE UNDERGROUND CONTRACTOR SHALL NOTIFY UTILITY COMPANIES AT LEAST 48 HOURS IN ADVANCE OF CONSTRUCTION TO FIELD LOCATE UTILITIES. CONTACT UNDERGROUND SERVICE ALERT AT 800-227-2600.
- 4. THE CONTRACTOR SHALL BE HELD RESPONSIBLE FOR ANY FIELD CHANGES MADE WITHOUT WRITTEN AUTHORIZATION FROM THE CITY ENGINEER.
- 5. TRAFFIC CONTROL SHALL BE CONTRACTOR'S RESPONSIBILITY. ALL SIGNS AND TRAFFIC CONTROL DEVICES SHALL BE IN ACCORDANCE WITH THE LATEST EDITION OF THE CALIFORNIA MUTCD.
- 6. ALL EXISTING UTILITIES AND PRIVATE IMPROVEMENTS THAT BECOME DAMAGED DURING CONSTRUCTION SHALL BE COMPLETELY RESTORED TO THE SATISFACTION OF THE CITY ENGINEER, AT CONTRACTOR'S SOLE EXPENSE.
- 7. THE CONTRACTOR AGREES THAT, IN ACCORDANCE WITH GENERALLY ACCEPTED CONSTRUCTION PRACTICES, THE CONTRACTOR WILL BE REQUIRED TO ASSUME SOLE AND COMPLETE RESPONSIBILITY FOR JOB SITE CONDITIONS DURING THE COURSE OF CONSTRUCTION OF THE PROJECT, INCLUDING SAFETY OF ALL PERSONS AND PROPERTY AND THAT THIS REQUIREMENT SHALL BE MADE TO APPLY CONTINUOUSLY AND NOT JUST DURING NORMAL WORKING HOURS.
- 8. EXCAVATIONS SHALL BE ADEQUATELY SHORED, BRACED AND SHEETED SO THAT THE EARTH WILL NOT SLIDE OR SETTLE AND SO THAT ALL EXISTING IMPROVEMENTS OF ANY KIND WILL BE FULLY PROTECTED FROM DAMAGE. ANY DAMAGE RESULTING FROM A LACK OF ADEQUATE SHORING, BRACING OR SHEETING, SHALL BE THE RESPONSIBILITY OF THE CONTRACTOR AND SHALL MAKE NECESSARY REPAIRS OR RECONSTRUCTION AT CONTRACTOR OWN EXPENSE AND TO THE SATISFACTION OF THE CITY ENGINEER. WHERE THE EXCAVATION FOR A CONDUIT TRENCH, AND/OR STRUCTURE IS FIVE FEET OR MORE IN DEPTH, THE CONTRACTOR SHALL PROVIDE ADEQUATE SHEETING, SHORING AND BRACING OR EQUIVALENT METHOD, FOR THE PROTECTION OF LIFE, OR LIMB, WHICH SHALL CONFORM TO THE APPLICABLE CONSTRUCTION SAFETY ORDERS OF THE DIVISION OF INDUSTRIAL SAFETY OF THE STATE OF CALIFORNIA. THE CONTRACTOR SHALL ALWAYS COMPLY WITH OSHA REQUIREMENTS.
- 9. SHOULD IT APPEAR THAT THE WORK TO BE DONE, OR ANY MATTER RELATIVE THERETO, IS NOT SUFFICIENTLY DETAILED OR EXPLAINED ON THESE PLANS, THE CONTRACTOR SHALL CONTACT THE ENGINEER FOR SUCH FURTHER EXPLANATIONS AS MAY BE NECESSARY. EXISTING UTILITIES SHALL BE MAINTAINED IN SERVICE AND IN PLACE BY THE CONTRACTOR DURING CONSTRUCTION UNLESS OTHERWISE SHOWN. REFERENCES TO THE STATE STANDARD SPECIFICATIONS AND STANDARD PLANS REFER TO CURRENT EDITION.

10. ALL USA MARKING TO BE REMOVED AT END OF CONSTRUCTION.

Call Two Working Days Before You Dig!

BID SUBMIT FEBRUARY 28, 2024

DESCRIPTION City of Pittsburg Public Works Engineering Department 65 Civic Avenue Pittsburg, CA 94565 Tel: (925) 252-4930 http://www.ci.pittsburg.ca.us/

CRESTVIEW DRIVE SAFETY IMPROVEMENTS PROJECT HSIPSL-5127(040)

PITTSBURG

GENERAL NOTES


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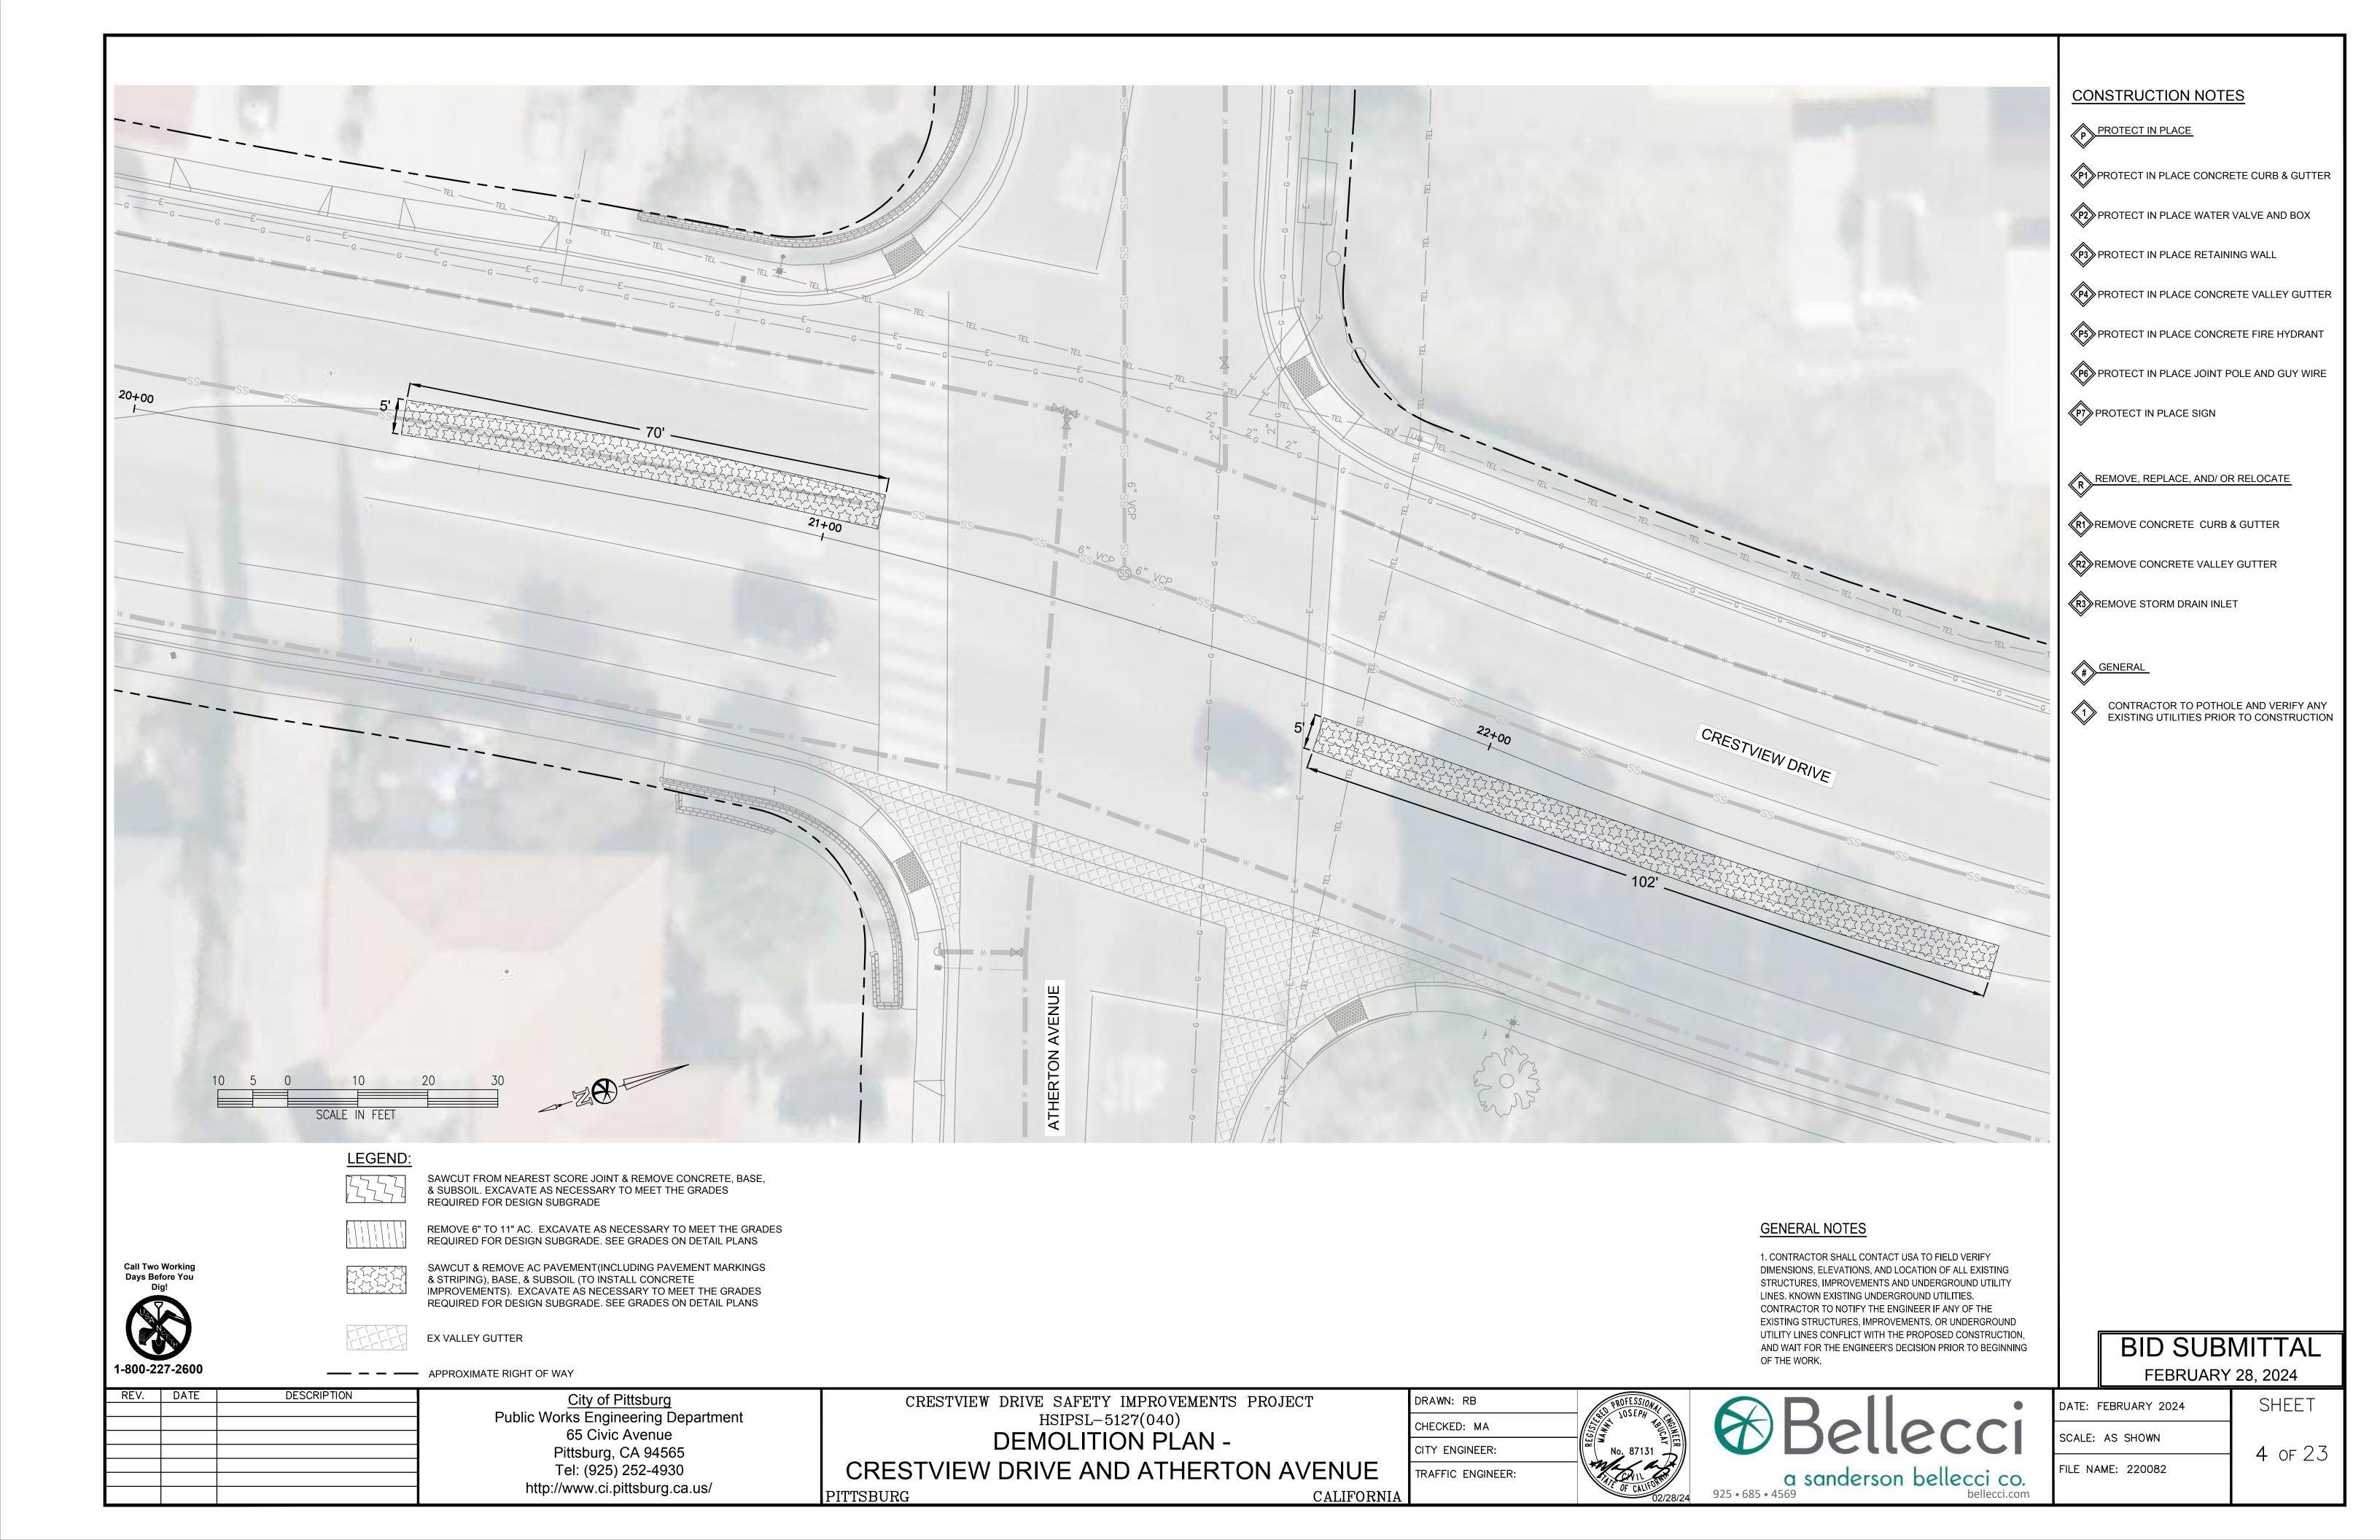



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DATE: I	FEBRUARY 2024	SHEET
SCALE:	AS SHOWN	2 OF 23


FILE NAME: 220082


CALIFORNIA



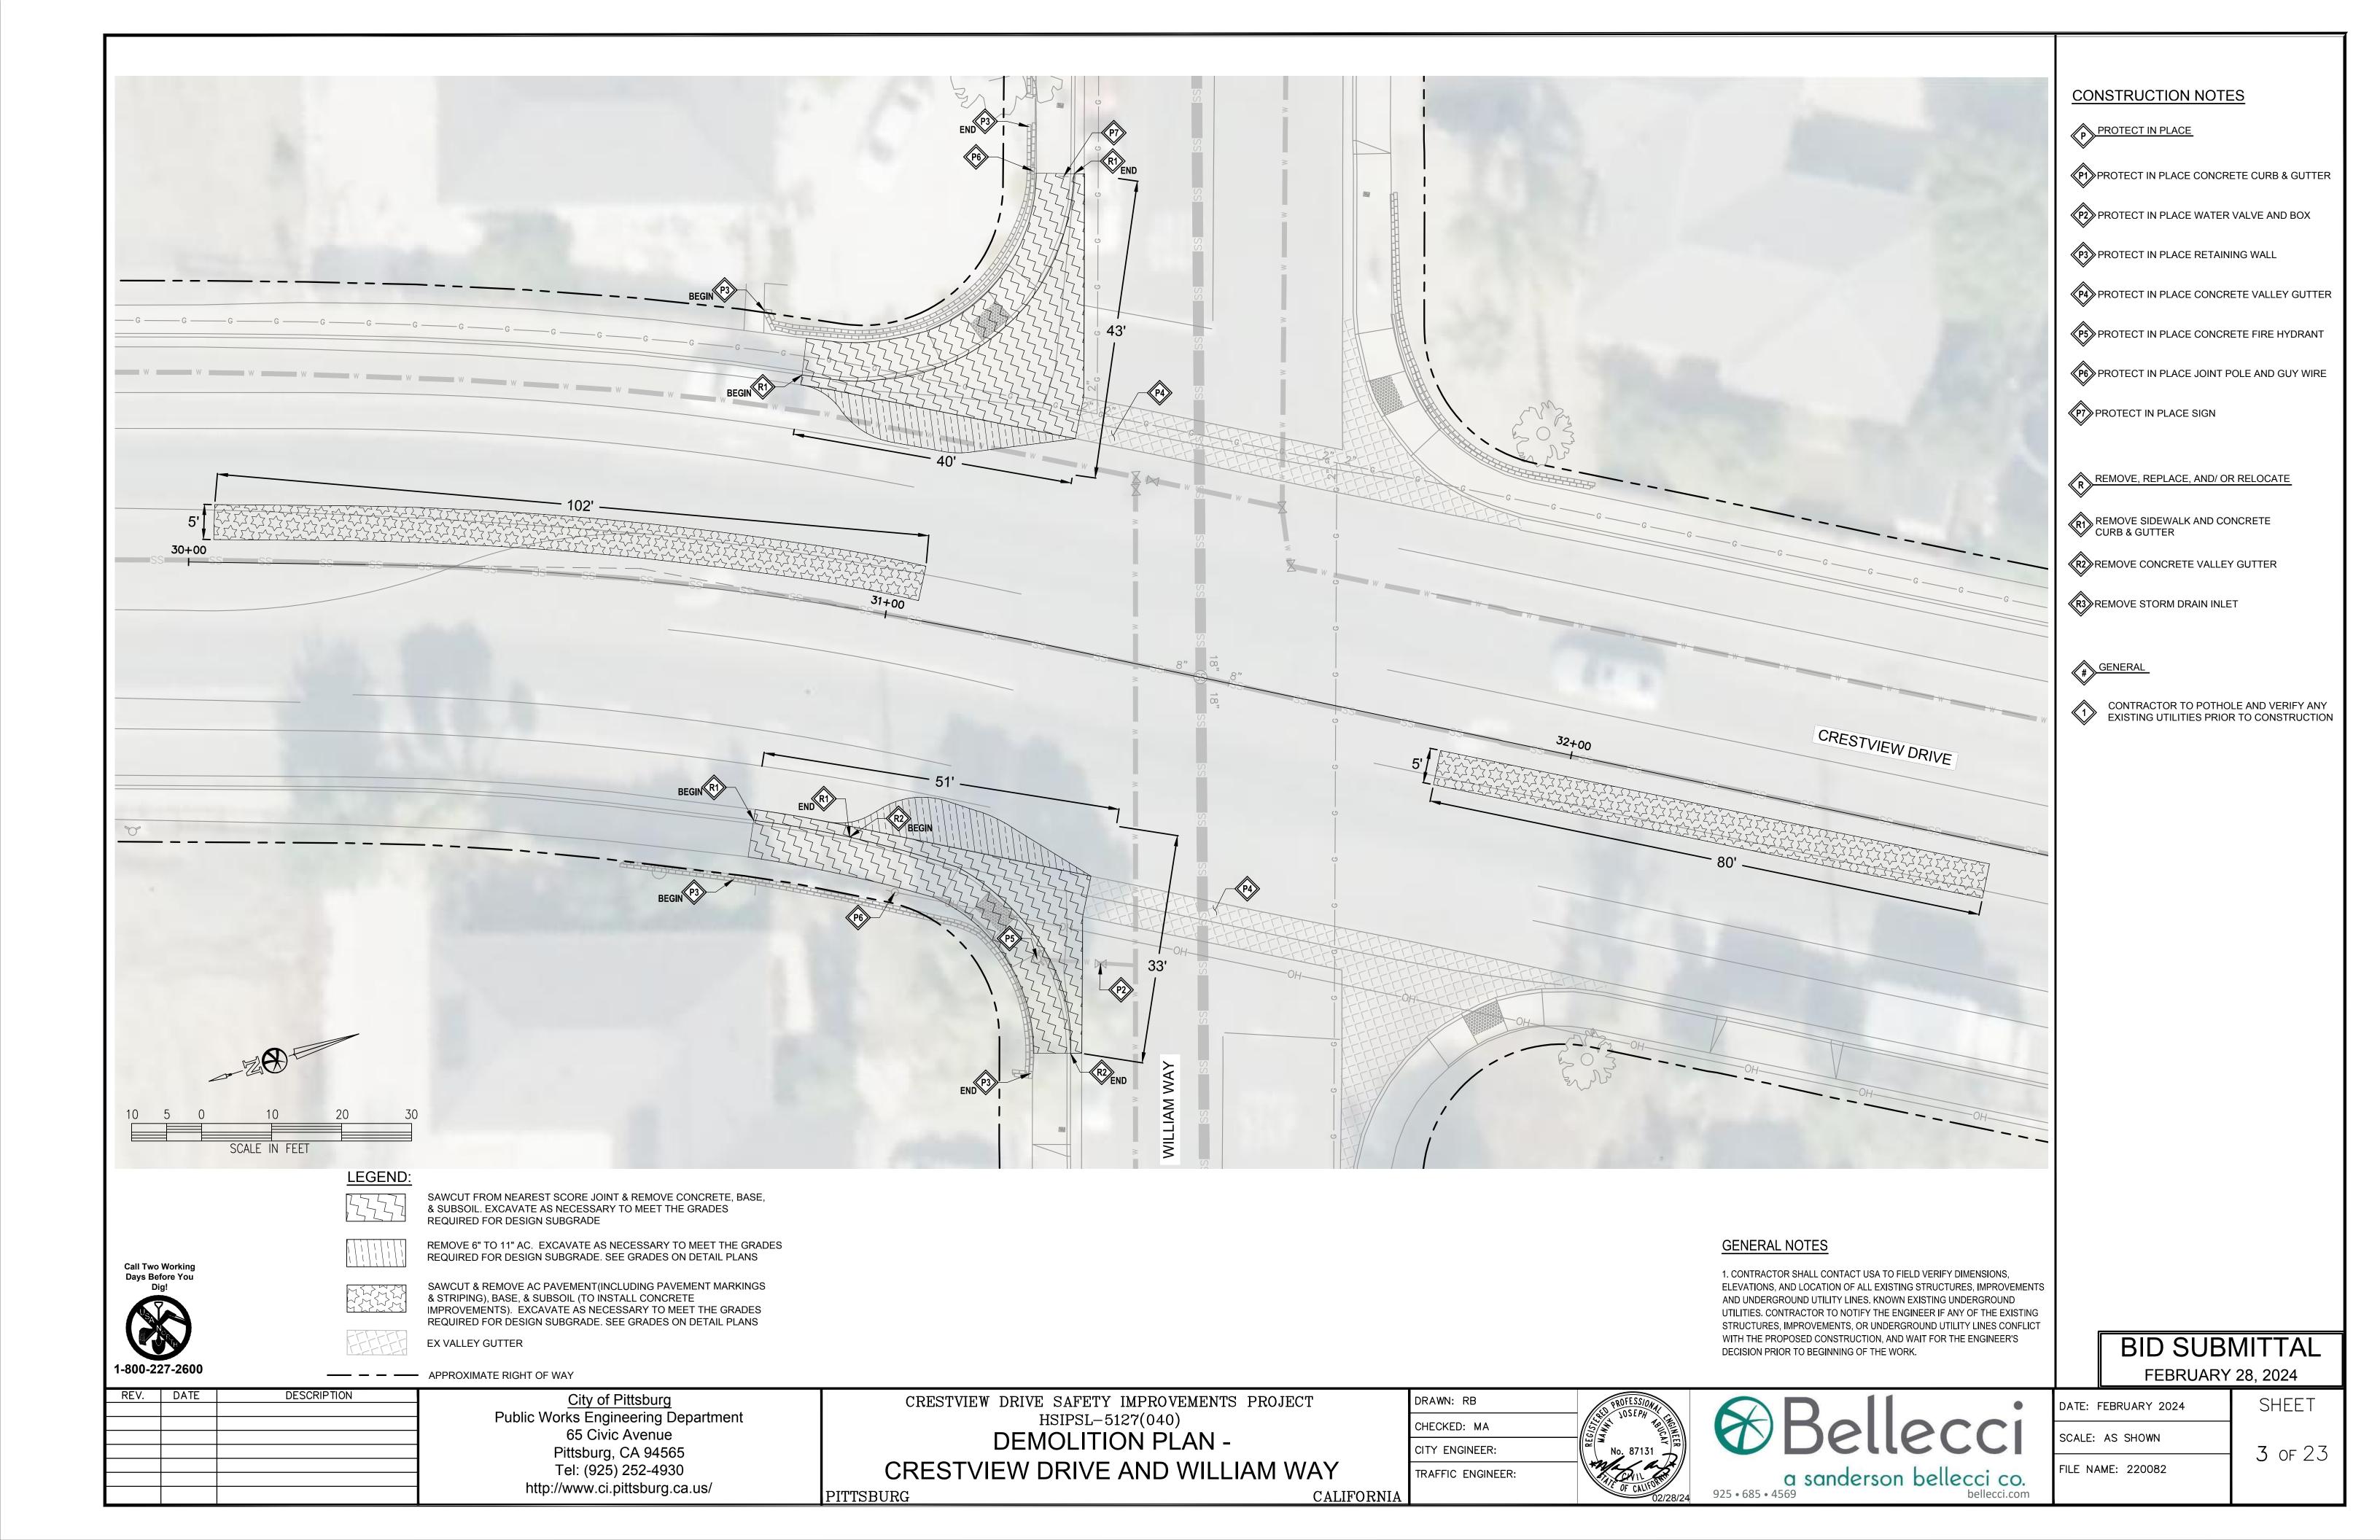

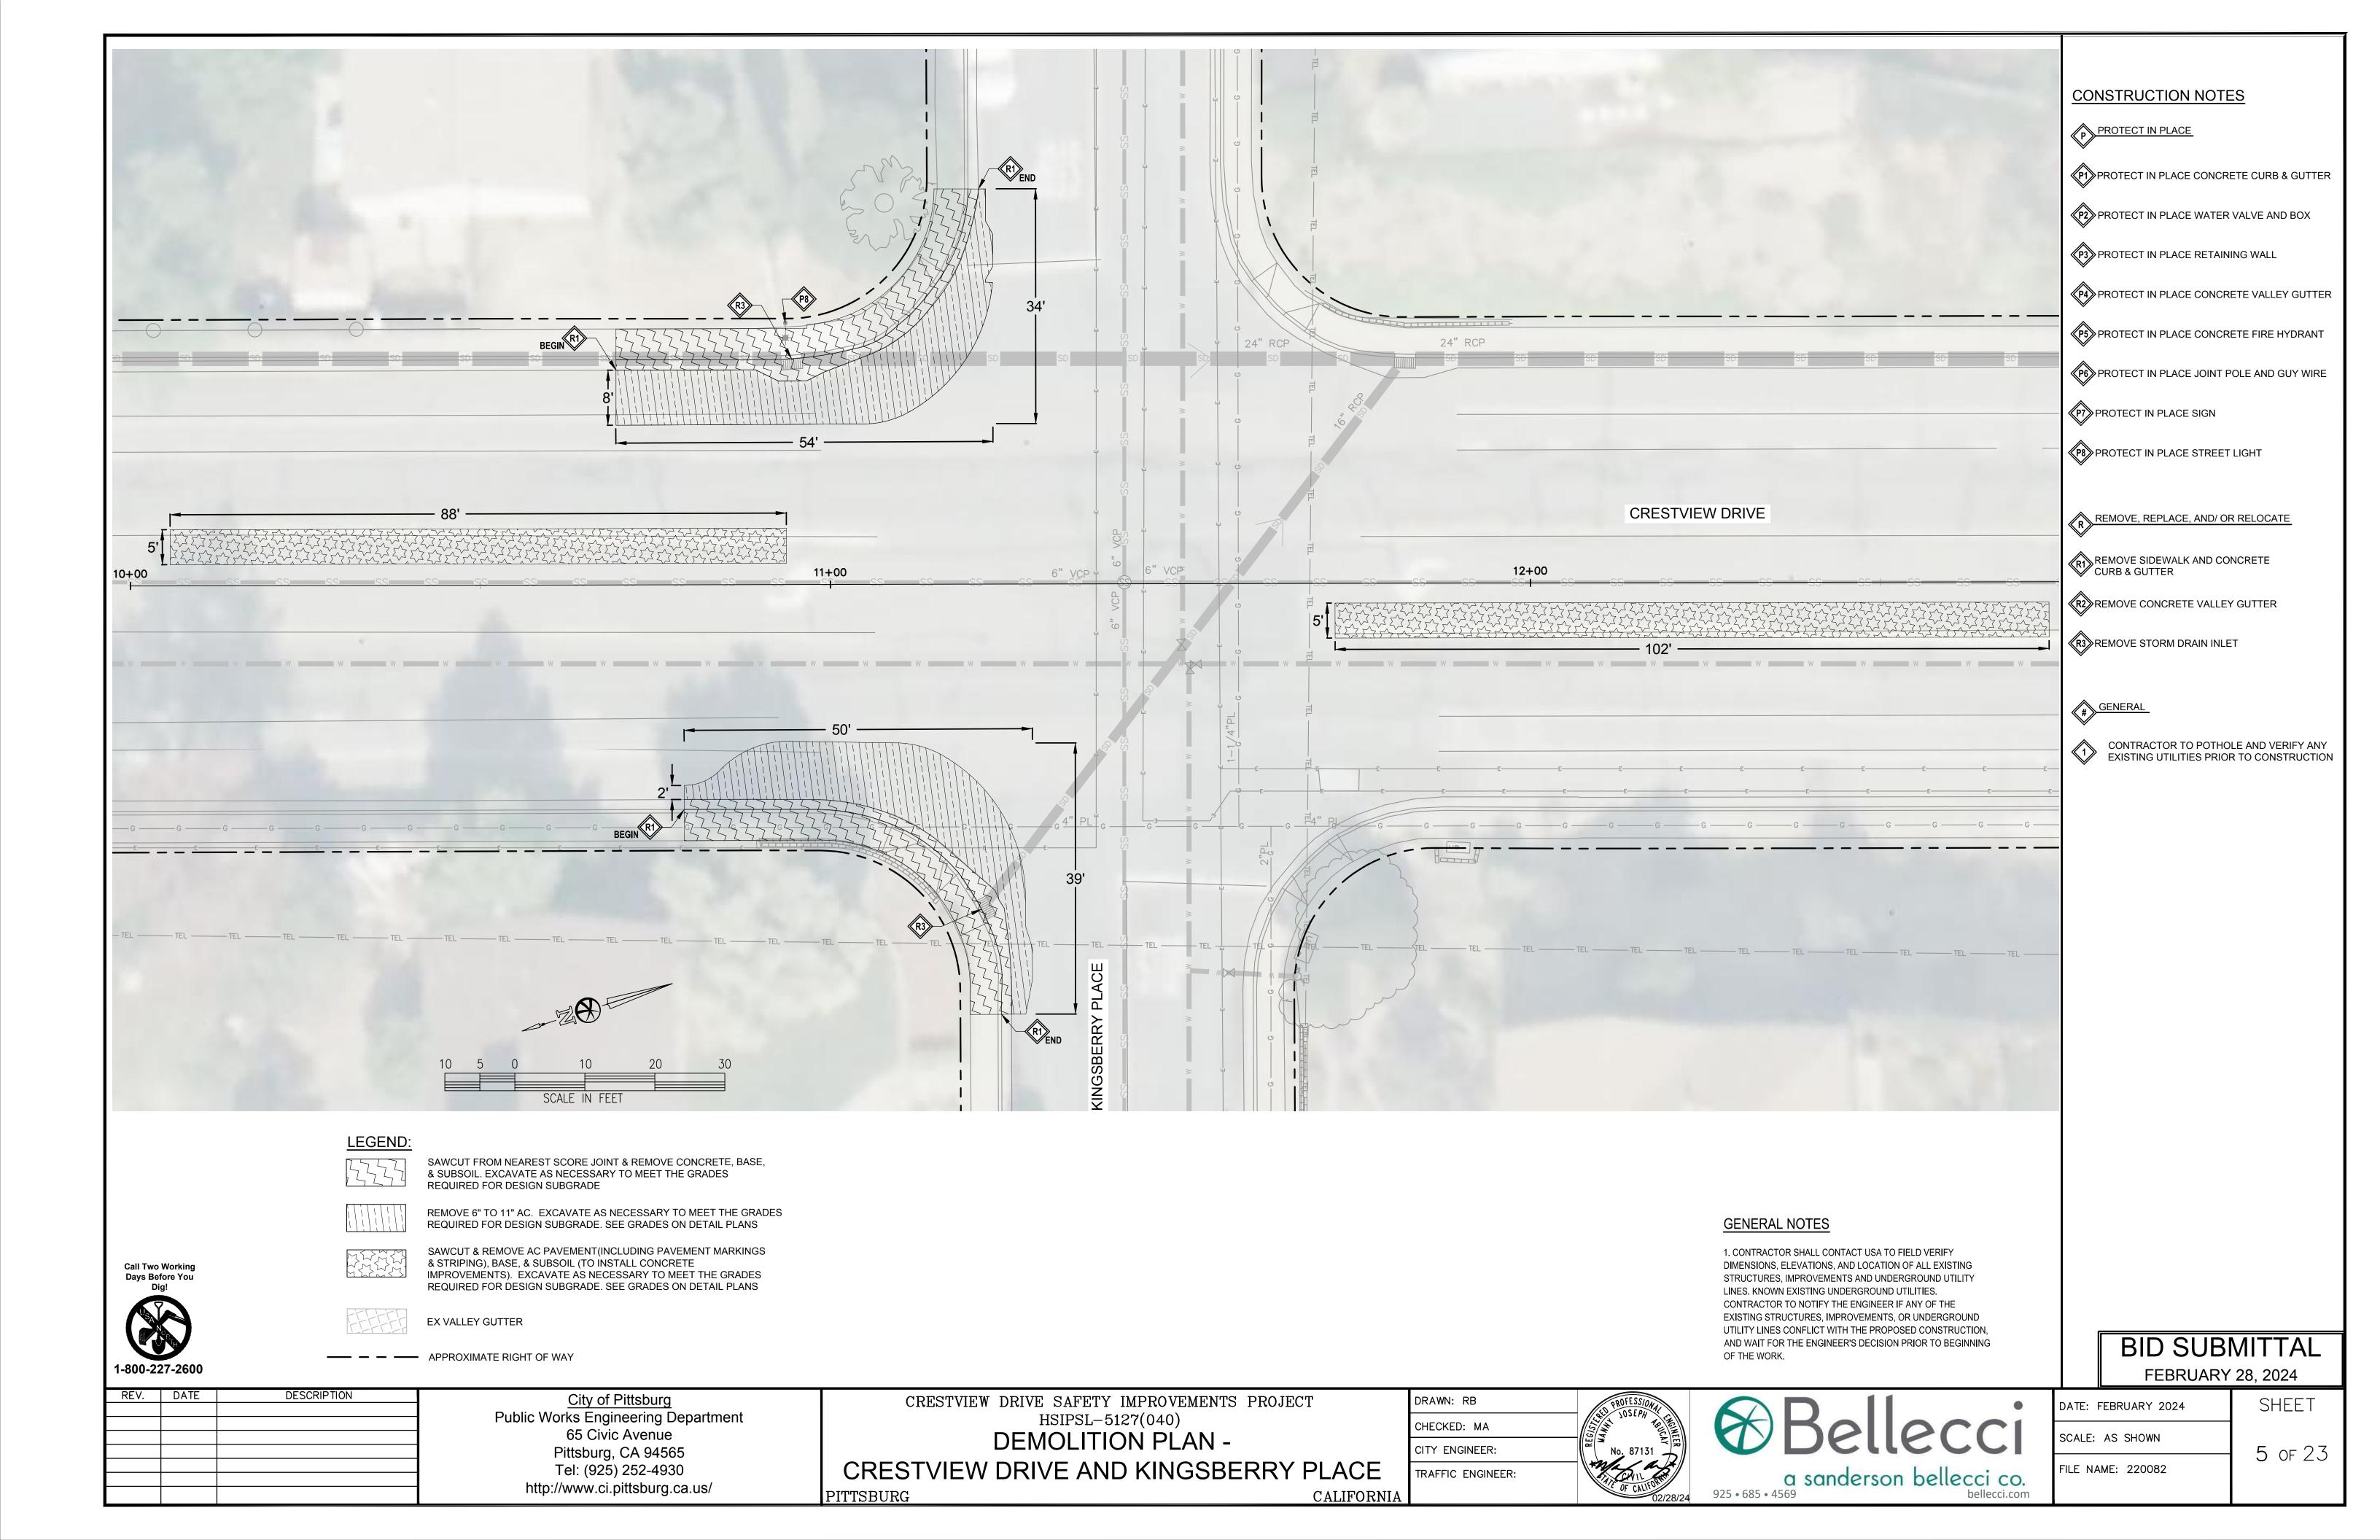

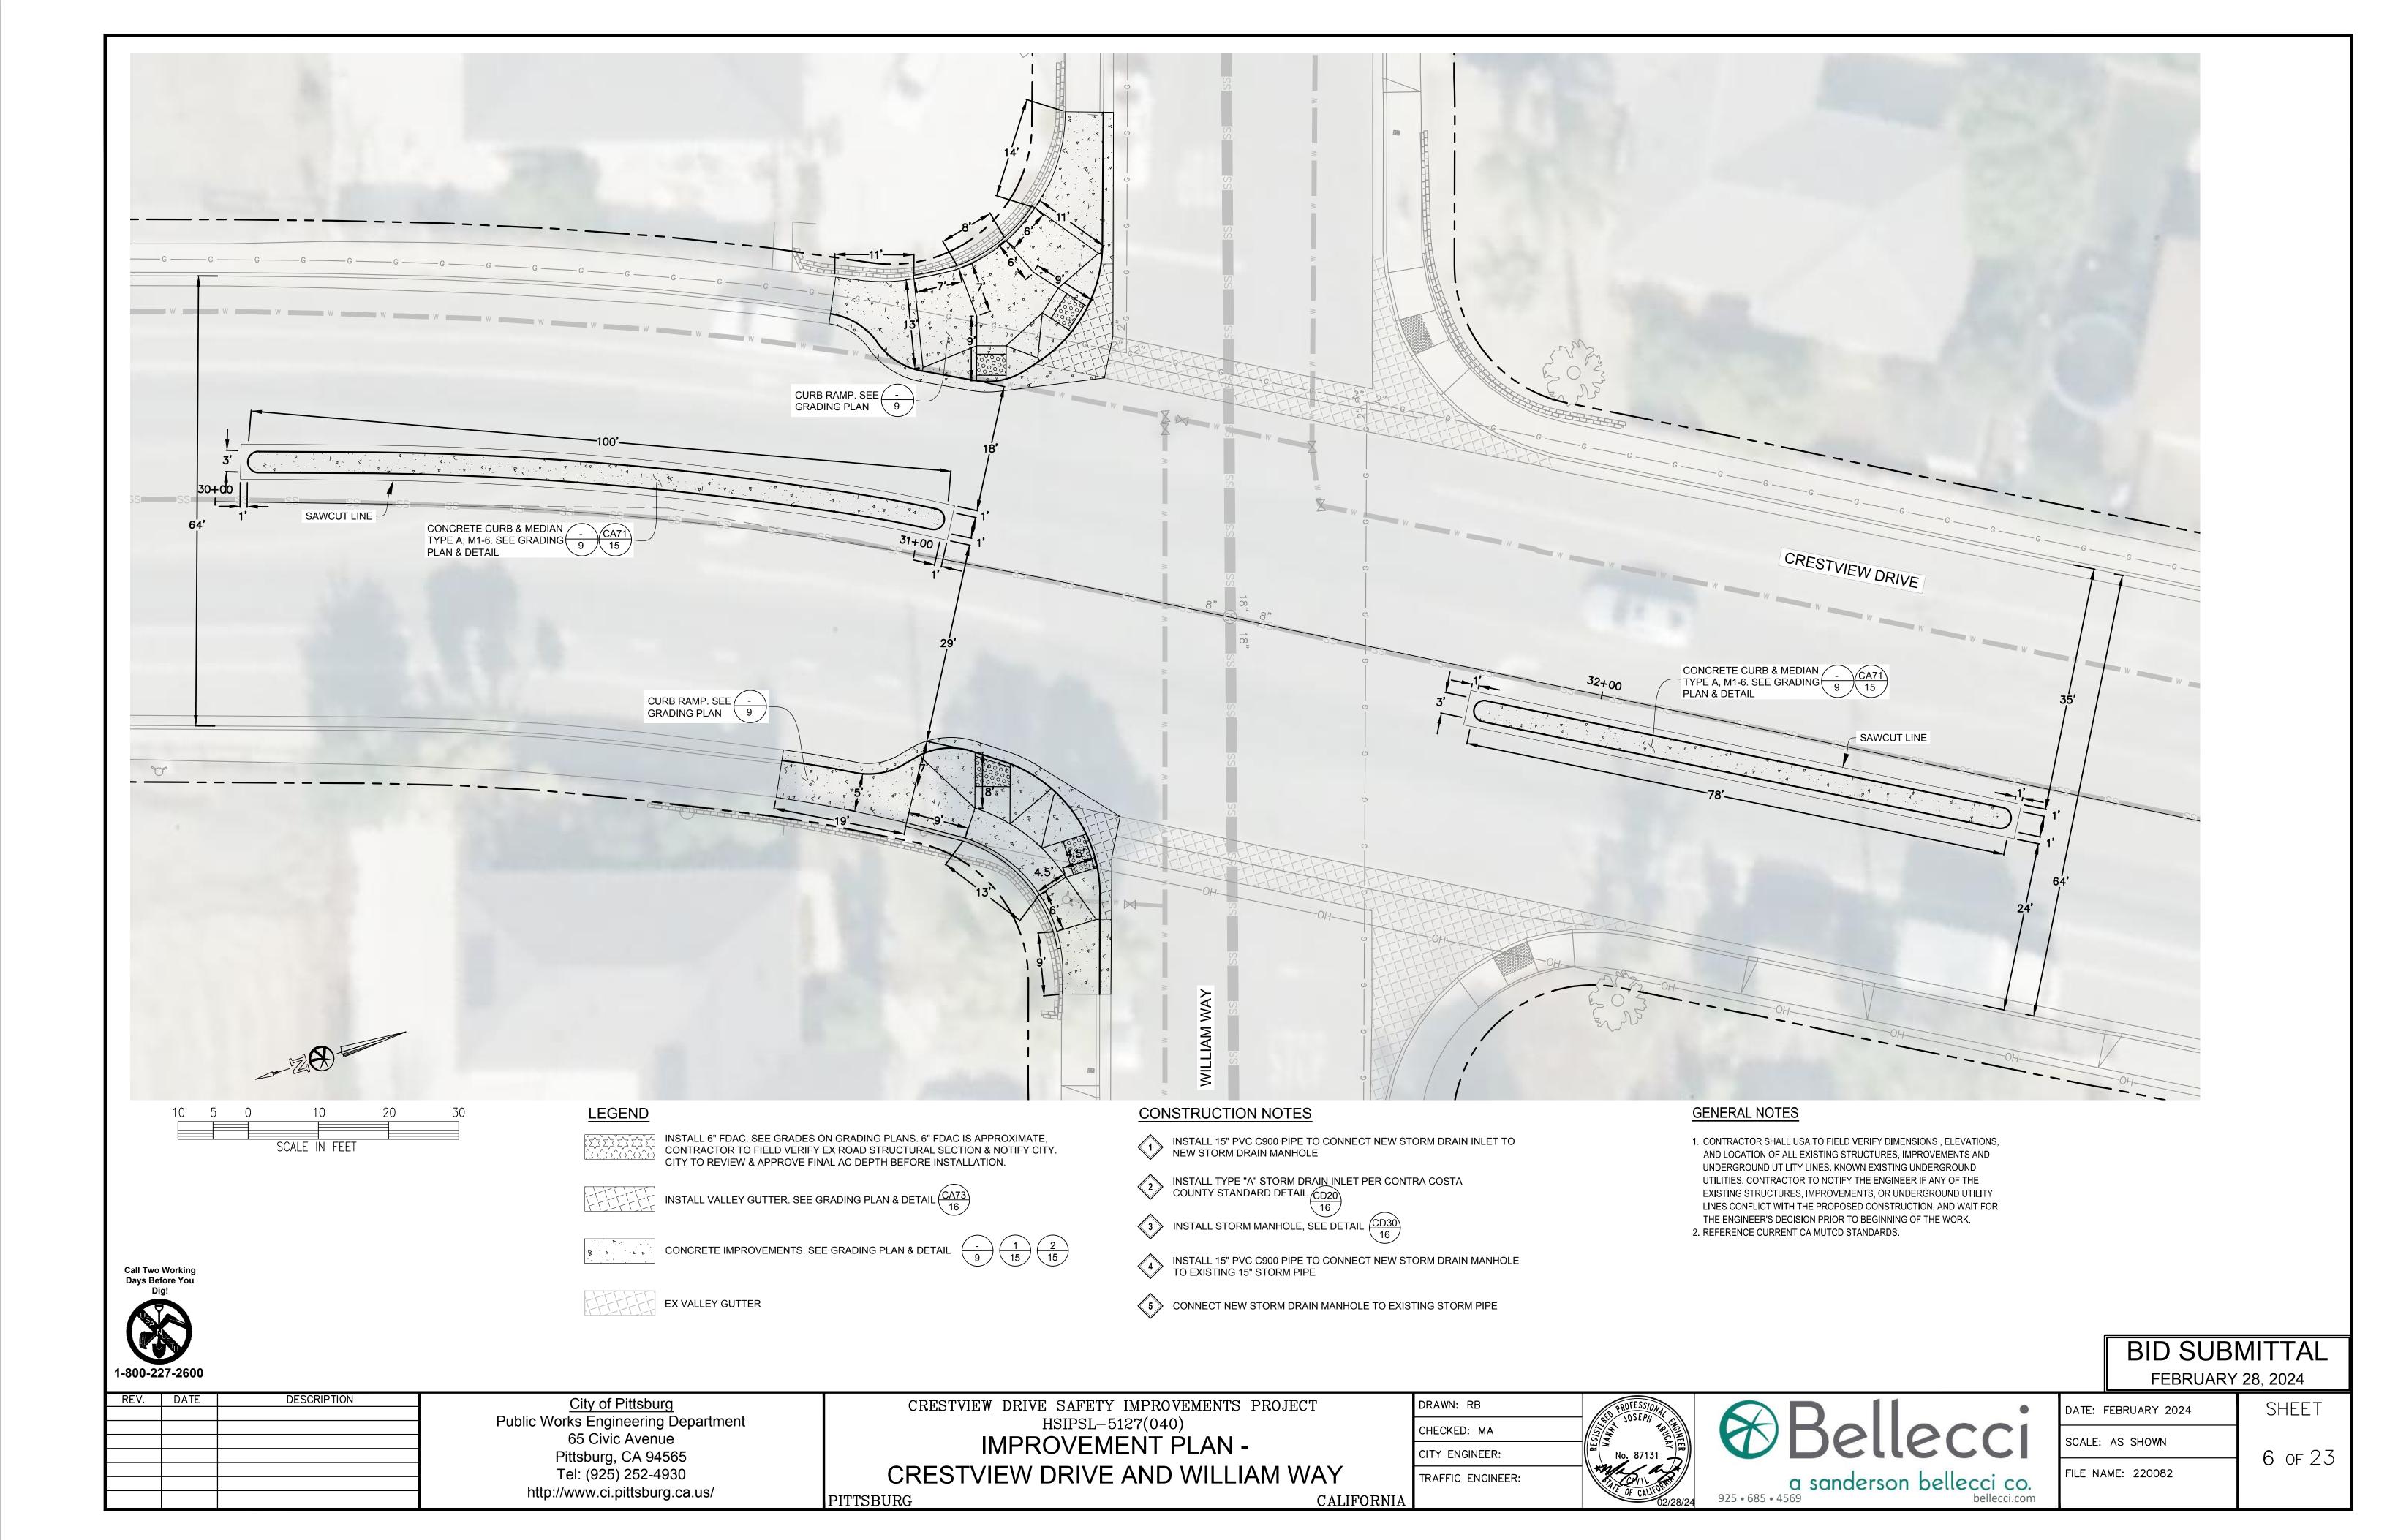

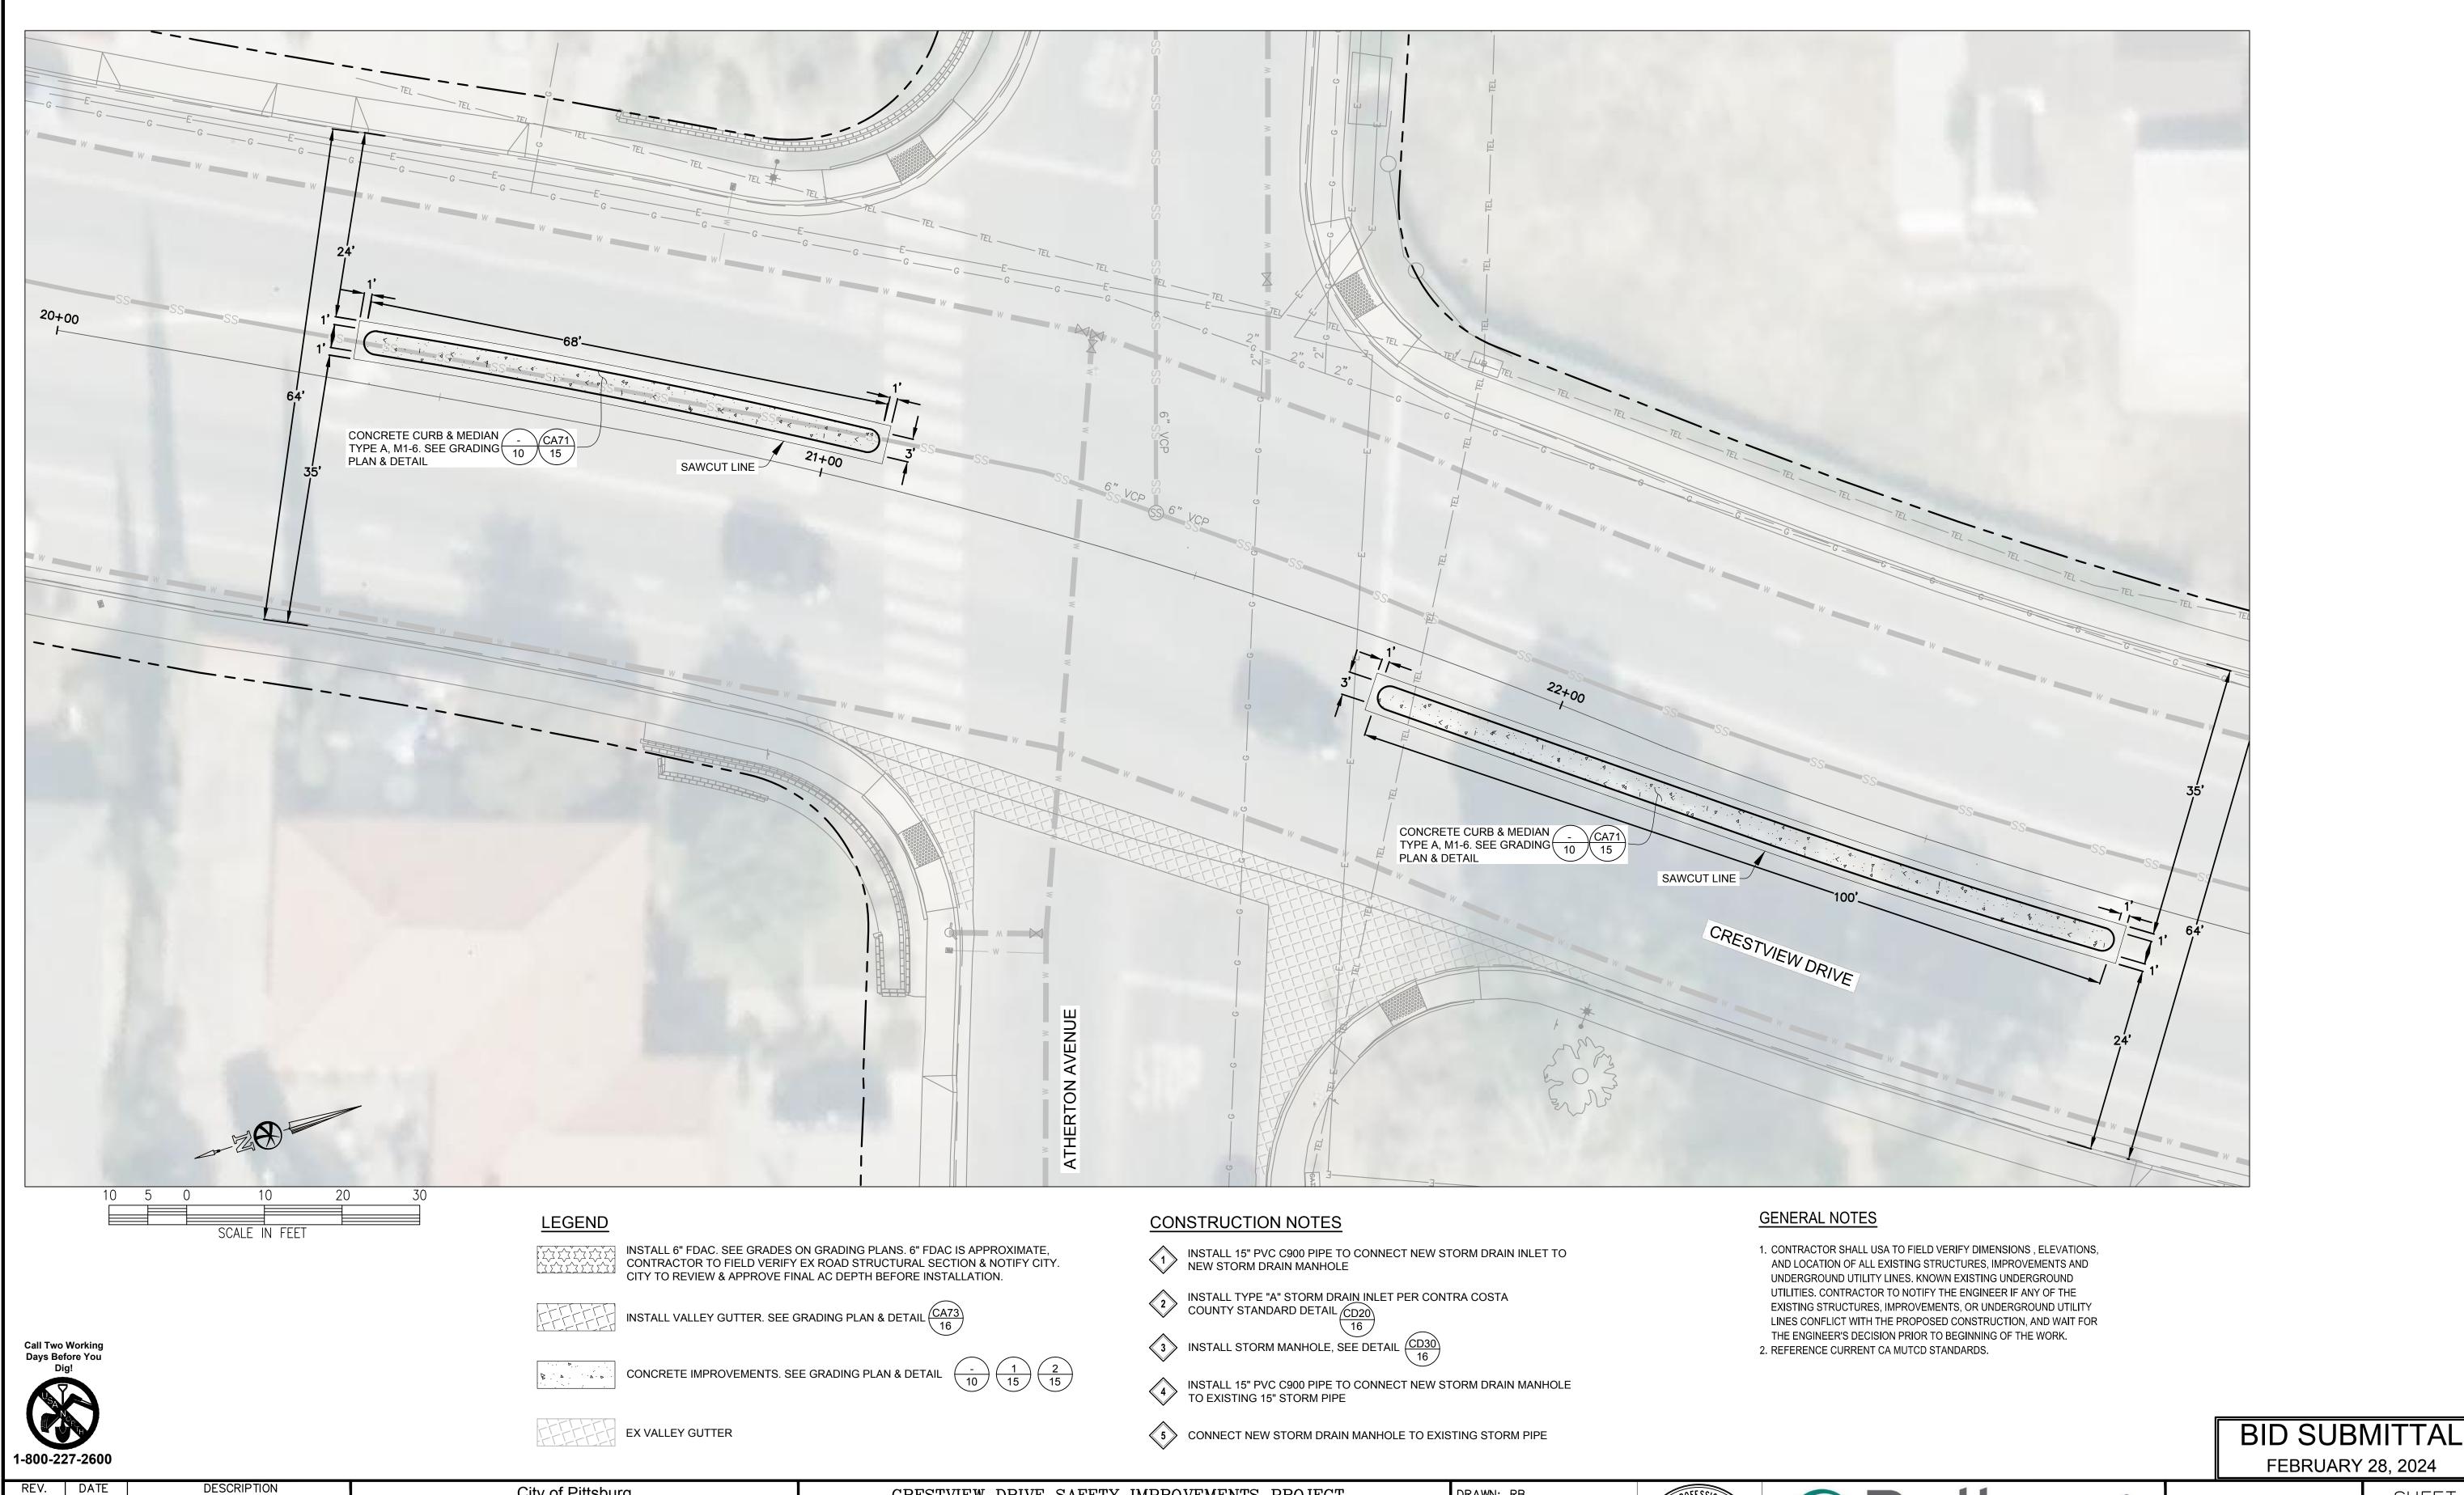


City of Pittsburg Public Works Engineering Department 65 Civic Avenue Pittsburg, CA 94565 Tel: (925) 252-4930

PITTSBURG

http://www.ci.pittsburg.ca.us/

CRESTVIEW DRIVE SAFETY IMPROVEMENTS PROJECT HSIPSL-5127(040) IMPROVEMENT PLAN -CRESTVIEW DRIVE AND ATHERTON AVENUE

DRAWN: RB CHECKED: MA CITY ENGINEER: TRAFFIC ENGINEER:

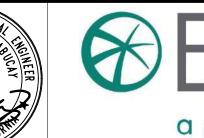





FEBRUARY 28, 2024 SHEET DATE: FEBRUARY 2024

SCALE: AS SHOWN FILE NAME: 220082

7 of 23

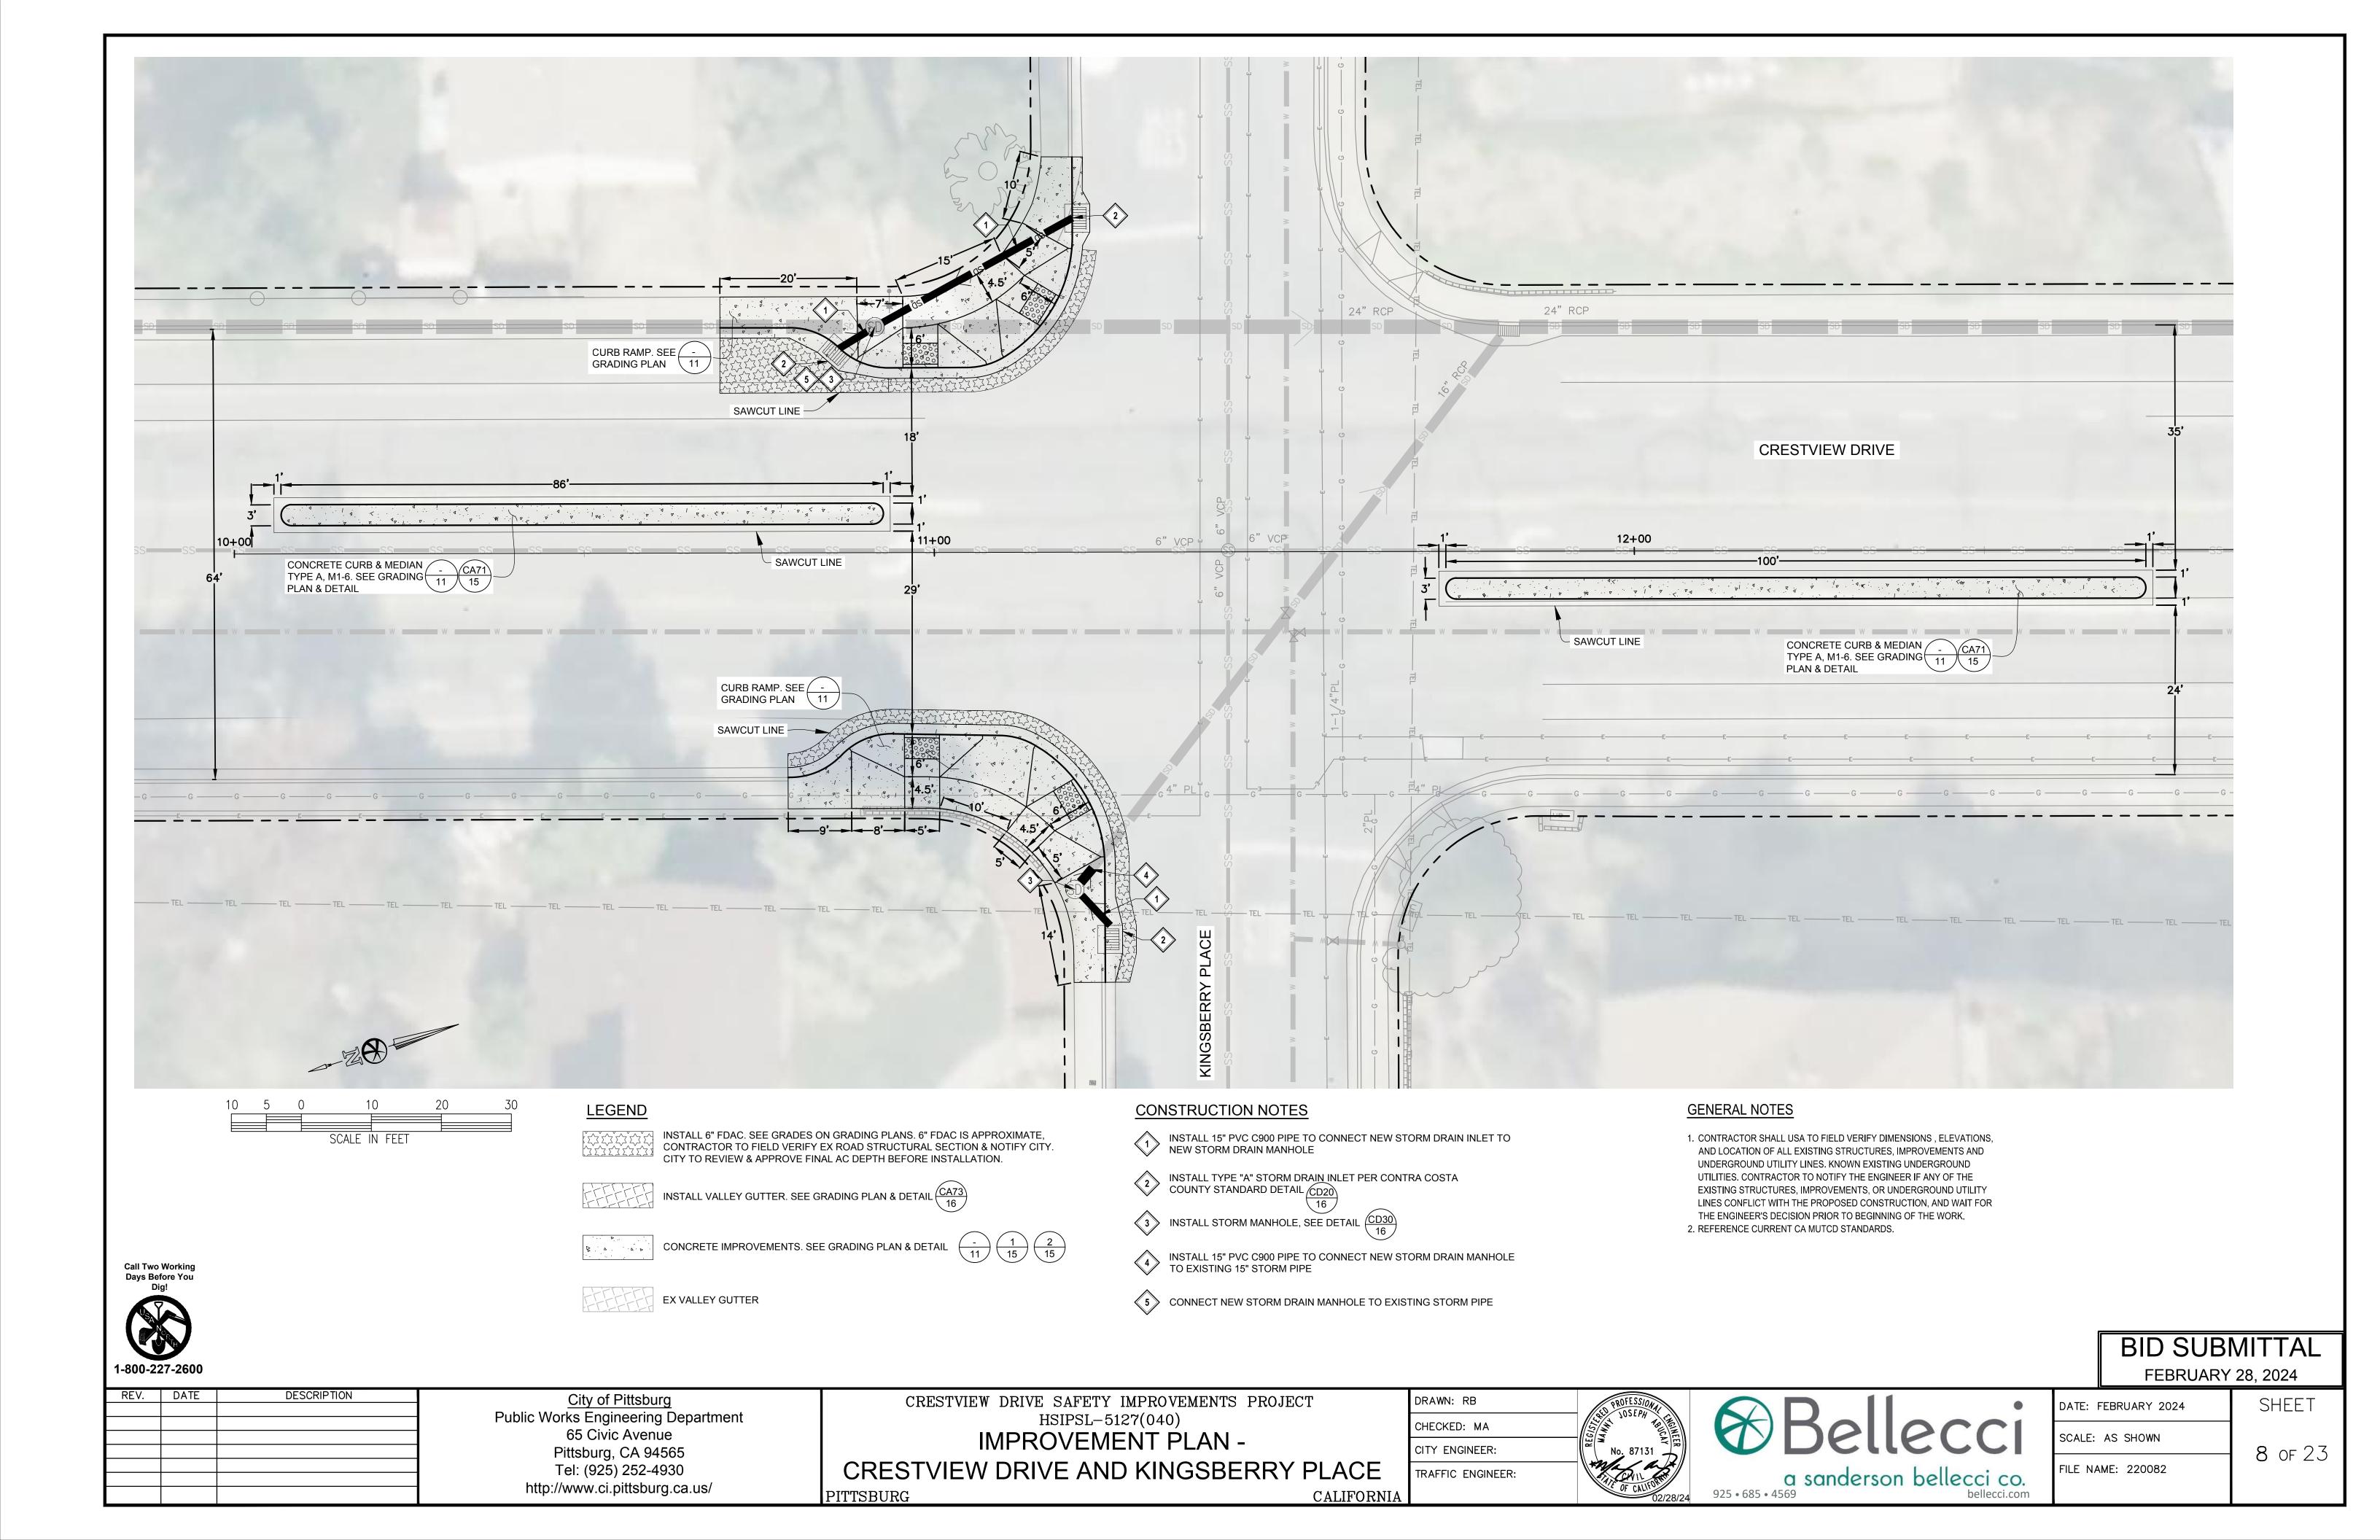

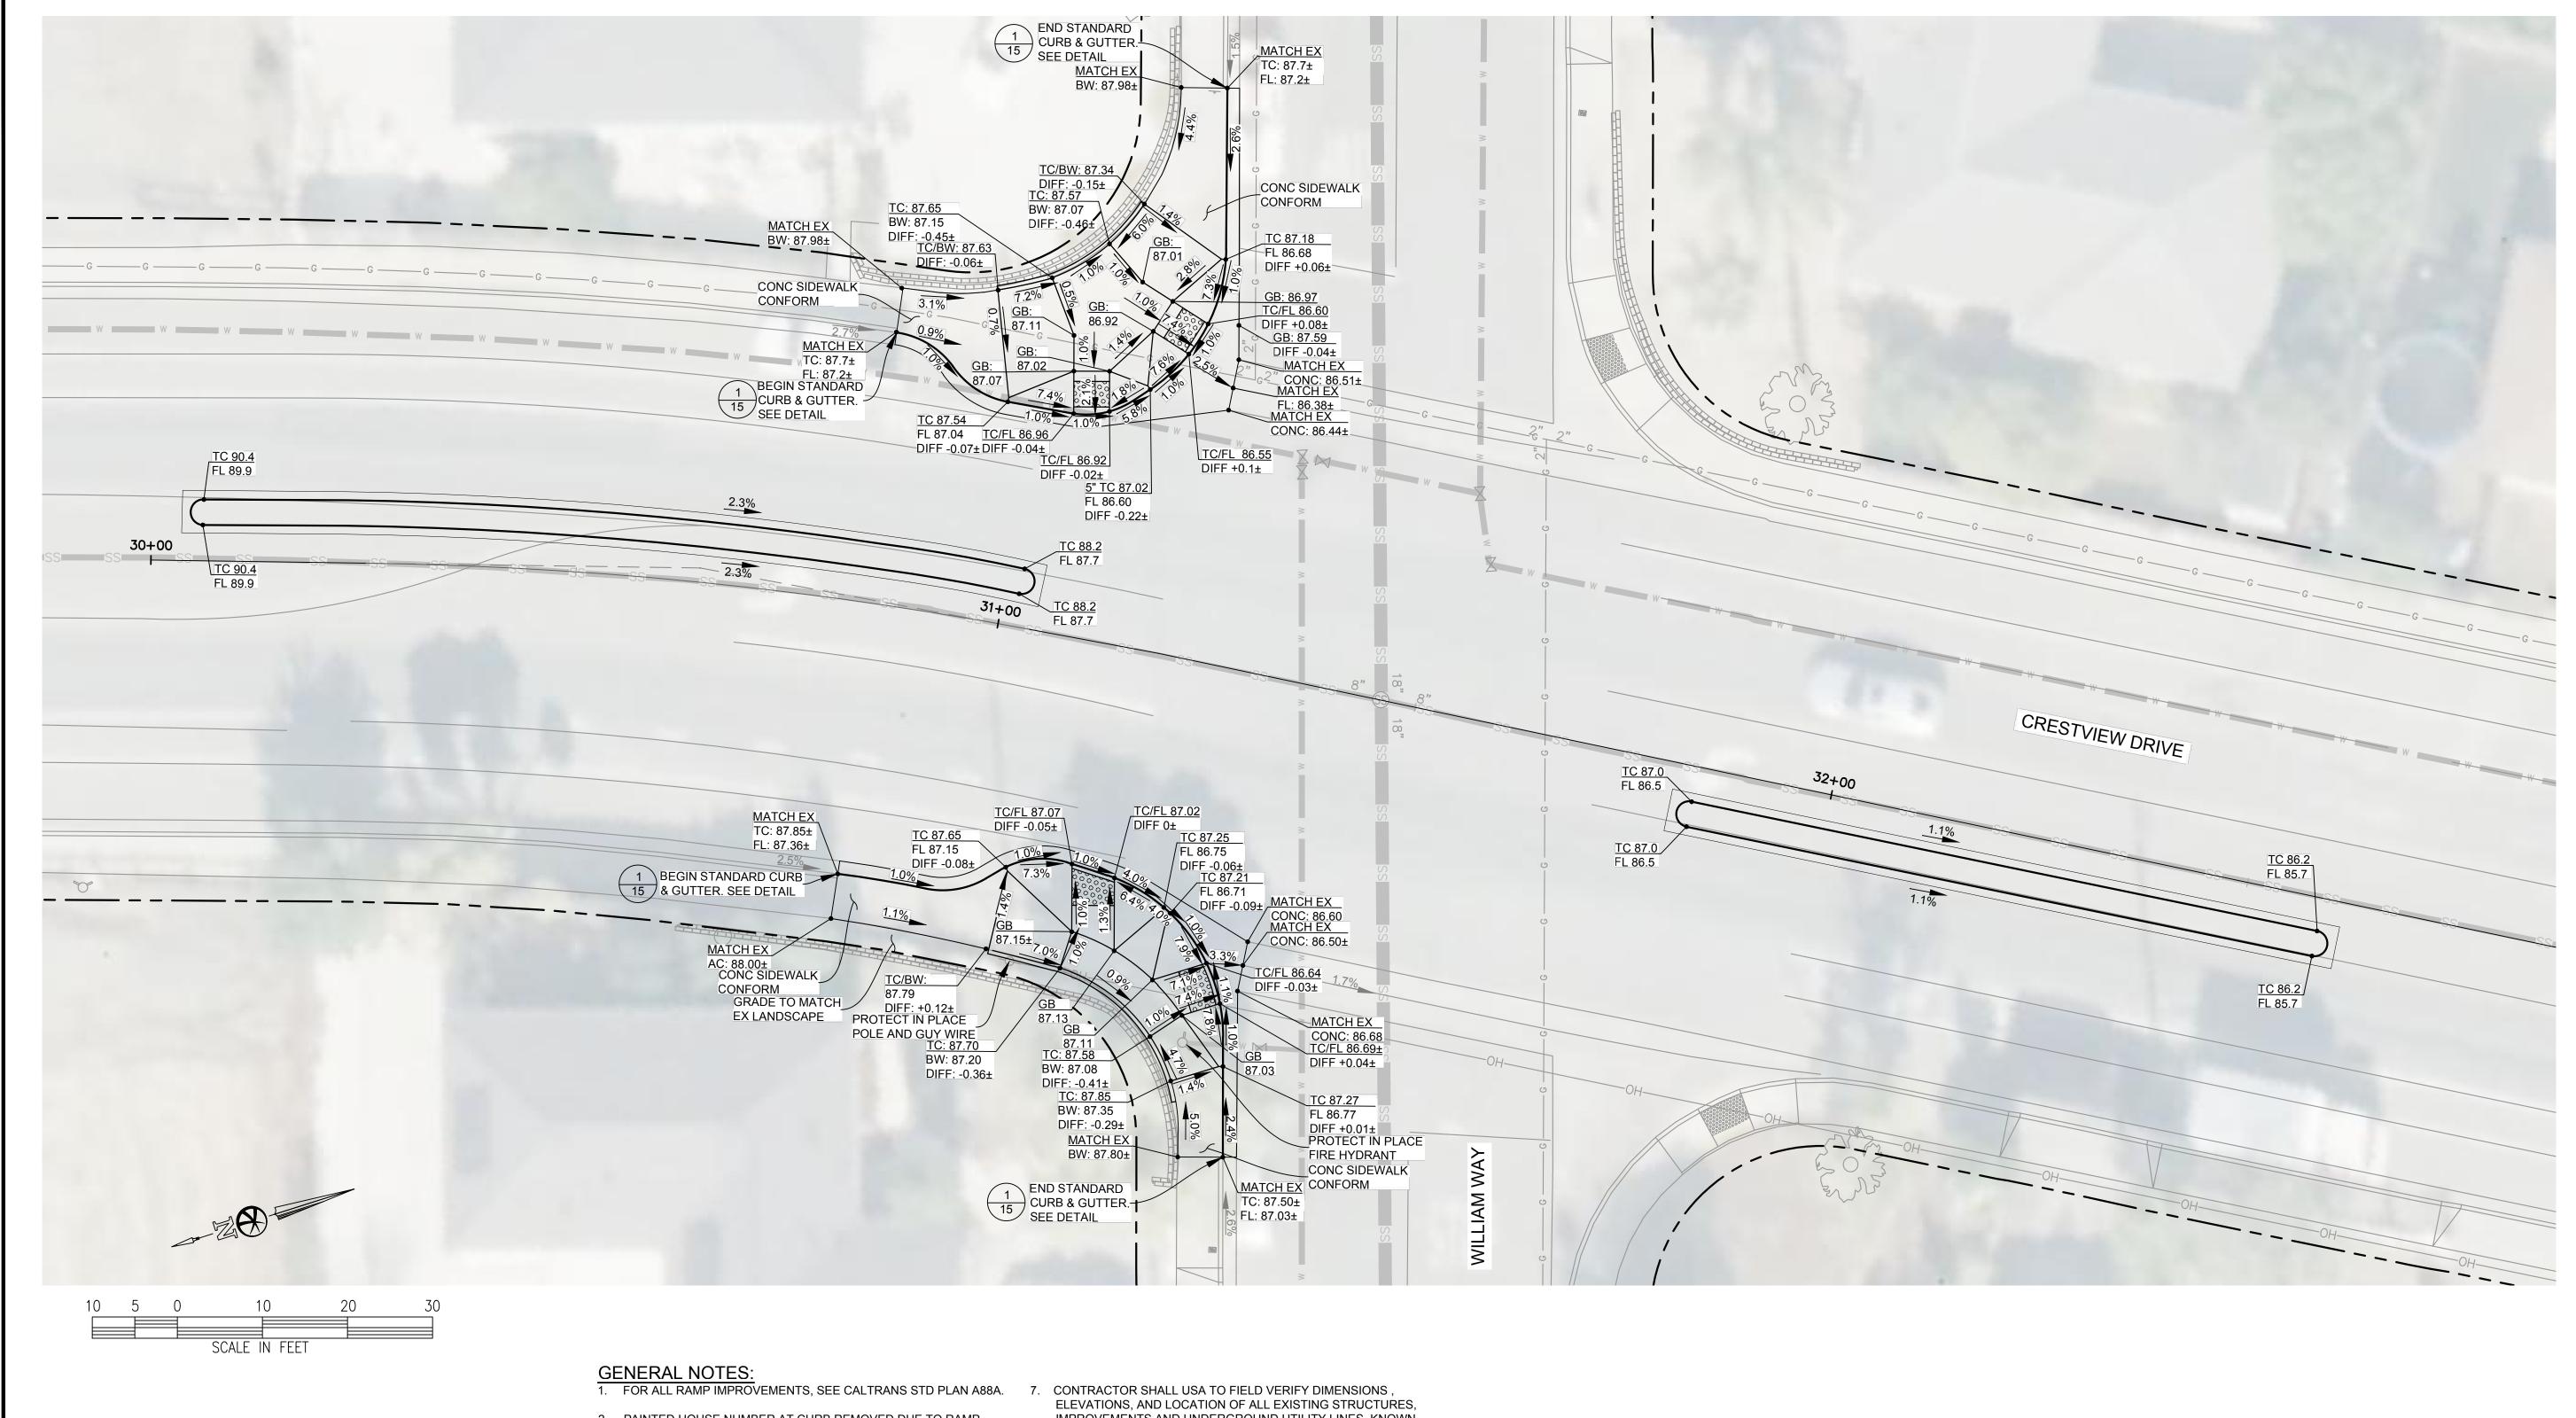

- 2. PAINTED HOUSE NUMBER AT CURB REMOVED DUE TO RAMP IMPROVEMENTS SHALL BE REPLACED.
- 3. FOR CURB & GUTTER DETAIL, SEE  $\frac{\text{CA71}}{13}$
- 4. FOR BULBOUT DETAILS, SEE SHEET 12

Call Two Working Days Before You


1-800-227-2600

- 5. AC PAVING IMPROVEMENTS SAWCUT & REMOVE/EXCAVATE EXISTING AC, BASE & SUBGRADE AS NECESSARY TO MEET THE GRADES REQUIRED FOR DESIGN SUBGRADE.
- 6. FOR NEW DRAIN INLET, SEE DETAIL  $\frac{\text{CD20}}{14}$
- 7. CONTRACTOR SHALL USA TO FIELD VERIFY DIMENSIONS, ELEVATIONS, AND LOCATION OF ALL EXISTING STRUCTURES, IMPROVEMENTS AND UNDERGROUND UTILITY LINES. KNOWN EXISTING UNDERGROUND UTILITIES. CONTRACTOR TO NOTIFY THE ENGINEER IF ANY OF THE EXISTING STRUCTURES, IMPROVEMENTS, OR UNDERGROUND UTILITY LINES CONFLICT WITH THE PROPOSED CONSTRUCTION, AND WAIT FOR THE ENGINEER'S DECISION PRIOR TO BEGINNING OF THE WORK.

## BID SUBMITTAL FEBRUARY 28, 2024

REV. DATE DESCRIPTION City of Pittsburg CRESTVIEW DRIVE SAFETY IMPROVEMENTS PROJECT DRAWN: RB SHEET DATE: FEBRUARY 2024 Public Works Engineering Department HSIPSL-5127(040)

GRADING PLAN -CHECKED: MA 65 Civic Avenue SCALE: AS SHOWN CITY ENGINEER: 9 of 23 Pittsburg, CA 94565 CRESTVIEW DRIVE AND WILLIAM WAY Tel: (925) 252-4930 FILE NAME: 220082 a sanderson bellecci co. TRAFFIC ENGINEER: http://www.ci.pittsburg.ca.us/ PITTSBURG CALIFORNIA

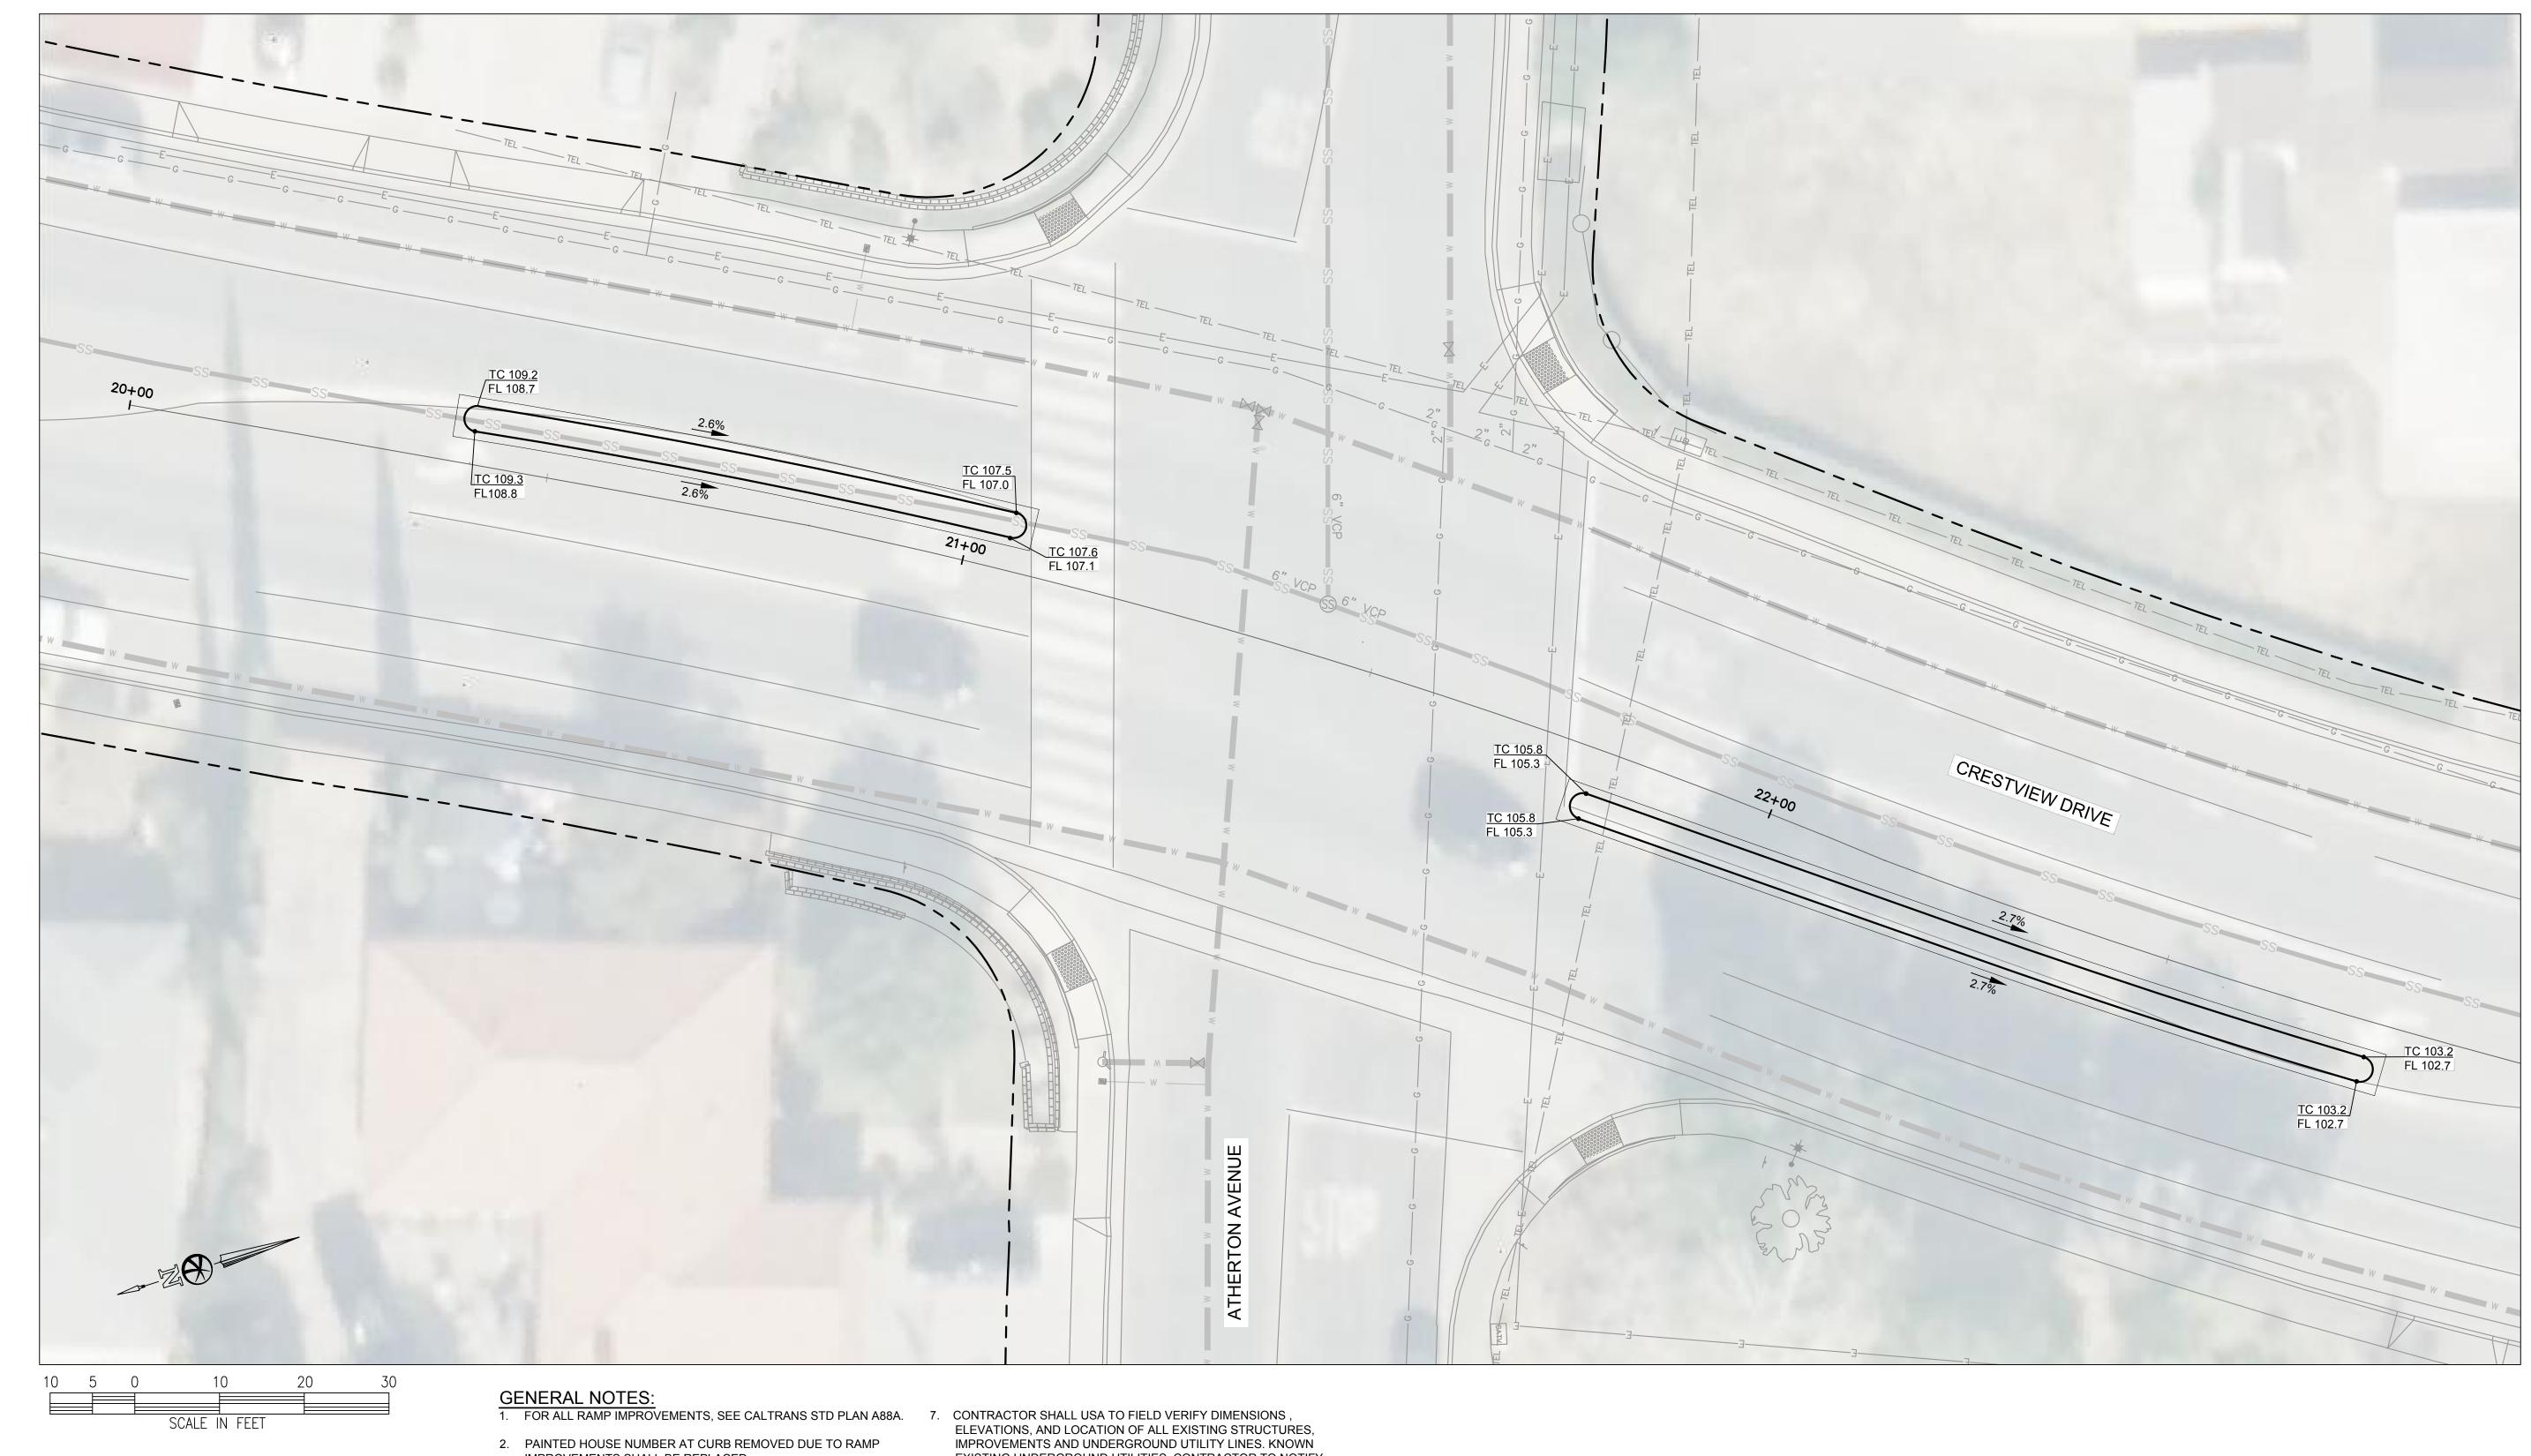



1-800-227-2600

2. PAINTED HOUSE NUMBER AT CURB REMOVED DUE TO RAMP IMPROVEMENTS SHALL BE REPLACED.

3. FOR CURB & GUTTER DETAIL, SEE  $\left(\begin{array}{c} 1\\ 15 \end{array}\right)$ 

4. FOR BULBOUT DETAILS, SEE SHEET 13

5. AC PAVING IMPROVEMENTS - SAWCUT & REMOVE/EXCAVATE EXISTING AC, BASE & SUBGRADE AS NECESSARY TO MEET THE GRADES REQUIRED FOR DESIGN SUBGRADE.


EXISTING UNDERGROUND UTILITIES. CONTRACTOR TO NOTIFY THE ENGINEER IF ANY OF THE EXISTING STRUCTURES, IMPROVEMENTS, OR UNDERGROUND UTILITY LINES CONFLICT WITH THE PROPOSED CONSTRUCTION, AND WAIT FOR THE ENGINEER'S DECISION PRIOR TO BEGINNING OF THE WORK.


6. FOR NEW DRAIN INLET, SEE DETAIL (CD20)


**BID SUBMITTAL** FEBRUARY 28, 2024

REV. DATE DESCRIPTION CRESTVIEW DRIVE SAFETY IMPROVEMENTS PROJECT City of Pittsburg DRAWN: RB SHEET DATE: FEBRUARY 2024 Public Works Engineering Department 65 Civic Avenue HSIPSL-5127(040)

GRADING PLAN -CHECKED: MA SCALE: AS SHOWN Pittsburg, CA 94565 Tel: (925) 252-4930 CITY ENGINEER: **10** of 23 a sanderson bellecci co. CRESTVIEW DRIVE AND ATHERTON AVENUE FILE NAME: 220082 TRAFFIC ENGINEER: http://www.ci.pittsburg.ca.us/ PITTSBURG

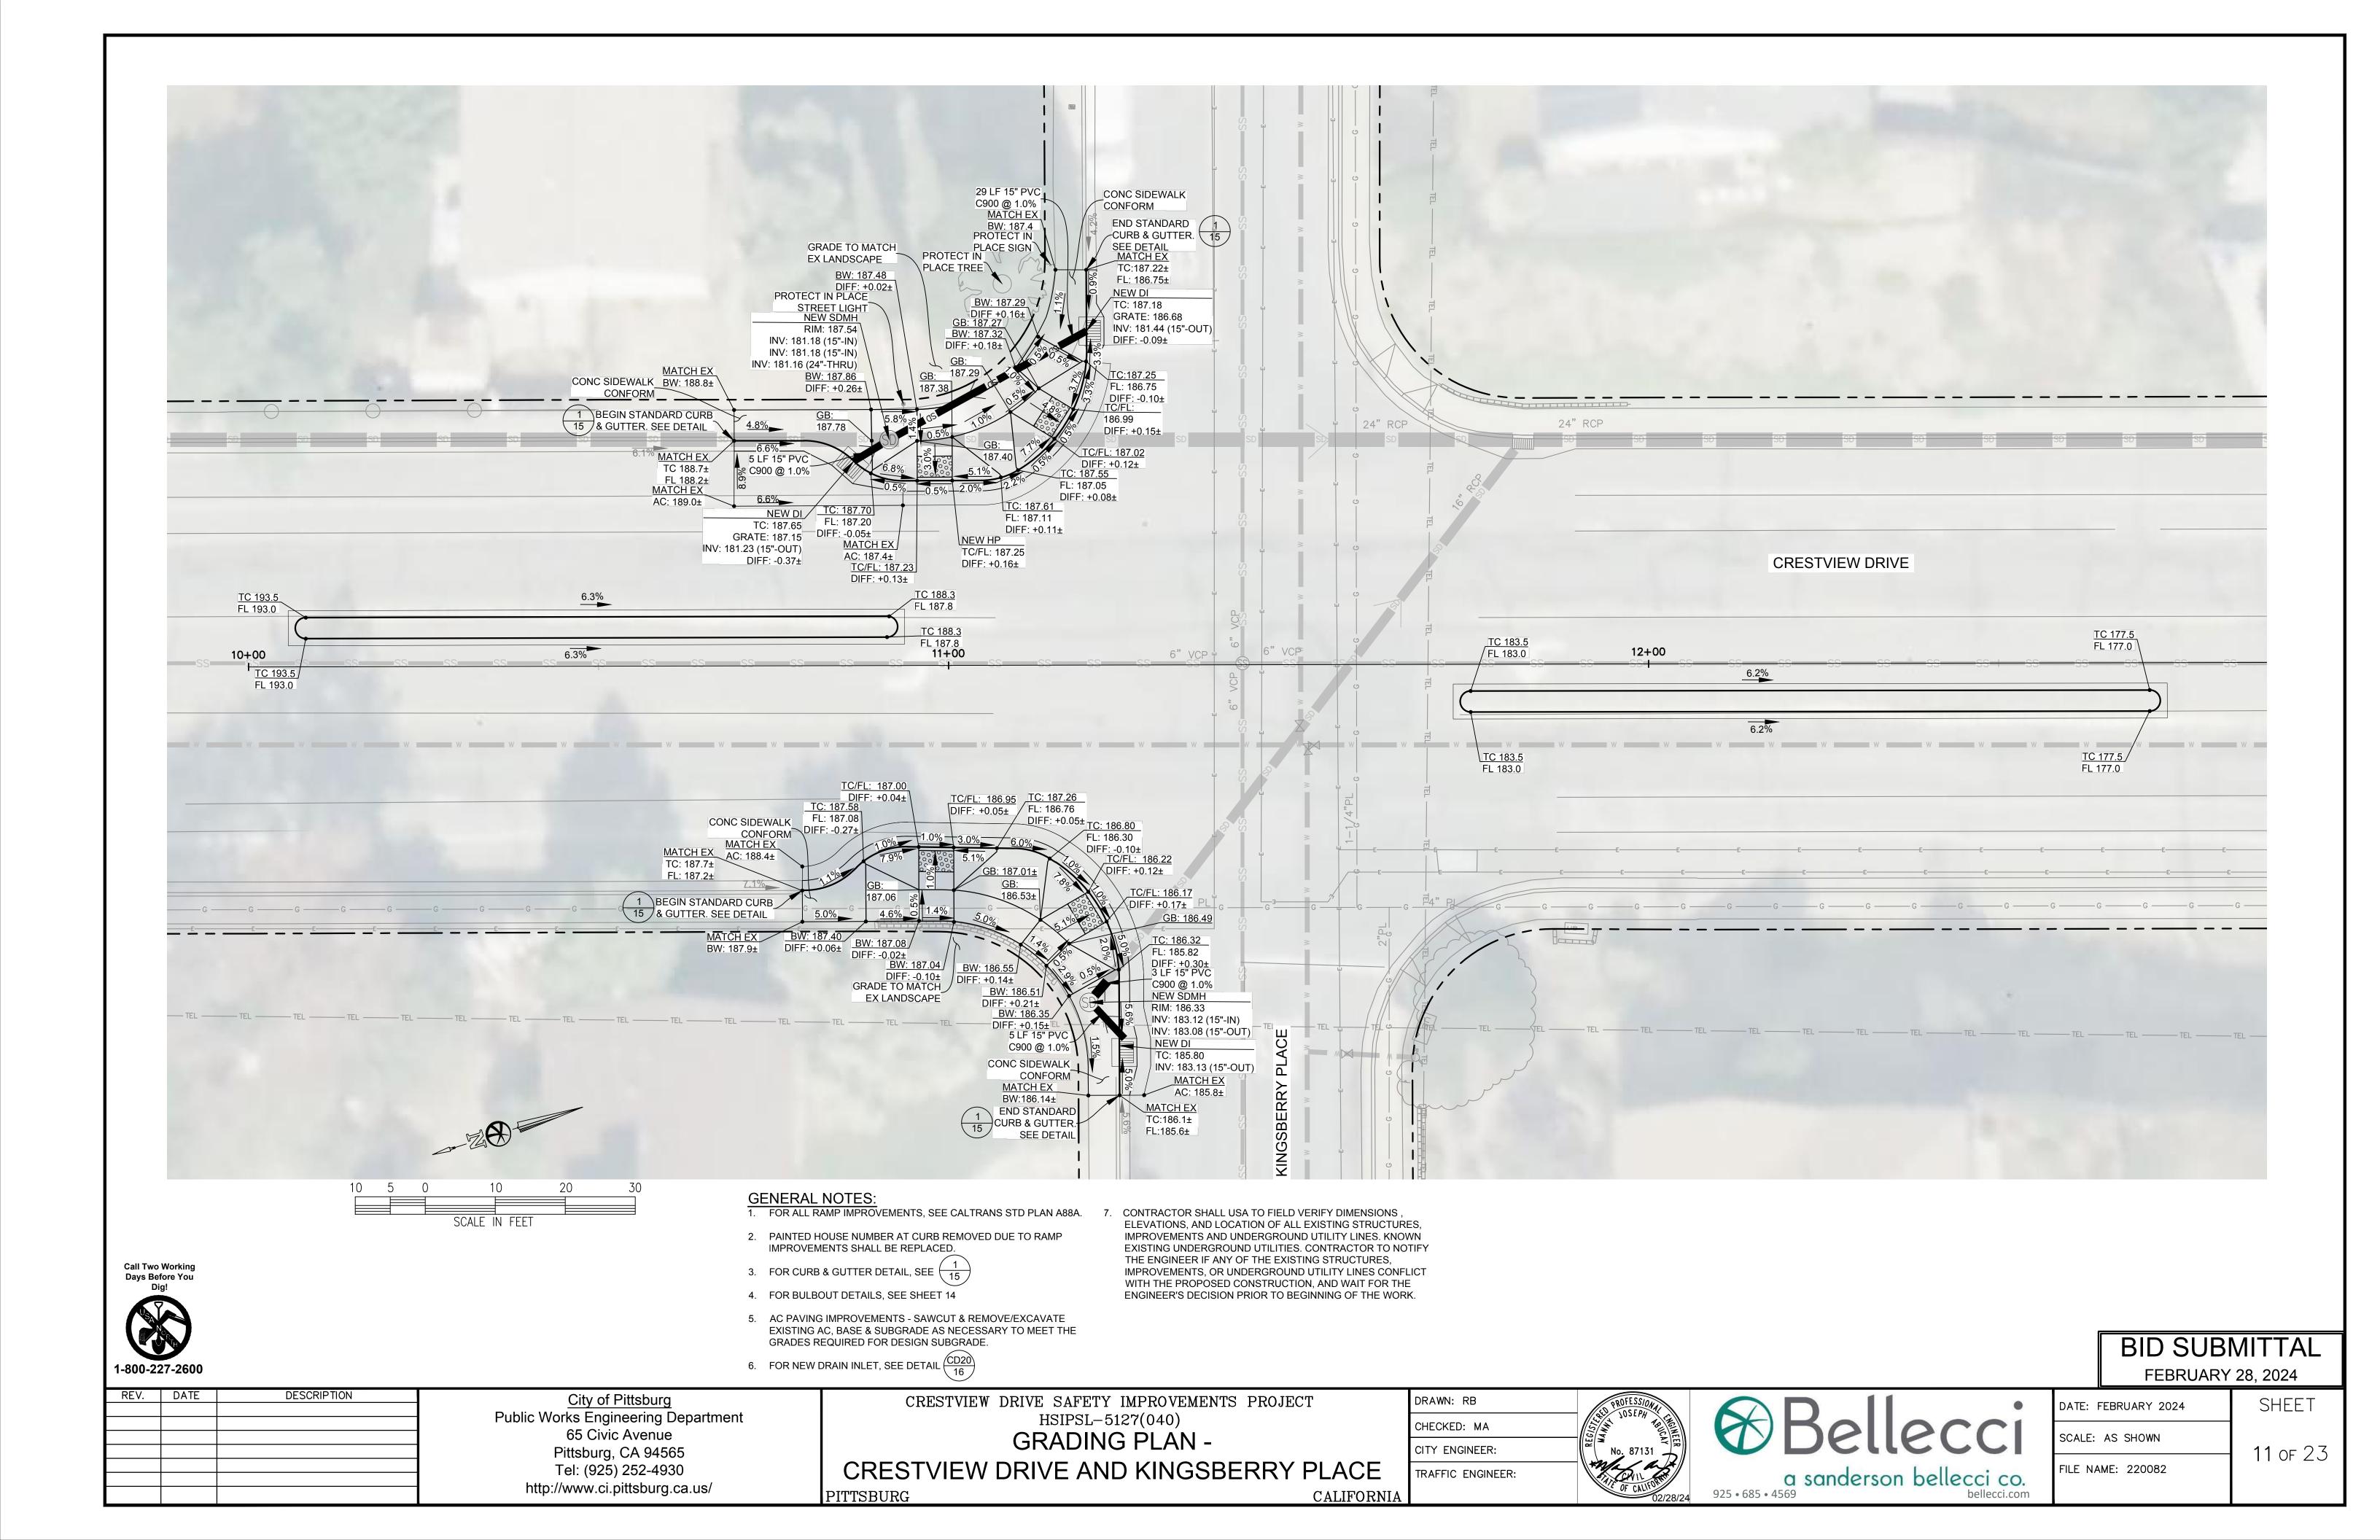

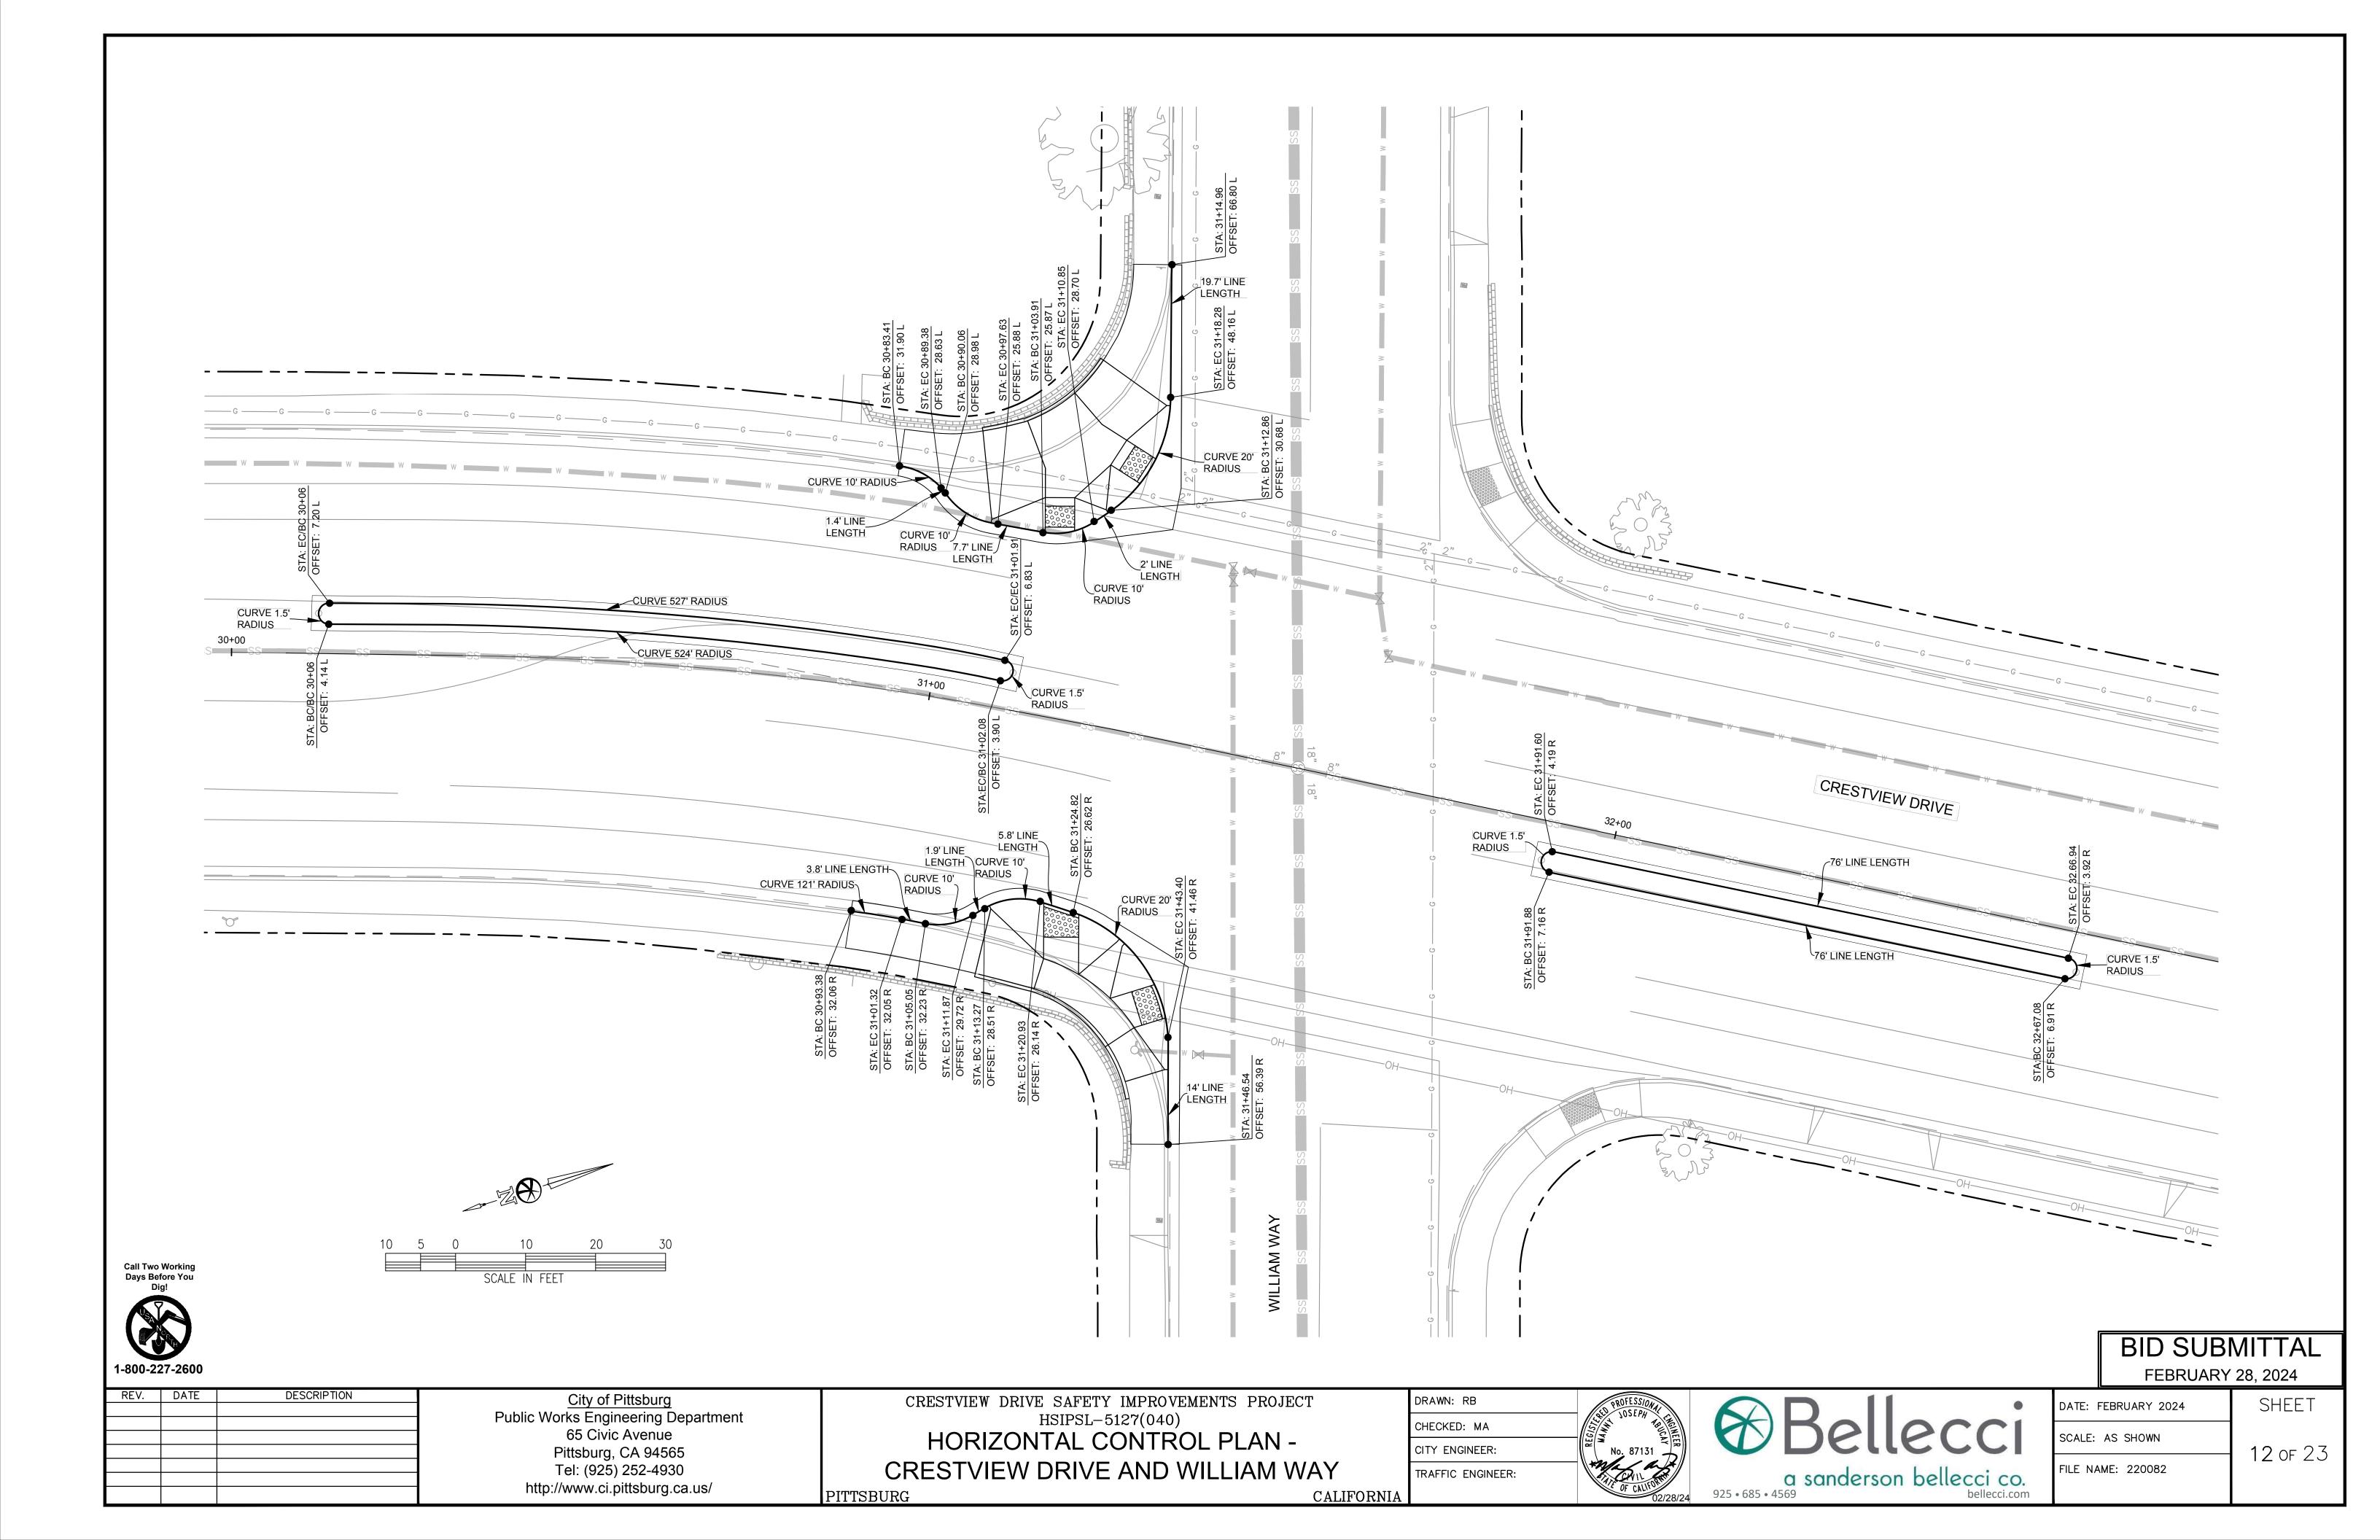

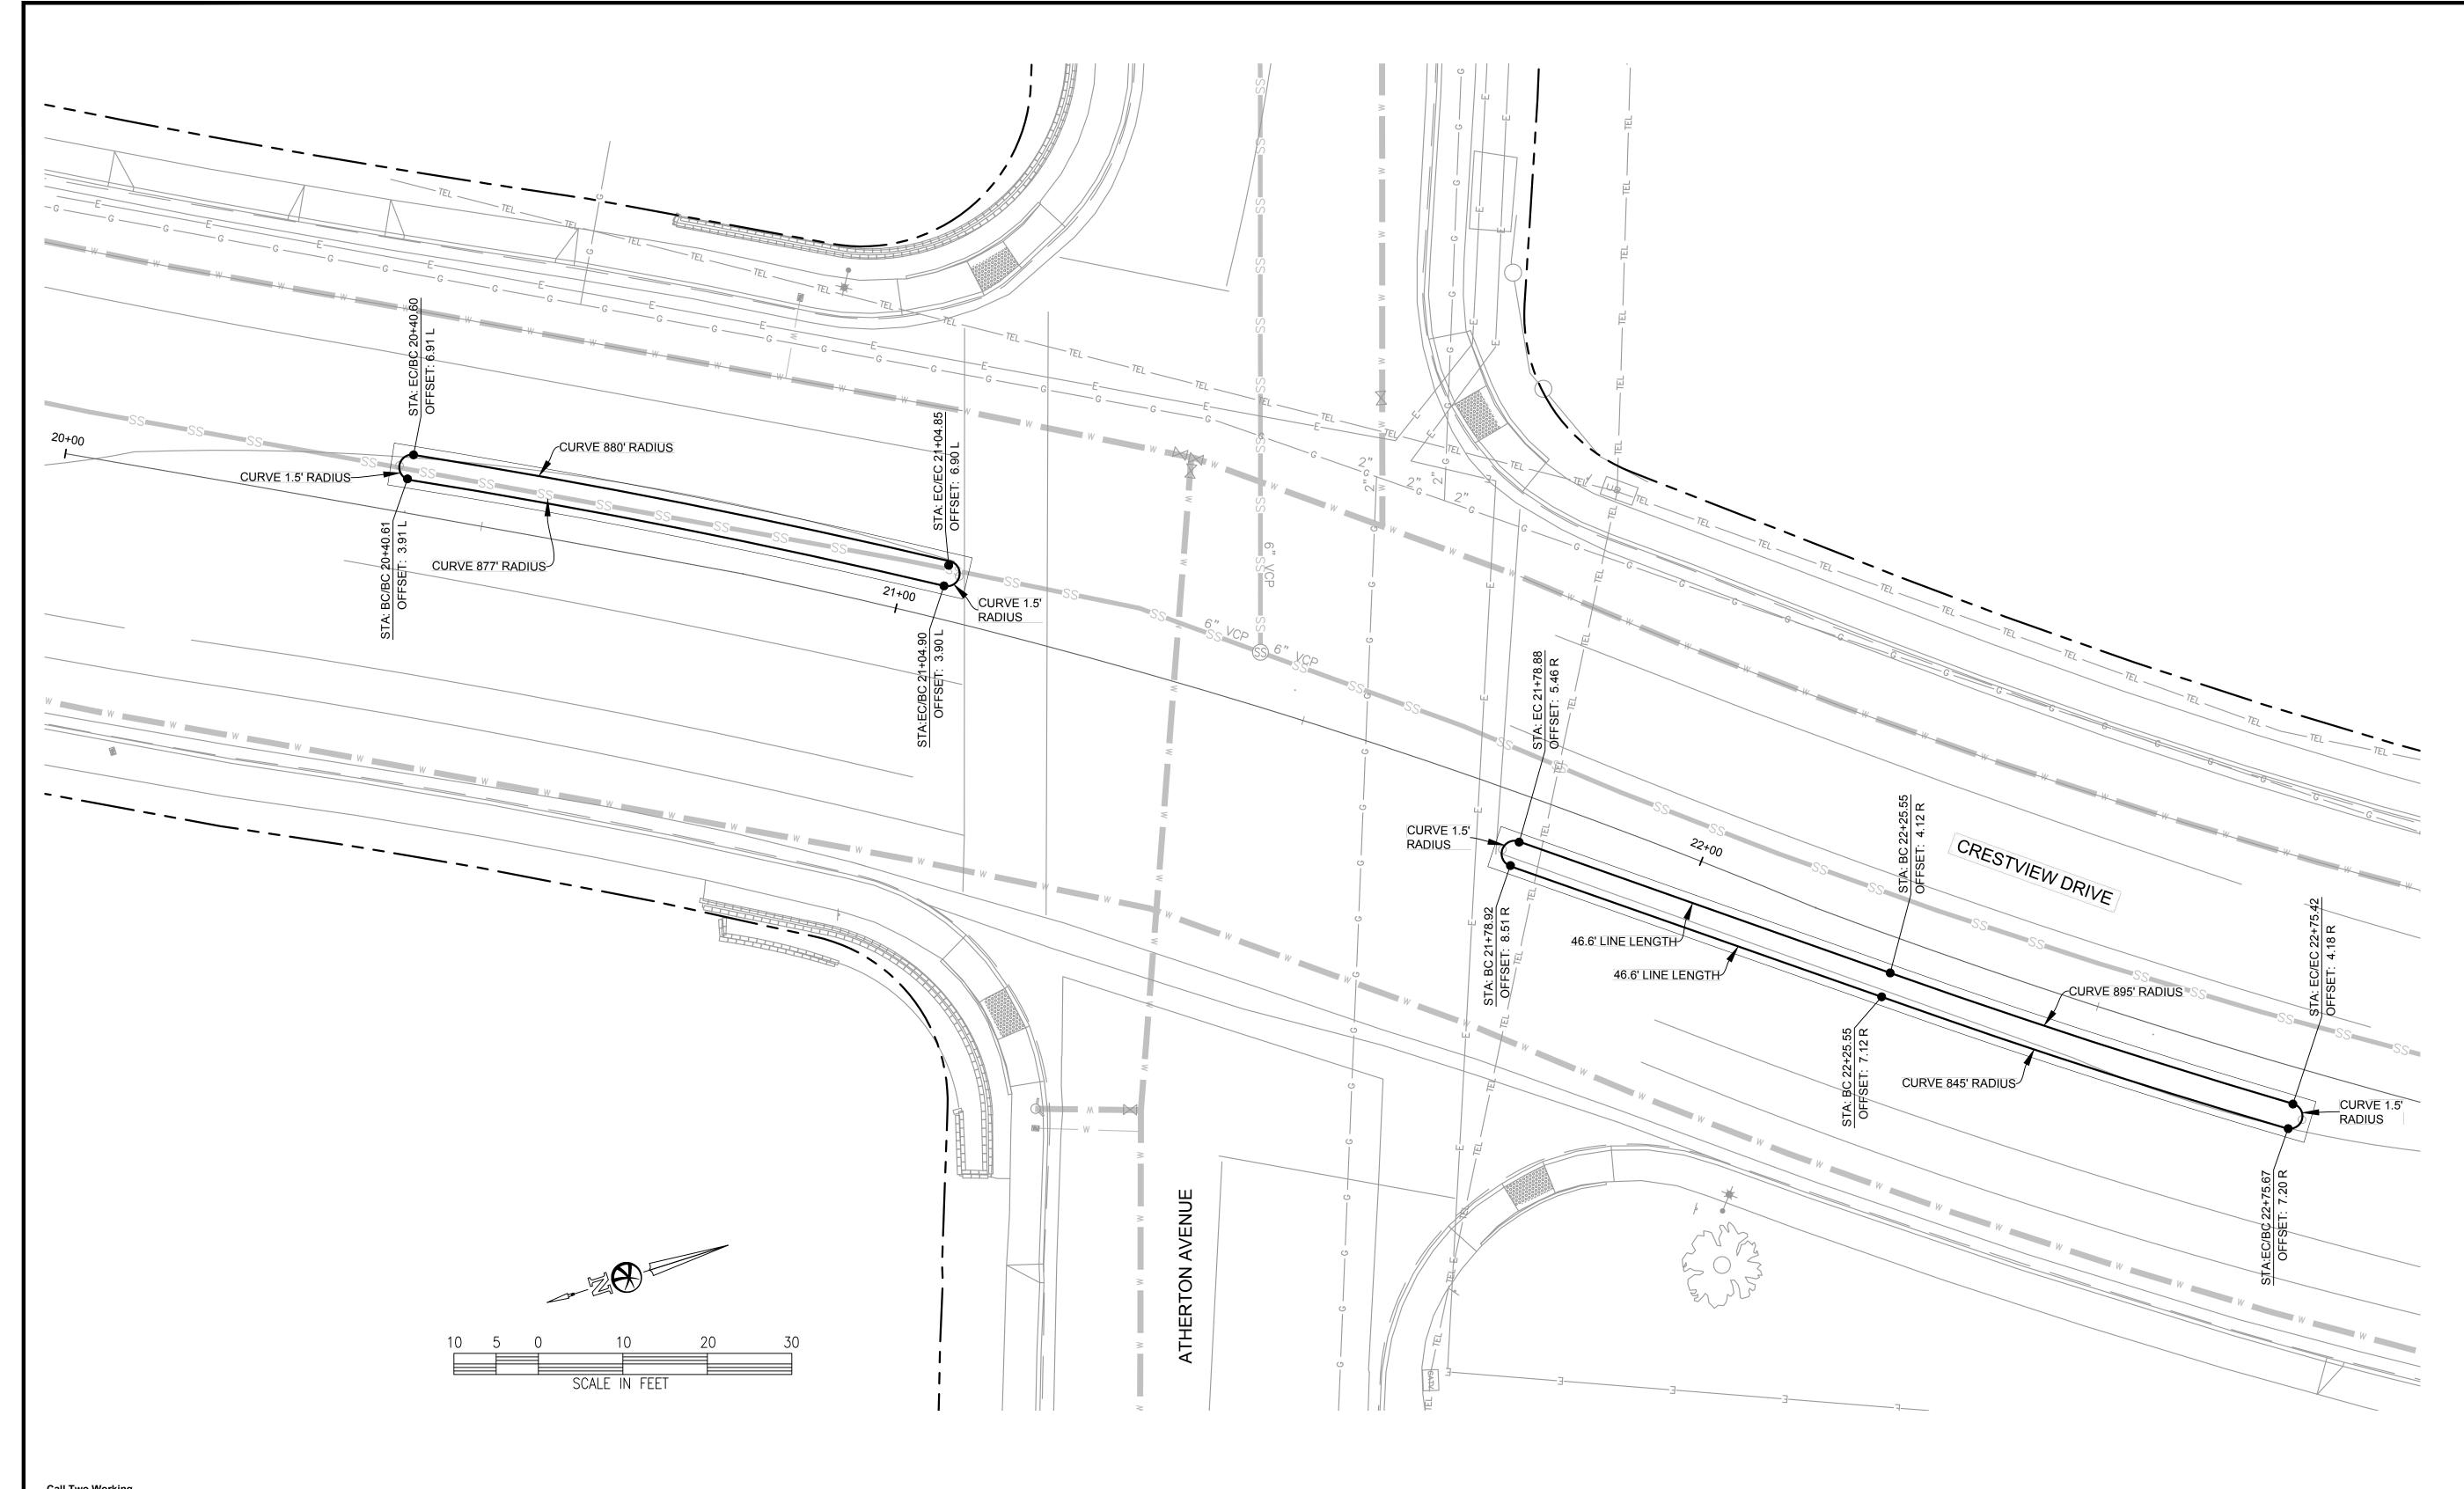

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**BID SUBMITTAL** FEBRUARY 28, 2024

CRESTVIEW DRIVE SAFETY IMPROVEMENTS PROJECT

HSIPSL-5127(040)
HORIZONTAL CONTROL PLAN -

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CHECKED: MA	TO SEE TO	$(\times)$
CITY ENGINEER:	No. 87131	W L
TRAFFIC ENGINEER:	OF CALIFORNIA	925 • 685 • 4569
	02/28/24	323 - 665 - 4565


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a sanderson bellecci co.	FILE NAME: 220082


bellecci.com


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City of Pittsburg
Public Works Engineering Department
65 Civic Avenue REV. DATE DESCRIPTION Pittsburg, CA 94565 Tel: (925) 252-4930 http://www.ci.pittsburg.ca.us/

CRESTVIEW DRIVE AND ATHERTON AVENUE PITTSBURG



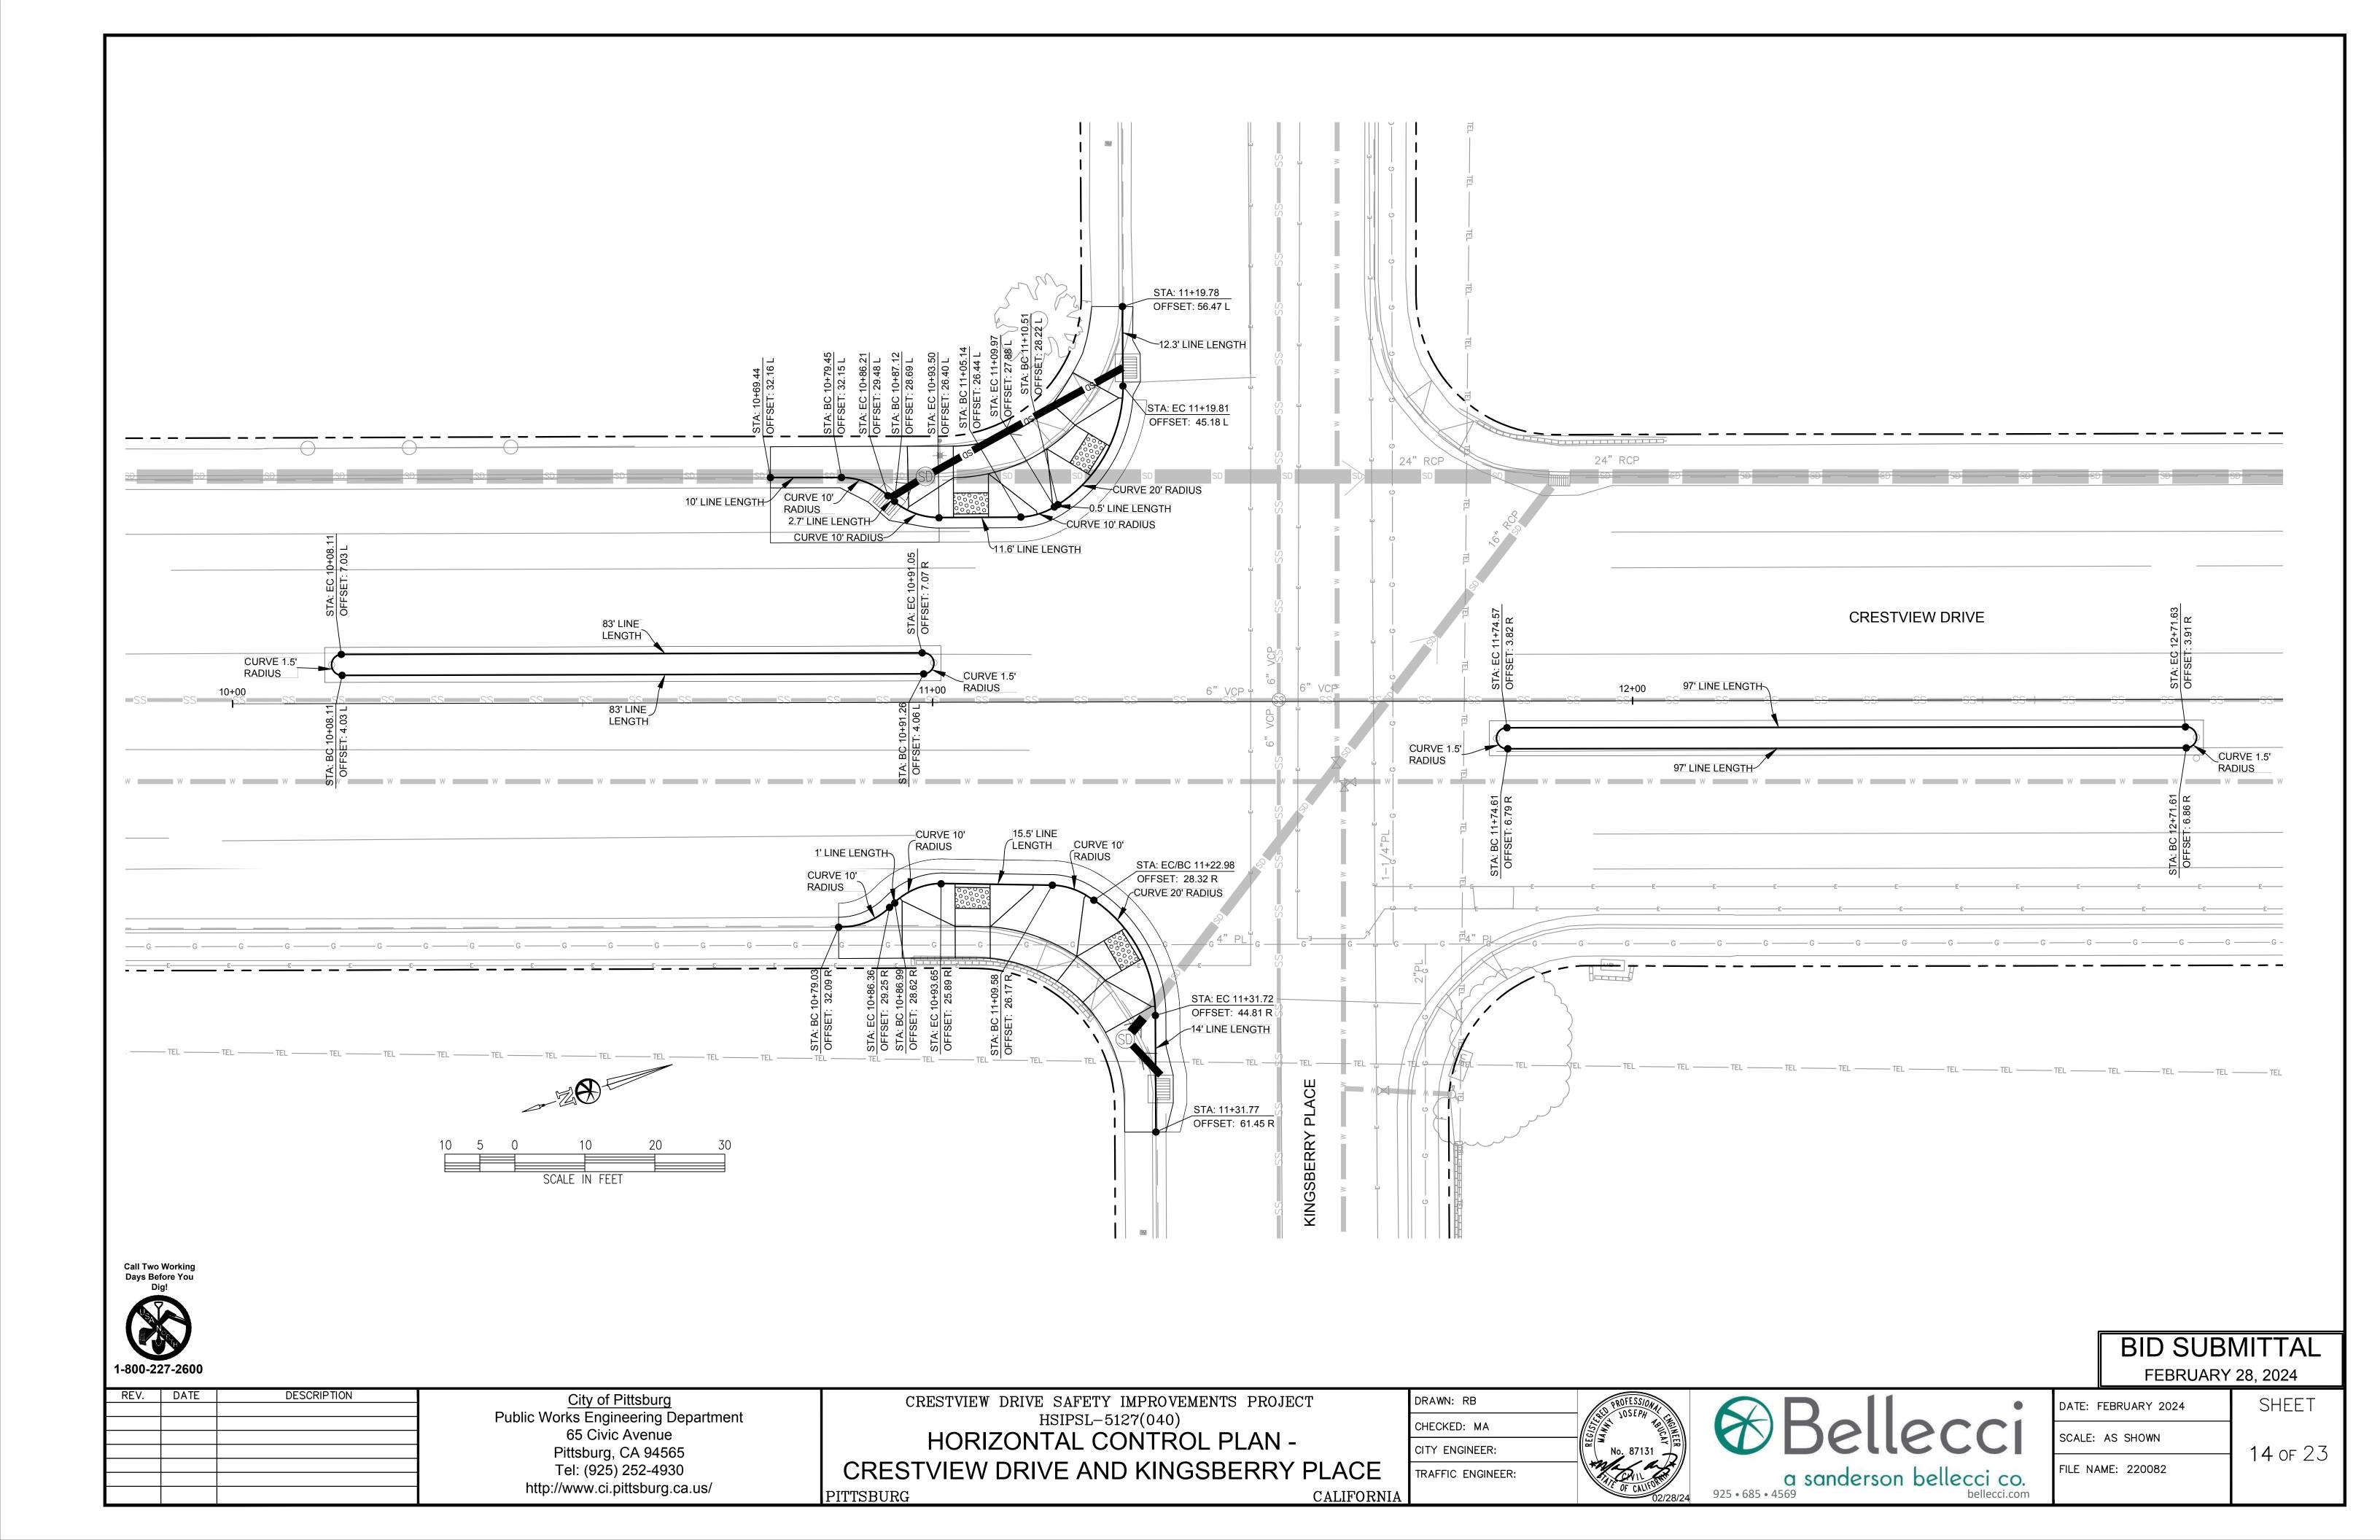

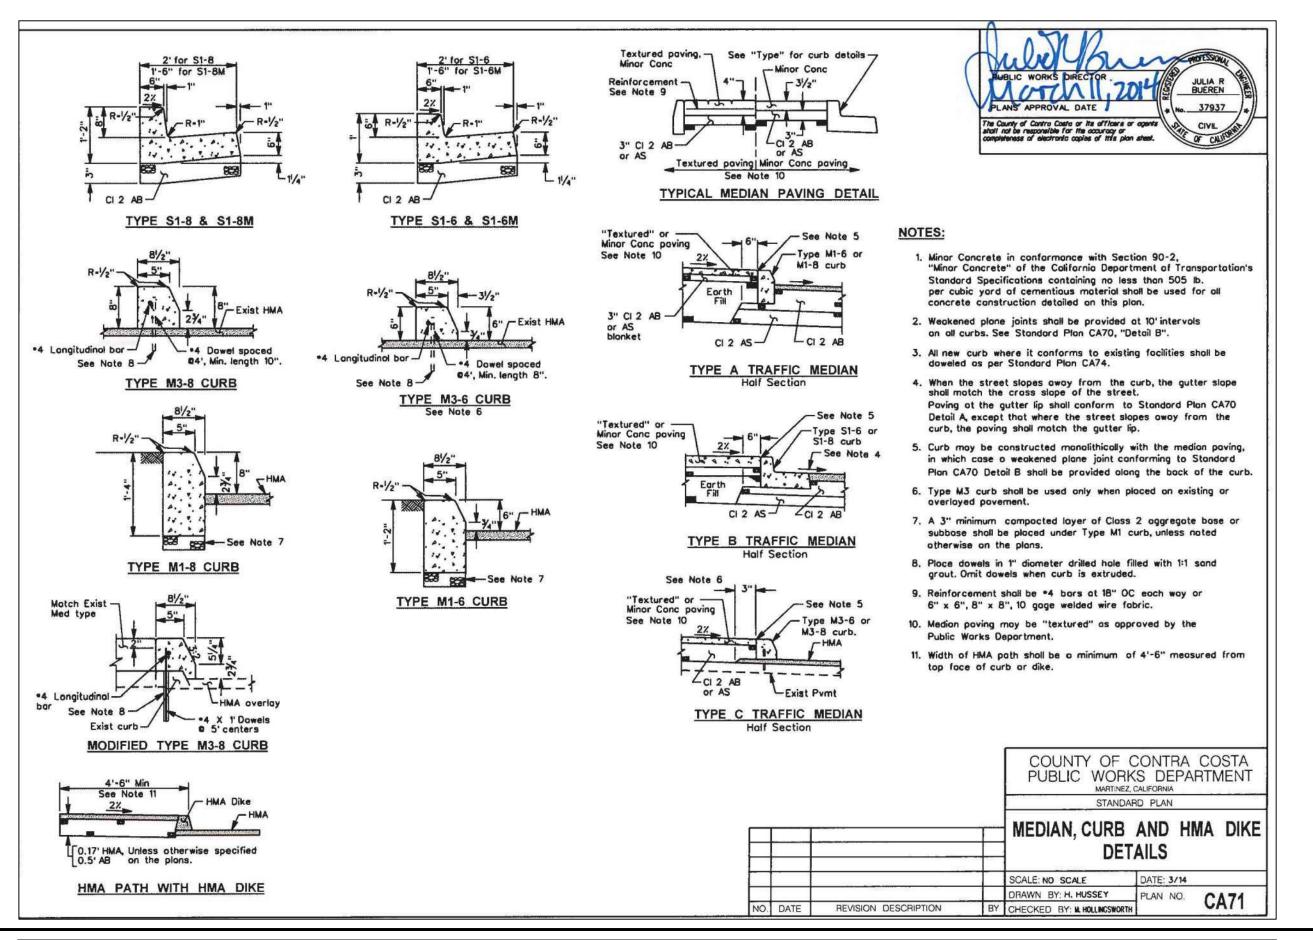

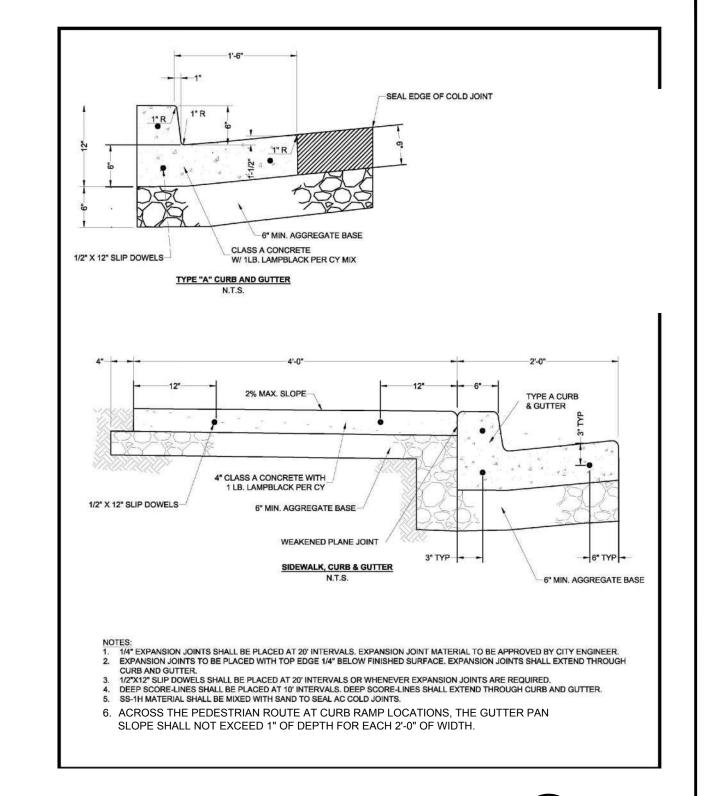CURB, GUTTER, & SIDEWALK DETAIL

ALL CONCRETE DEMOLITION SHALL BE TO SCORE LINES OR JOINTS, ALL CUTS SHALL BE SAWED NEAT AND STRAIGHT AND SHALL HAVE A MINIMUM OF 4" DEPTH OR AS NEEDED TO ASSURE A CLEAN BREAK.

- NO SECTION TO BE REPLACED SHALL BE SMALLER THAN THIRTY (30) INCHES IN EITHER LENGTH OR WIDTH. IF THE SAW CUT IN SIDEWALK WOULD FALL WITHIN THIRTY (30) INCHES OF A CONSTRUCTION JOINT, EXPANSION JOINT, COLD JOINTS, OR EDGE, THE CONCRETE SHALL BE REMOVED TO THE JOINT OR EDGE. ALL SAW CUT RESIDUE SHALL BE VACUUMED CONCURRENTLY WITH SAWING OPERATION.
- AGGREGATE BASE (AB) SHALL BE CRUSHED AB OR CRUSHED MISCELLANEOUS BASE AND SHALL BE COMPACTED TO NOT LESS THAN 95% RELATIVE COMPACTION, AS TESTED BY CITY APPROVED LAB AT CONTRACTOR'S EXPENSE. NEW IMPORTED FULL DEPTH AB SHALL BE PLACED UNDER ALL NEW OR REPLACEMENT CURB, GUTTER, SIDEWALK AND DRIVEWAY.

CONCRETE MIX & POUR:


CONCRETE SHALL BE 6 SACK, ONE INCH MAXIMUM AGGREGATE, 5" MAXIMUM SLUMP, 2,500 PSI MINIMUM. CONCRETE FOR CURB, GUTTER, SIDEWALK AND DRIVEWAY SHALL CONTAIN ONE (1) POUND OF LAMPBLACK PER CU. YD. ADDED & MIXED.


- 1/2" EXPANSION JOINTS SHALL BE PLACED AT 20' INTERVALS, AT CURB RETURNS, AND AT EDGES OF DRIVEWAY APRONS. WEAKENED-PLANE JOINTS (2" DEEP FOR 4" THICK SIDEWALKS, 3" DEEP FOR 6" THICK DRIVEWAYS, AND 4" DEEP FOR 8" THICK DRIVEWAYS) SHALL BE SPACED AT 10' NOMINAL INTERVALS.
- SIDEWALKS SHALL BE SCORE MARKED 2'-6" NOMINAL INTERVALS BOTH WAYS OR MATCH EXISTING AND A CONTINUOUS SCORE MARK SIX (6") INCHES BEHIND FACE OF CURB.
- ALL PCC IMPROVEMENTS SHALL BE DOWELED TO ADJACENT PCC IMPROVEMENTS USING 12" LONG SLIP-DOWELS OR #4 REBAR NO MORE THAN TWENTY-INCHES (20") FROM THE EDGES. FOR SIDEWALK, CURB AND/OR GUTTER EXCAVATIONS THAT EXCEED TWENTY-FEET (20'), DOWELS WILL BE PLACED AT TWENTY-FOOT (20') INTERVALS. DRILL FOR DRIVE TIGHT FIT OR EPOXY IN PLACE

### THE TYPICAL CITY STANDARD CURB HEIGHT IS 6 INCHES AND THE TYPICAL CITY GUTTER WIDTH IS EIGHTEEN (18) INCHES. HOWEVER, EXISTING CURB HEIGHTS (3" TO 9") AND GUTTER WIDTHS (12" TO 24") SHALL BE


MATCHED IN KIND WHEN DIRECTED BY THE CITY ENGINEER.

- EXPOSED SURFACES OF SIDEWALK, DRIVEWAY, CURB AND GUTTER SHALL BE STEEL TROWELED FOLLOWED BY A MEDIUM BROOM FINISH. EXISTING DECORATIVE FINISHES SHALL BE APPROVED BY THE CITY ENGINEER
- EXCEPT AS SHOWN, ALL EXPOSED EDGES, INCLUDING AT WEAKENED-PLANE JOINTS, SHALL BE TOOLED TO 1.1
- ALL CONCRETE SHALL BE CURED BY KEEPING CONTINUOUSLY MOIST FOR THREE DAYS AFTER POURING EITHER BY SPRINKLING, COVERING WITH A WATERPROOF MEMBRANE, OR APPLYING TYPE 1 CONCRETE
- FOR EXISTING AC OVER-LAYED GUTTER, FLOW LINE OF NEW CONCRETE GUTTER SHALL MATCH EXISTING CONCRETE GUTTER FLOW LINE. CURB LIP AT DRIVEWAYS SHALL BE INCREASED TO 1 HIGHER THAN AC
- A MINIMUM ONE (1) FOOT WIDE FULL DEPTH AC STREET STRUCTURAL SECTION SHALL BE PLACED ADJACENT TO THE GUTTER LIP. THE AC SECTION SHALL BE A MINIMUM OF 6" DEEP OR 1" THICKER THAN EXISTING AC, WHICH EVER IS GREATER.
- DRIVEWAY APPROACHES, AND CURB AND GUTTER POURES SHALL BE MONOLITHICALLY. CURB AND GUTTER SHALL BE POURED SEPARATELY FROM SIDEWALK.

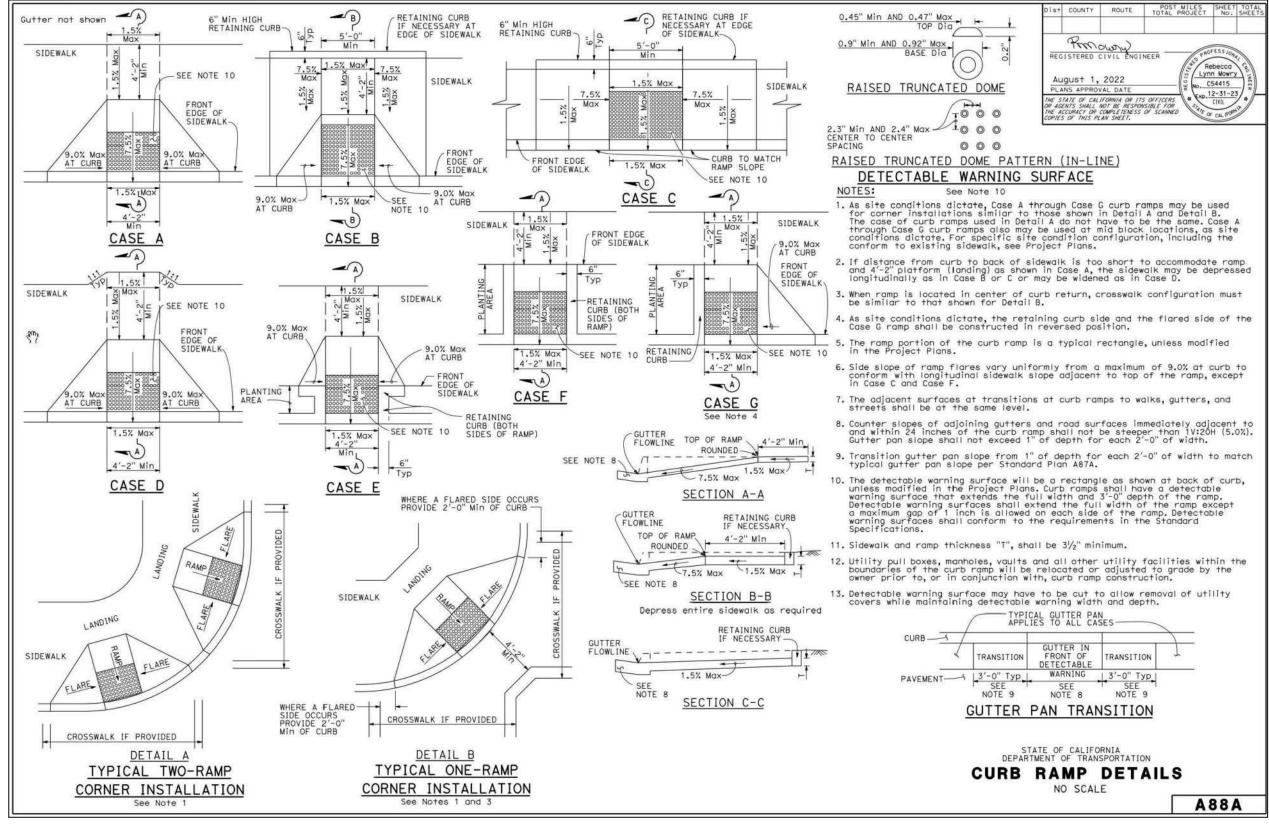

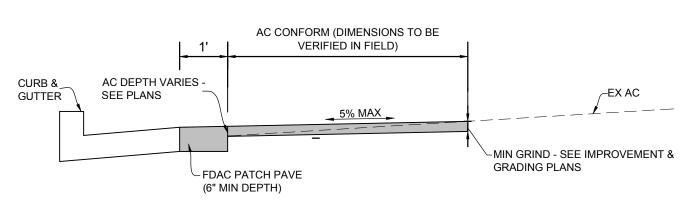

CASE 1 - CONFORM WHEN IMPROVEMENT IS ABOVE EXISTING

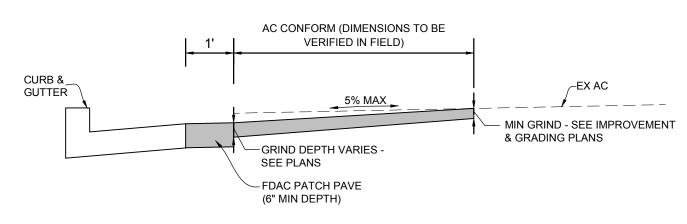

CASE 2 - CONFORM WHEN IMPROVEMENT IS BELOW EXISTING

AC CONFORM AT CURB RAMPS

**BID SUBMITTAL** 

REV. DATE DESCRIPTION City of Pittsburg **Public Works Engineering Department** 65 Civic Avenue Pittsburg, CA 94565 Tel: (925) 252-4930 http://www.ci.pittsburg.ca.us/

Call Two Working

1-800-227-2600

Days Before You

CRESTVIEW DRIVE SAFETY IMPROVEMENTS PROJECT HSIPSL-5127(040)

CIVIL DETAILS

PITTSBURG

DRAWN: RB CHECKED: MA CITY ENGINEER: TRAFFIC ENGINEER:





FEBRUARY 28, 2024 SHEET DATE: FEBRUARY 2024 SCALE: AS SHOWN


FILE NAME: 220082

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CALIFORNIA



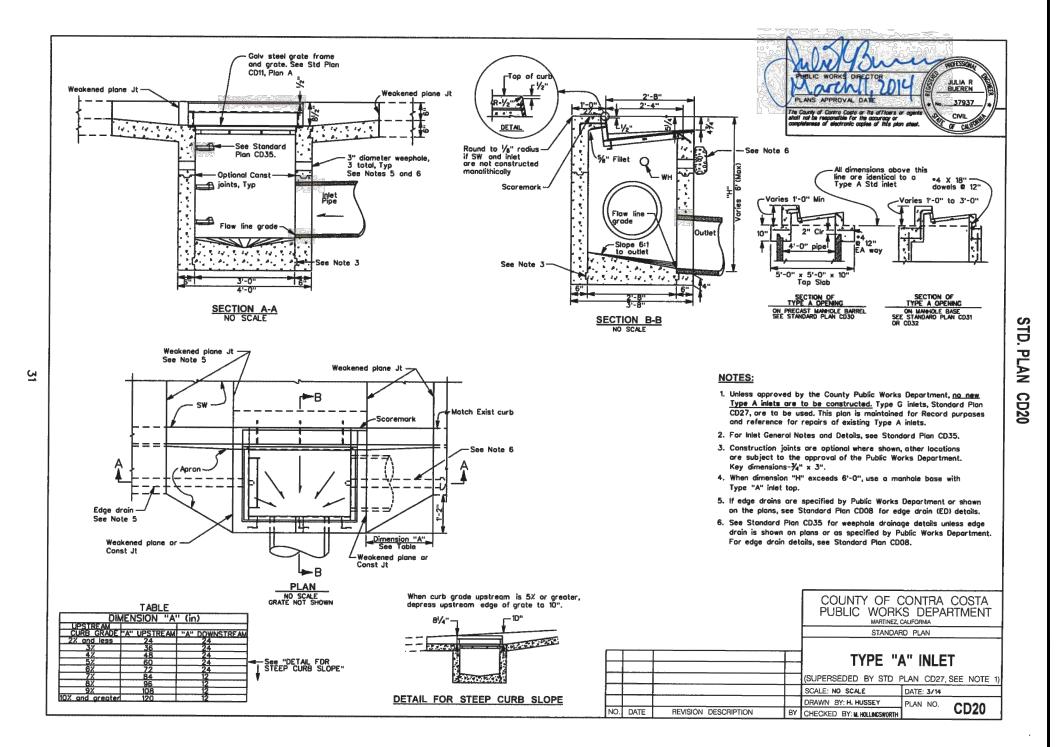

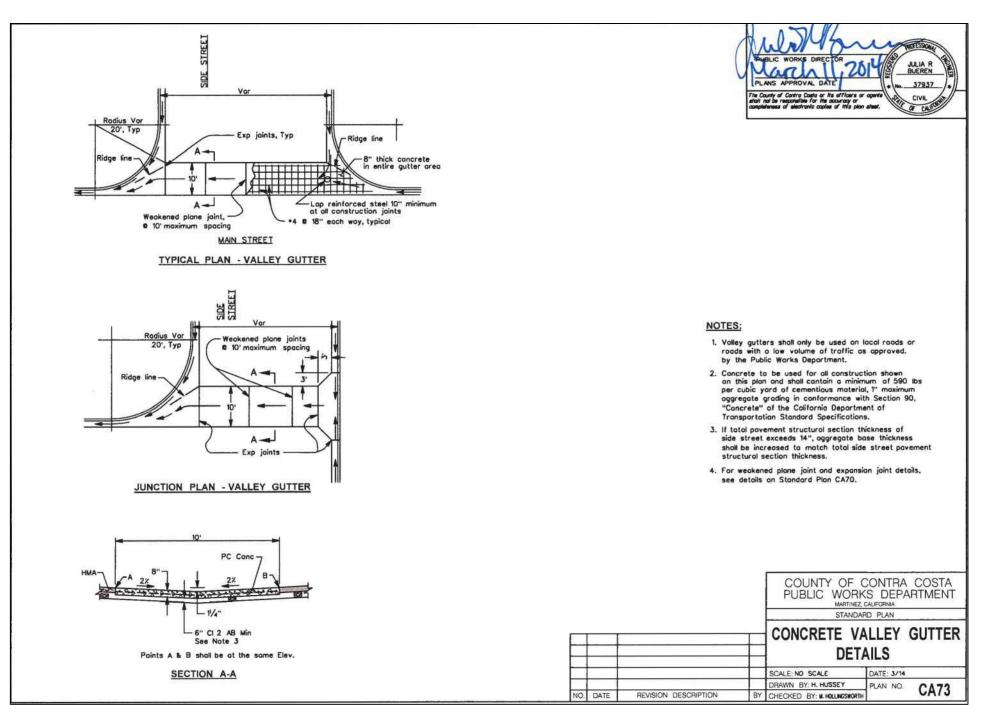

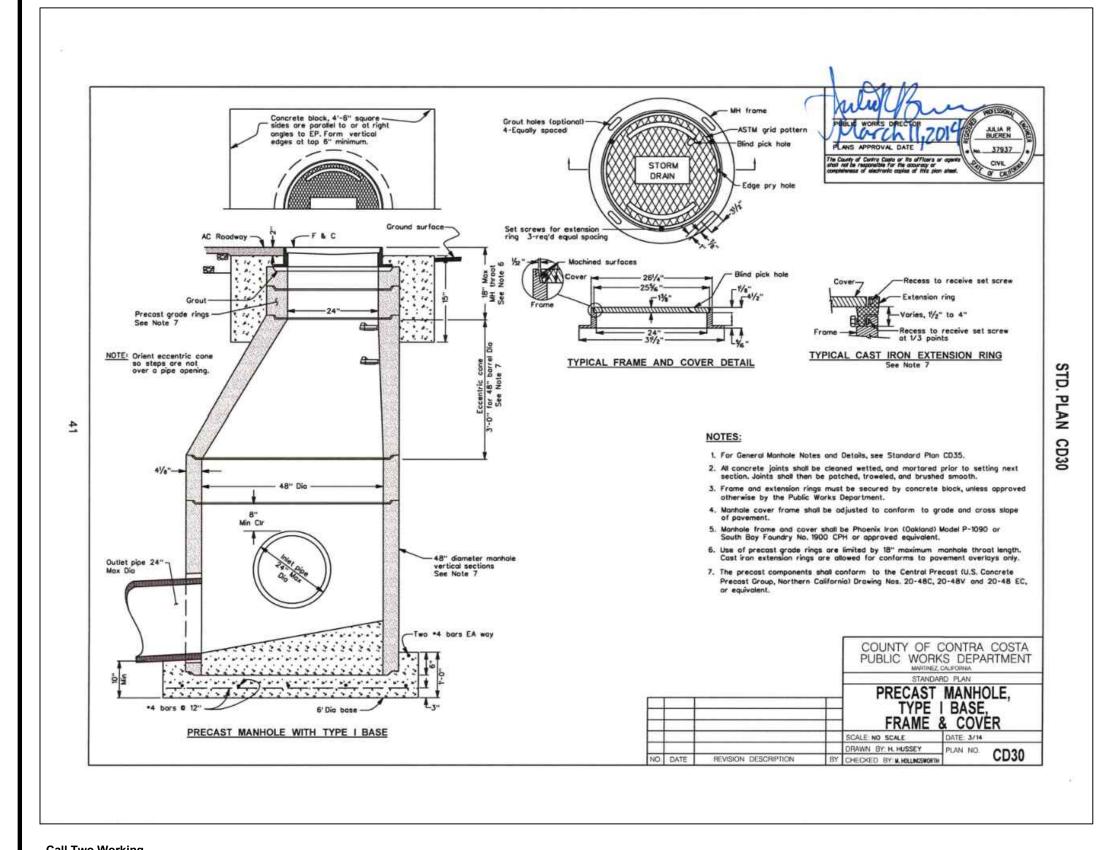0.3% 0.9% PROTECT IN PLACE SEWER MANHOLE PROTECT IN PLACE MONUMENT TC 238.96 FL 238.46 DIFF +0.0± - SAWCUT LINE TC 238.92 FL 238.42 0.1% 0.8% DIFF +0.0± TC 238.89 FL 238.39 CONCRETE CURB & MEDIAN TYPE A, M1-6. SEE DETAIL DIFF +0.0± REMOVE EX TEMPORARY CIRCLE PROTECT IN PLACE WATER VALVE TC 238.84 FL 238.34 0.4% 0.3% **LEGEND** SAWCUT & REMOVE AC PAVEMENT (INCLUDING PAVEMENT MARKINGS & STRIPING), BASE, & SUBSOIL. EXCAVATE AS NECESSARY TO MEET THE GRADES REQUIRED FOR DESIGN



1-800-227-2600

REV. DATE

DESCRIPTION

CRESTVIEW DRIVE SAFETY IMPROVEMENTS PROJECT HSIPSL-5127(040)

SUBGRADE. INSTALL CONCRETE IMPROVEMENTS

CIVIL DETAILS

DRAWN: RB



FEBRUARY 28, 2024 SHEET DATE: FEBRUARY 2024

CHECKED: MA CITY ENGINEER: TRAFFIC ENGINEER:

INTERSECTION OF CRESTVIEW DRIVE & ALTA VISTA CIRCLE & SUNNYHILL WAY

SCALE: 1"=5"

SCALE: AS SHOWN 16 of 23 FILE NAME: 220082

**BID SUBMITTAL** 

City of Pittsburg Public Works Engineering Department 65 Civic Avenue Pittsburg, CA 94565 Tel: (925) 252-4930 http://www.ci.pittsburg.ca.us/

PITTSBURG

CALIFORNIA

## SIGNING AND STRIPING GENERAL NOTES:

- 1. WORK ON THESE PLANS SHALL CONFORM TO THE 2023 EDITION OF THE STATE OF CALIFORNIA DEPARTMENT OF TRANSPORTATION (CALTRANS) STANDARD SPECIFICATIONS, STANDARD PLANS AND REVISIONS, THE LATEST MUTCD CALIFORNIA SUPPLEMENT AND THE SPECIAL PROVISIONS AND CITY STANDARD DETAILS AND SPECIFICATIONS.
- 2. ALL EXISTING STRIPING THAT ARE IN CONFLICT WITH PROPOSED STRIPING SHALL BE REMOVED.
- 3. ALL EXISTING STRIPING, MARKINGS, AND PAVEMENT MARKERS DAMAGED DURING CONSTRUCTION SHALL BE REPLACED IN KIND, UNLESS OTHERWISE SHOWN THE PLAN.
- 4. CONTRACTOR SHALL SUBMIT TRAFFIC HANDLING PLANS AND BICYCLE ACCESS PLANS FOR REVIEW AND APPROVAL PRIOR TO CONSTRUCTION.
- 5. ALL PAVEMENT MARKINGS AND STRIPING SHALL BE THERMOPLASTIC.
- 6. LOCATIONS OF POLES, SIGNS, AND OTHER EQUIPMENT ARE APPROXIMATE AND WILL BE LOCATED IN THE FIELD AS DIRECTED BY THE ENGINEER.
- 7. PLANS ARE ACCURATE FOR SIGNING, STRIPING, AND ELECTRICAL WORK ONLY.
- 8. THE CONTRACTOR IS REQUIRED TO ASCERTAIN THE EXACT LOCATION OF UNDERGROUND FACILITIES PRIOR TO DOING WORK THAT MAY DAMAGE OR INTERFERE WITH SUCH FACILITIES. THE CONTRACTOR SHALL CALL UNDERGROUND SERVICE ALERT (USA) AT (800) 422-4133, 48 HOURS PRIOR TO CONSTRUCTION.
- 9. THE CONTRACTOR SHALL OBTAIN ALL NECESSARY UTILITY PERMITS AND NOTIFY ALL UTILITY COMPANIES A MINIMUM OF 48 HOURS PRIOR TO START OF CONSTRUCTION. IT SHALL BE THE RESPONSIBILITY OF THE CONTRACTOR TO COORDINATE ALL PHASES OF CONSTRUCTION WITH THE VARIOUS UTILITY COMPANIES INVOLVED. CONTRACTOR IS RESPONSIBLE FOR ALL UTILITY COMPANY SERVICE FEES.
- 10. ALL EXISTING IMPROVEMENTS MATERIALS, AND PLANT MATERIAL SHALL REMAIN WITHIN THE CONSTRUCTION AREA AND SHALL BE PROPERLY AND ADEQUATELY PROTECTED FROM DAMAGE DURING CONSTRUCTION. IT SHALL BE THE RESPONSIBILITY OF THE CONTRACTOR TO RESTORE TO THE ORIGINAL CONDITION OR REPLACE IN KIND ANY OF THESE EXISTING ITEMS THAT ARE DAMAGED OR DISTURBED IN ANY WAY AT CONTRACTOR'S EXPENSE.
- 11. CONTRACTOR SHALL BE RESPONSIBLE FOR MAINTAINING RECORD DRAWINGS FOR ALL WORK THROUGHOUT THE COURSE OF CONSTRUCTION AND SHALL PRESENT SUCH DRAWINGS TO THE CITY ENGINEER FOR INSPECTION UPON DEMAND. NO RECORD DRAWINGS SHALL BE MORE THAN 24 HOURS OUT OF DATE. FINAL AS-BUILT DRAWINGS SHALL BE SUBMITTED IN CAD, PDF, AND GIS SHAPEFILE FORMATS PER SPECIFICATIONS.
- 12. CONTRACTOR IS TO COORDINATE ALL WORK WITH THE CITY ENGINEER PRIOR TO AND DURING WORK.
- 13. ALL WORK SHOWN AS PROPOSED IN THIS PROJECT SHALL INDICATE "FURNISH AND INSTALL UNLESS OTHERWISE NOTED."
- 14. CONTRACTOR TO SALVAGE AND DELIVER ALL OF THE EQUIPMENT TO THE CITY OF PITTSBURG CORPORATION YARD.
- 15. CONTRACTOR SHALL OBTAIN APPROVAL FROM BOTH THE CITY ENGINEER AND MANUFACTURER FOR SOLAR PANEL ORIENTATION.
- 16. ALL STRIPING DETAILS SHALL MEET CALTRANS REQUIREMENTS

## PROJECT NOTES:

- 1 | INSTALL THERMOPLASTIC TYPE IV(L) ARROW PER CALTRANS STD PLAN A24A.
- 2 INSTALL THERMOPLASTIC PAVEMENT MARKING LEGEND PER CALTRANS STD PLAN A24D.
- 3 FURNISH AND INSTALL NEW SIGN ON EXISTING STREET LIGHT POLE.
- INSTALL 12" WIDE THERMOPLASTIC LIMIT LINE PAVEMENT MARKING PER CITY OF PITTSBURG STANDARD DETAIL T-3.
- 5 INSTALL 12" WHITE WIDE THERMOPLASTIC CROSSWALK STRIPING AT 11' O.C PER CALTRANS STD PLANS.
- 6 INSTALL THERMOPLASTIC CONTINENTAL CROSSWALK PER CITY OF PITTSBURG STANDARD DETAIL T-13.
- 7 INSTALL THERMOPLASTIC BICYCLE MARKING AND BIKE LANE ARROW PER CALTRANS STD PLANS A24A &A24C.

8 INSTALL RED CURB PAINT

DESCRIPTION

- 9 INSTALL YELLOW REFLECTIVE PAVEMENT MARKERS PER DETAIL A ON SHEET 19.
- 10 FURNISH AND INSTALL NEW SIGN ON NEW POST.
- ☐ INSTALL R1-3P BELOW EXISTING R1-1 SIGN ON EXISTING POST. ADJUST SIGNS 11 AS NECESSARY TO MEET 7-FOOT CLEARANCE TO WALKING SURFACE.
- FURNISH AND INSTALL CUSTOM 12' TALL 2" I.D. GALVANIZED STEEL POLE AND FOUNDATION WITH EQUIPMENT AND SIGNS PER DETAIL A ON SHEET 17.
- MINIMUM 2' OFFSET BETWEEN FACE OF CURB AND CLASS-II BIKEWAY STRIPING PER HIGHWAY DESIGN MANUAL FIGURE 303.4A.
- 14 REMOVE AND SALVAGE EXISTING DELINEATORS AND RAISED CURB UNITS.
- FURNISH AND INSTALL W2-6 AND W16-12P ON NEW POST. SIGNS SHALL BE MOUNTED AT 5' FROM FINISHED GRADE.



1-800-227-2600

REV. DATE

City of Pittsburg Public Works Engineering Department 65 Civic Avenue Pittsburg, CA 94565

CRESTVIEW DRIVE SAFETY IMPROVEMENTS PROJECT

12' TALL, 2" I.D GALVANIZED STEEL POLE

FRONT VIEW

ELECTRICAL, SIGNING, AND STRIPING PLANS NOTES AND DETAILS

12' TALL, 2" I.D GALVANIZED STEEL POLE

SIDE VIEW

TJKM 4305 Hacienda Drive, Suite 550 Pleasanton, CA 94588

DATE: FEBRUARY 2024 SCALE: AS SHOWN

DETAIL B ACCESSIBLE PEDESTRIAN SIGNAL

> **BID SUBMITTAL** FEBRUARY 28, 2024

HSIPSL-5127(040)

3'-6"

0000

CHECKED: RP CITY ENGINEER: TRAFFIC ENGINEER:

DRAWN: AD

SELF-CONTAINED SOLAR PANEL WITH NEMA 3R -

HOUSING (WITH WIRELESS COMMUNICATION DEVICE), OR EQUIVALENT, AFFIXED TO

ALUMINUM PLATE AND BRACKET, ADJUSTABLE AT

ANGLE OF 45' TO 60' VERTICALLY AND ABILITY

TO ROTATE 360° TO FACILITATE ADJUSTMENTS

FOR MAXIMUM SOLAR COLLECTION AND OPTIMAL 44 AH BATTERY STRENGTH. SOLAR PANEL TO BE

AIMED PER ENGINEERS FIELD INSTRUCTIONS.

ROUND 3.5" POLE MOUNT PER MANUFACTURER'S

SPECIFICATIONS.

-TWO FLUORESCENT YELLOW GREEN-W11-2 SIGNS (36"x36")

INSTALLED BACK TO BACK TO BE

VISIBLE FROM BOTH DIRECTIONS

PER CA MUTCD STANDARDS.

—RECTANGULAR RAPID FLASHING—

BEACON (RRFB) WITH MIN. 6

LED'S (2 FRONT, 2 BACK, 1

-TWO FLUORESCENT YELLOW GREEN —

W16-7P SIGNS (12"x24") INSTALLED BACK TO BACK TO BE

VISIBLE FROM BOTH DIRECTIONS

PER CA MUTCD STANDARDS.

DIRECTION TOWARDS ROADWAY.

NOTE: ARROW DIRECTION SHALL BE IN

CUSTOM 12' TALL 2" I.D. GALVANIZED — STEEL POLE

-APS PUSH BUTTON PER DETAIL B ON-THIS SHEET AND CALTRANS STD PLAN ES-5C.

NOTE: ARROW DIRECTION VARIES BY POLE LOCATION. ARROW DIRECTION SHALL BE IN DIRECTION OF ROADWAY

SEE PLANS FOR IF POLE REQUIRES

PUSH BUTTON.

CLASS "B" CONCRETE 3.000 — PSI COMPRESSIVE STRENGTH

> AT 28 DAYS. SEE SPECIFICATIONS.

· CLASS II AGGREGATE BASE — COMPACTED AT 90% RC

**DETAIL A** 

PROPOSED 1-B POLE TWO-SIDED RRFB SYSTEM DETAIL

LEFT SIDE, 1 RIGHT SIDE).

SHEET

FILE NAME: 220082

-ENCLOSURE

AND SPEAKER

Tel: (925) 252-4930 http://www.ci.pittsburg.ca.us/

PITTSBURG


2'-0"


7' MIN

3'-6"

**CALIFORNIA** 

17 of 23

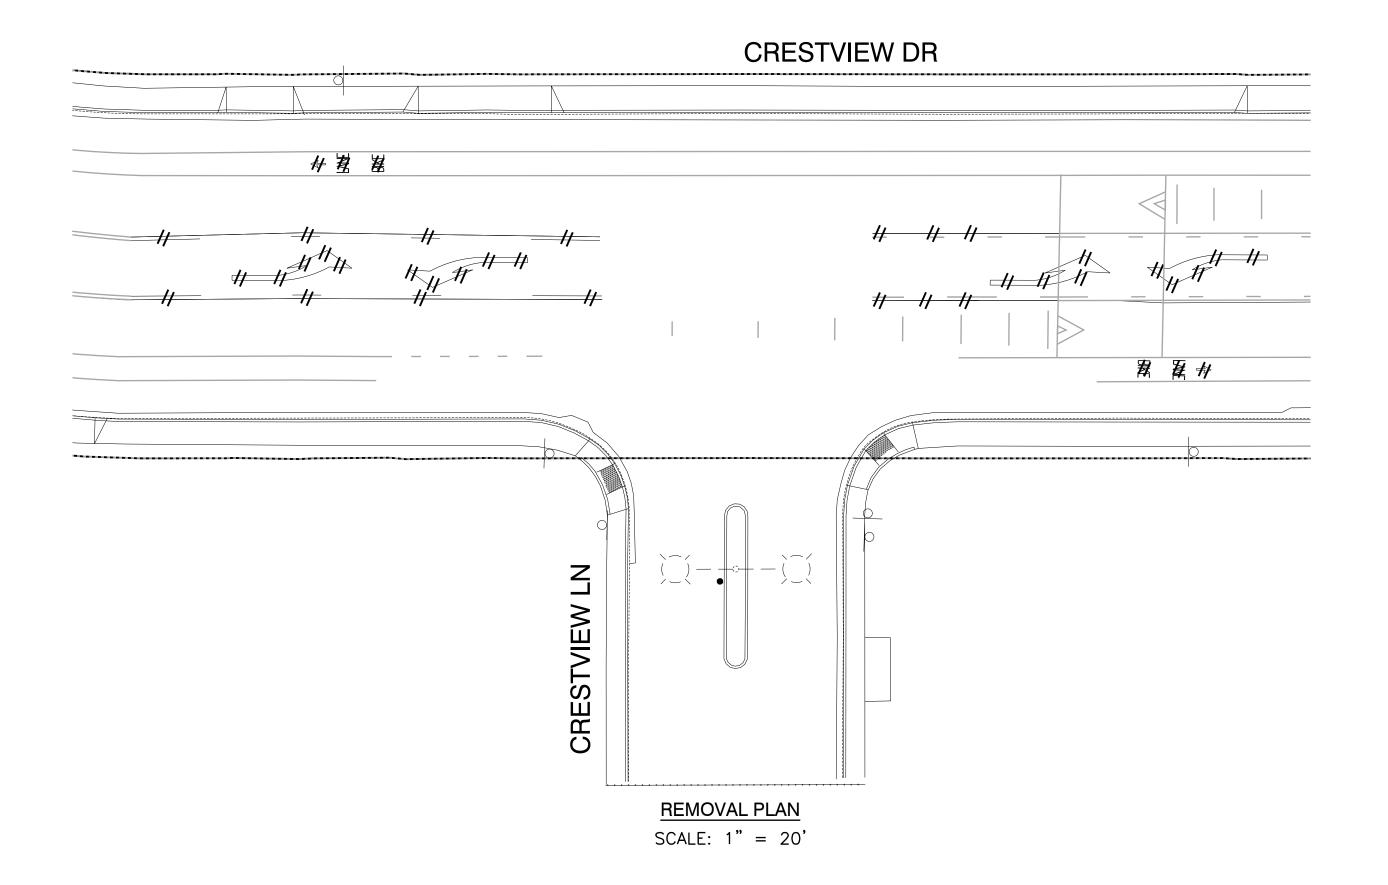

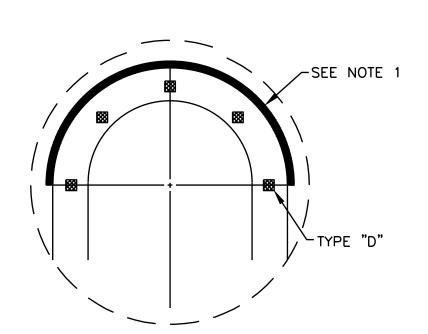

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NOTES (DETAIL A ONLY)

1. PAINT MEDIAN NOSE WITH YELLOW TRAFFIC PAINT.


- 2. INSTALL R4-7 SIGN AND TYPE "N" OBJECT MARKER ON TELESPAR POST. IF MEDIAN IS LESS THAN 2' WIDE, INSTALL FLEXIBLE VERTICAL TYPE "K" MARKER.
- 3. INSTALL YELLOW REFLECTIVE PAVEMENT MARKERS ON TOP OF SURFACE OF MEDIAN CURB NOSE AT 2' ON CENTER SPACING. (MINIMUM 5 MARKERS). PLACE SURFACE MARKER'S REFLECTIVE SURFACE FACING ON COMING TRAFFIC.

LEGEND (DETAIL A ONLY)

TYPE "D" TWO-WAY YELLOW REFLECTIVE MARKER (HIGH INTENSITY)

PITTSBURG



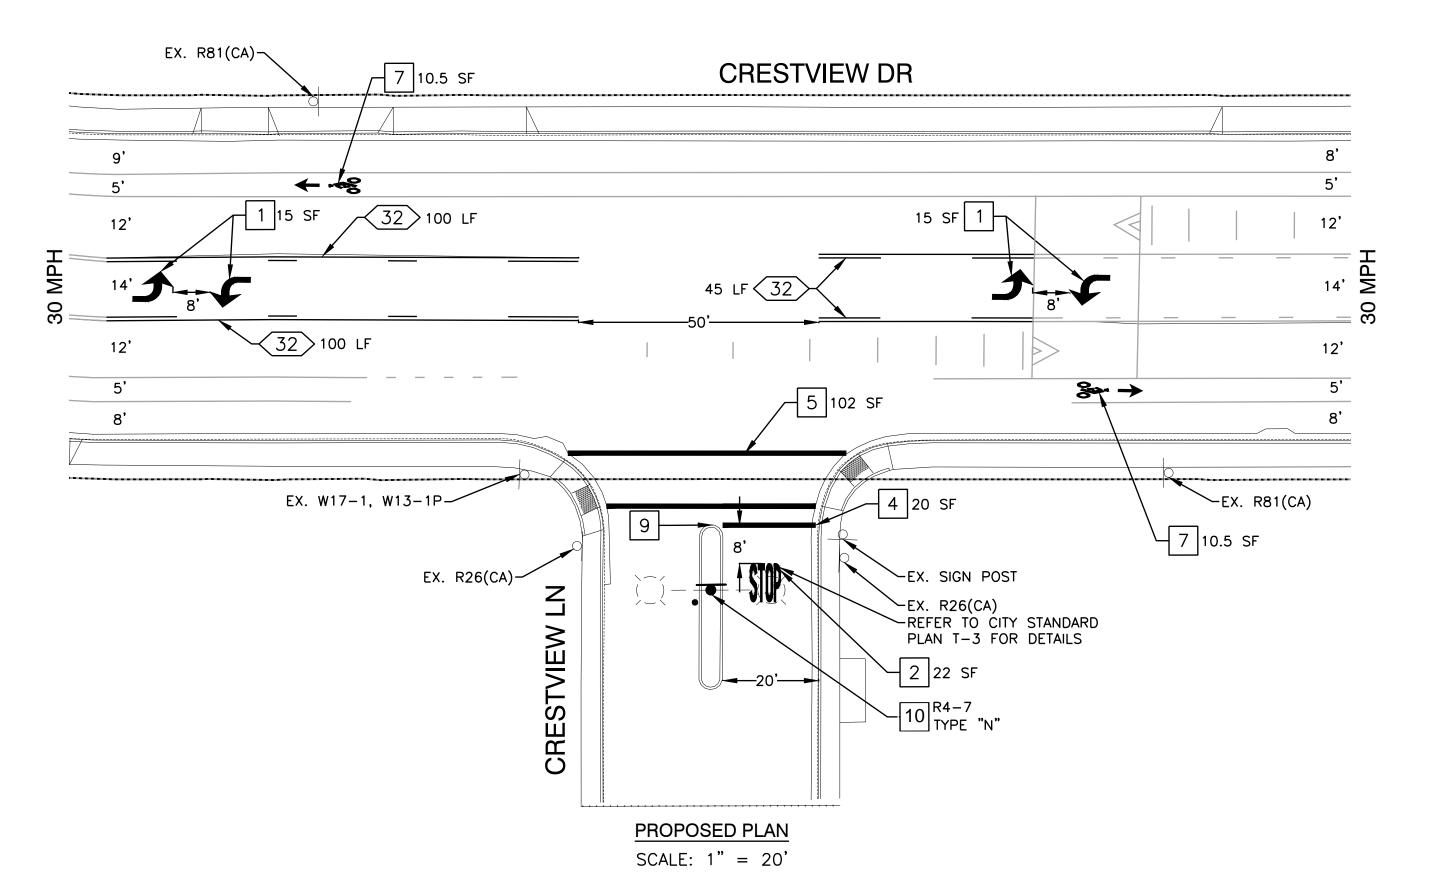

## GENERAL NOTES:

1. SEE SHEET 17 FOR SIGNING AND STRIPING GENERAL NOTES.

## PROJECT NOTES (THIS SHEET ONLY):

- 1 INSTALL THERMOPLASTIC TYPE IV(L) ARROW PER CALTRANS STD PLAN A24A.
- 2 INSTALL THERMOPLASTIC PAVEMENT MARKING LEGEND PER CALTRANS STD PLAN A24D.
- 4 INSTALL 12" WIDE THERMOPLASTIC LIMIT LINE PAVEMENT MARKING PER CITY OF PITTSBURG STANDARD DETAIL T-3.
- INSTALL 12" WHITE WIDE THERMOPLASTIC CROSSWALK STRIPING AT 11' O.C PER CALTRANS STD PLANS.
- 7 INSTALL THERMOPLASTIC BICYCLE MARKING AND BIKE LANE ARROW PER CALTRANS STD PLANS A24A & A24C.
- 9 INSTALL YELLOW REFLECTIVE PAVEMENT MARKERS PER DETAIL A ON SHEET 18.
- 10 FURNISH AND INSTALL NEW SIGN ON NEW POST.

## LEGEND:

--- CITY OF PITTSBURG RIGHT OF WAY

EXISTING SIGN

EXISTING PAVEMENT MARKING

EXISTING STRIPING

# REMOVE EXISTING STRIPING


e Trib

FURNISH AND INSTALL SIGN POST
INSTALL PAVEMENT MARKING

----- INSTALL STRIPING

INSTALL PAVEMENT MARKING TYPE IV(L)

XX'XX STRIPING DETAIL NUMBER AND LENGTH

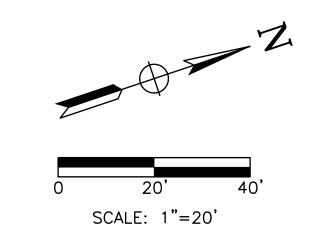

BID SUBMITTAL

FEBRUARY 28, 2024

REV. DATE DESCRIPTION

City of Pittsburg
Public Works Engineering Department
65 Civic Avenue
Pittsburg, CA 94565

CRESTVIEW

Solution Pittsburg

Tel: (925) 252-4930

http://www.ci.pittsburg.ca.us/

CRESTVIEW DRIVE SAFETY IMPROVEMENTS PROJECT HSIPSL-5127(040)

SIGNING AND STRIPING PLANS CRESTVIEW DRIVE AND CRESTVIEW LANE

DRAWN: AD	$\longrightarrow$
CHECKED: RP	POFESSIANIAL PROPERTY OF THE P
CITY ENGINEER:	E to 6/30/25
TRAFFIC ENGINEER:	JANE OF CAL FORME

02/29/24





DATE: FEBRUARY 2024	SHEET
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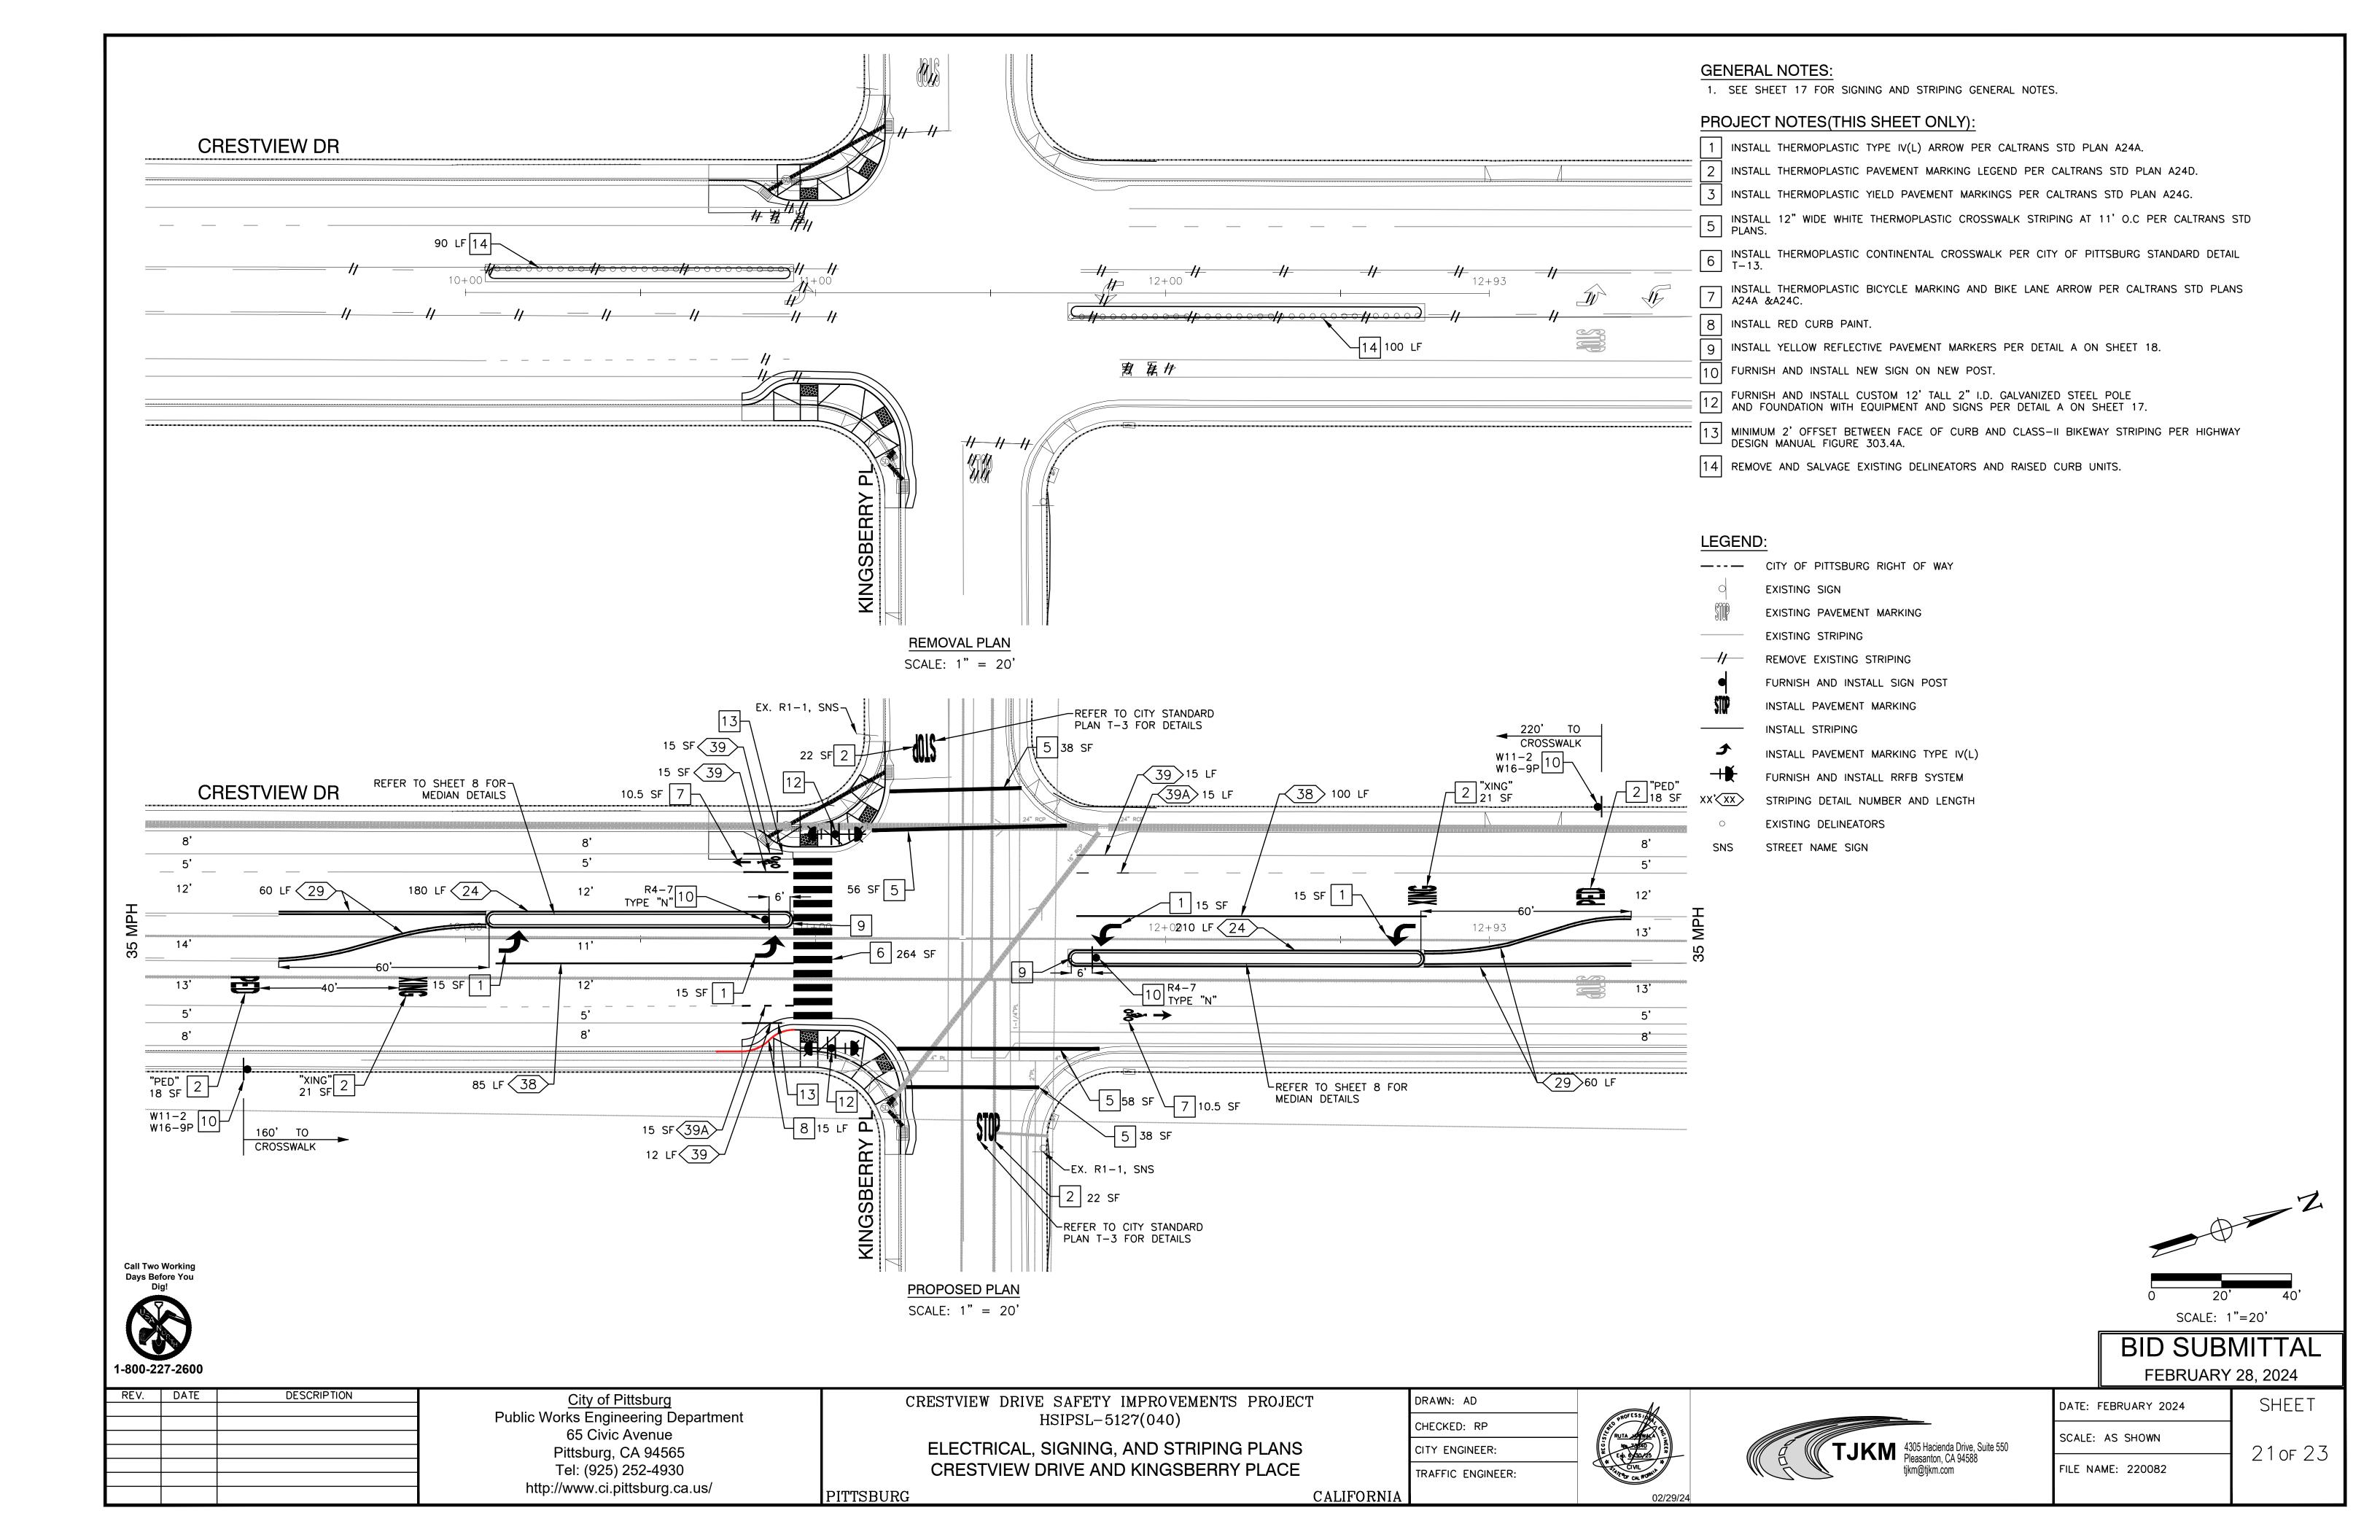
CALIFORNIA


FILE NAME: 220082


18 of 23



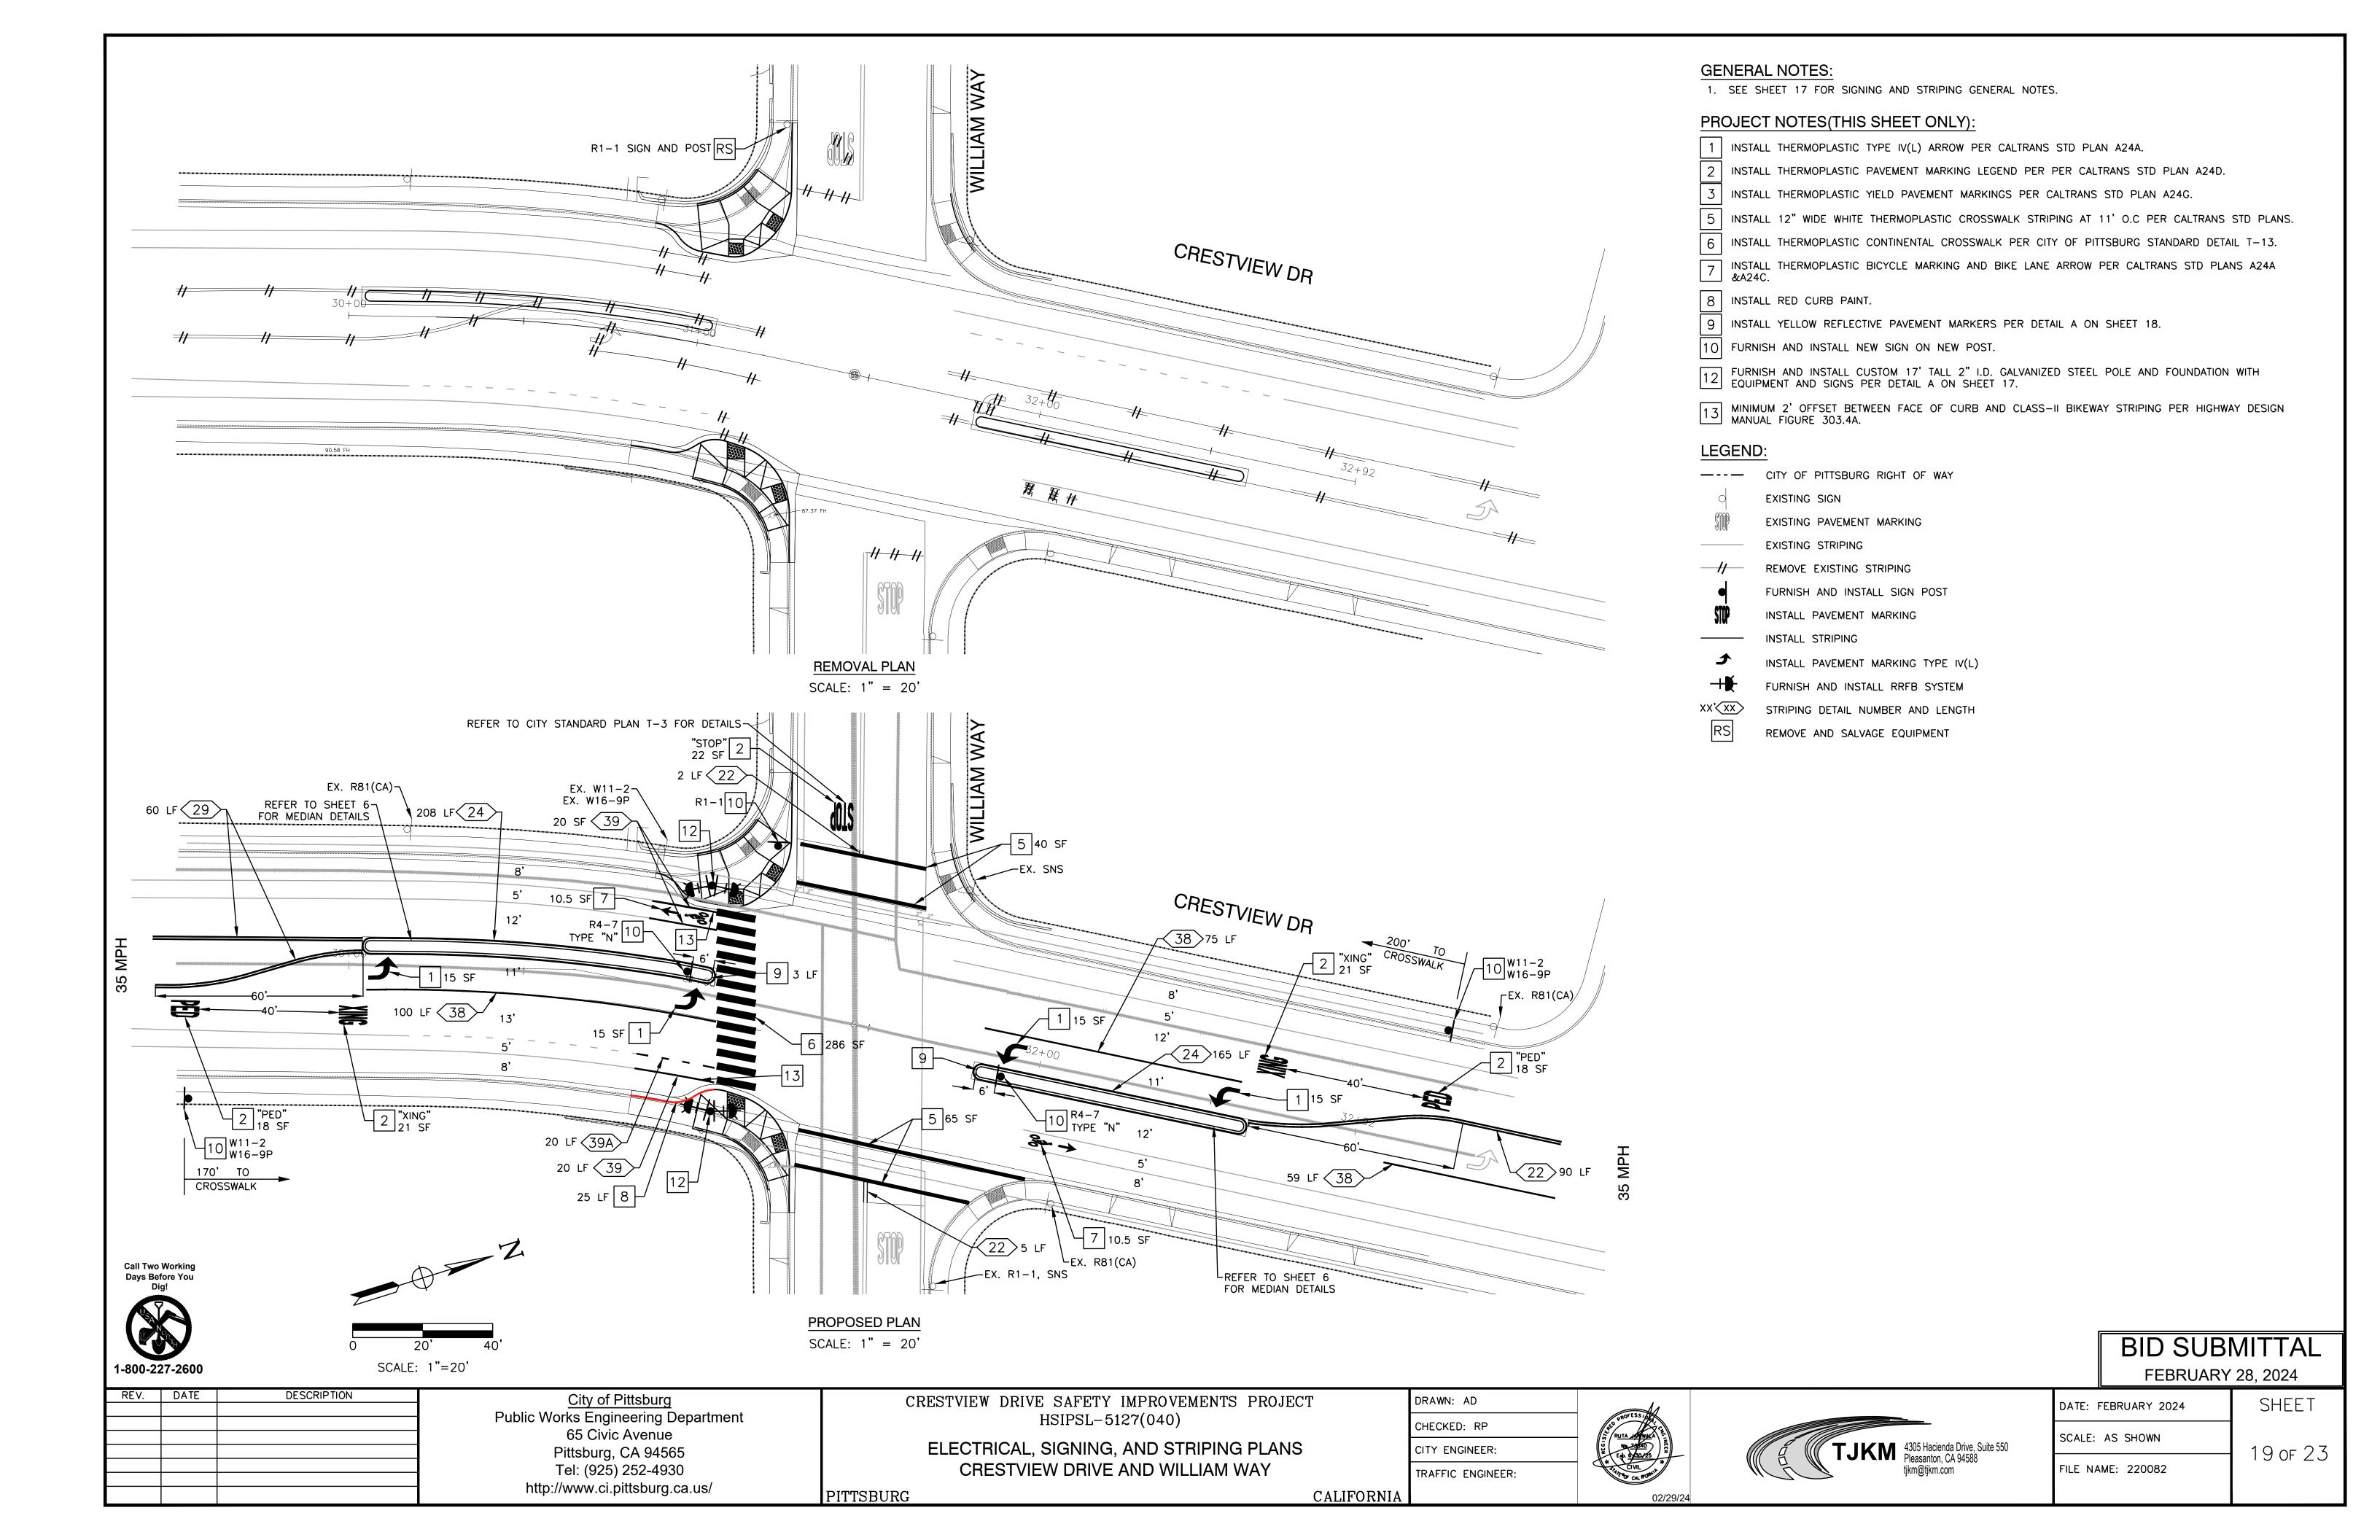


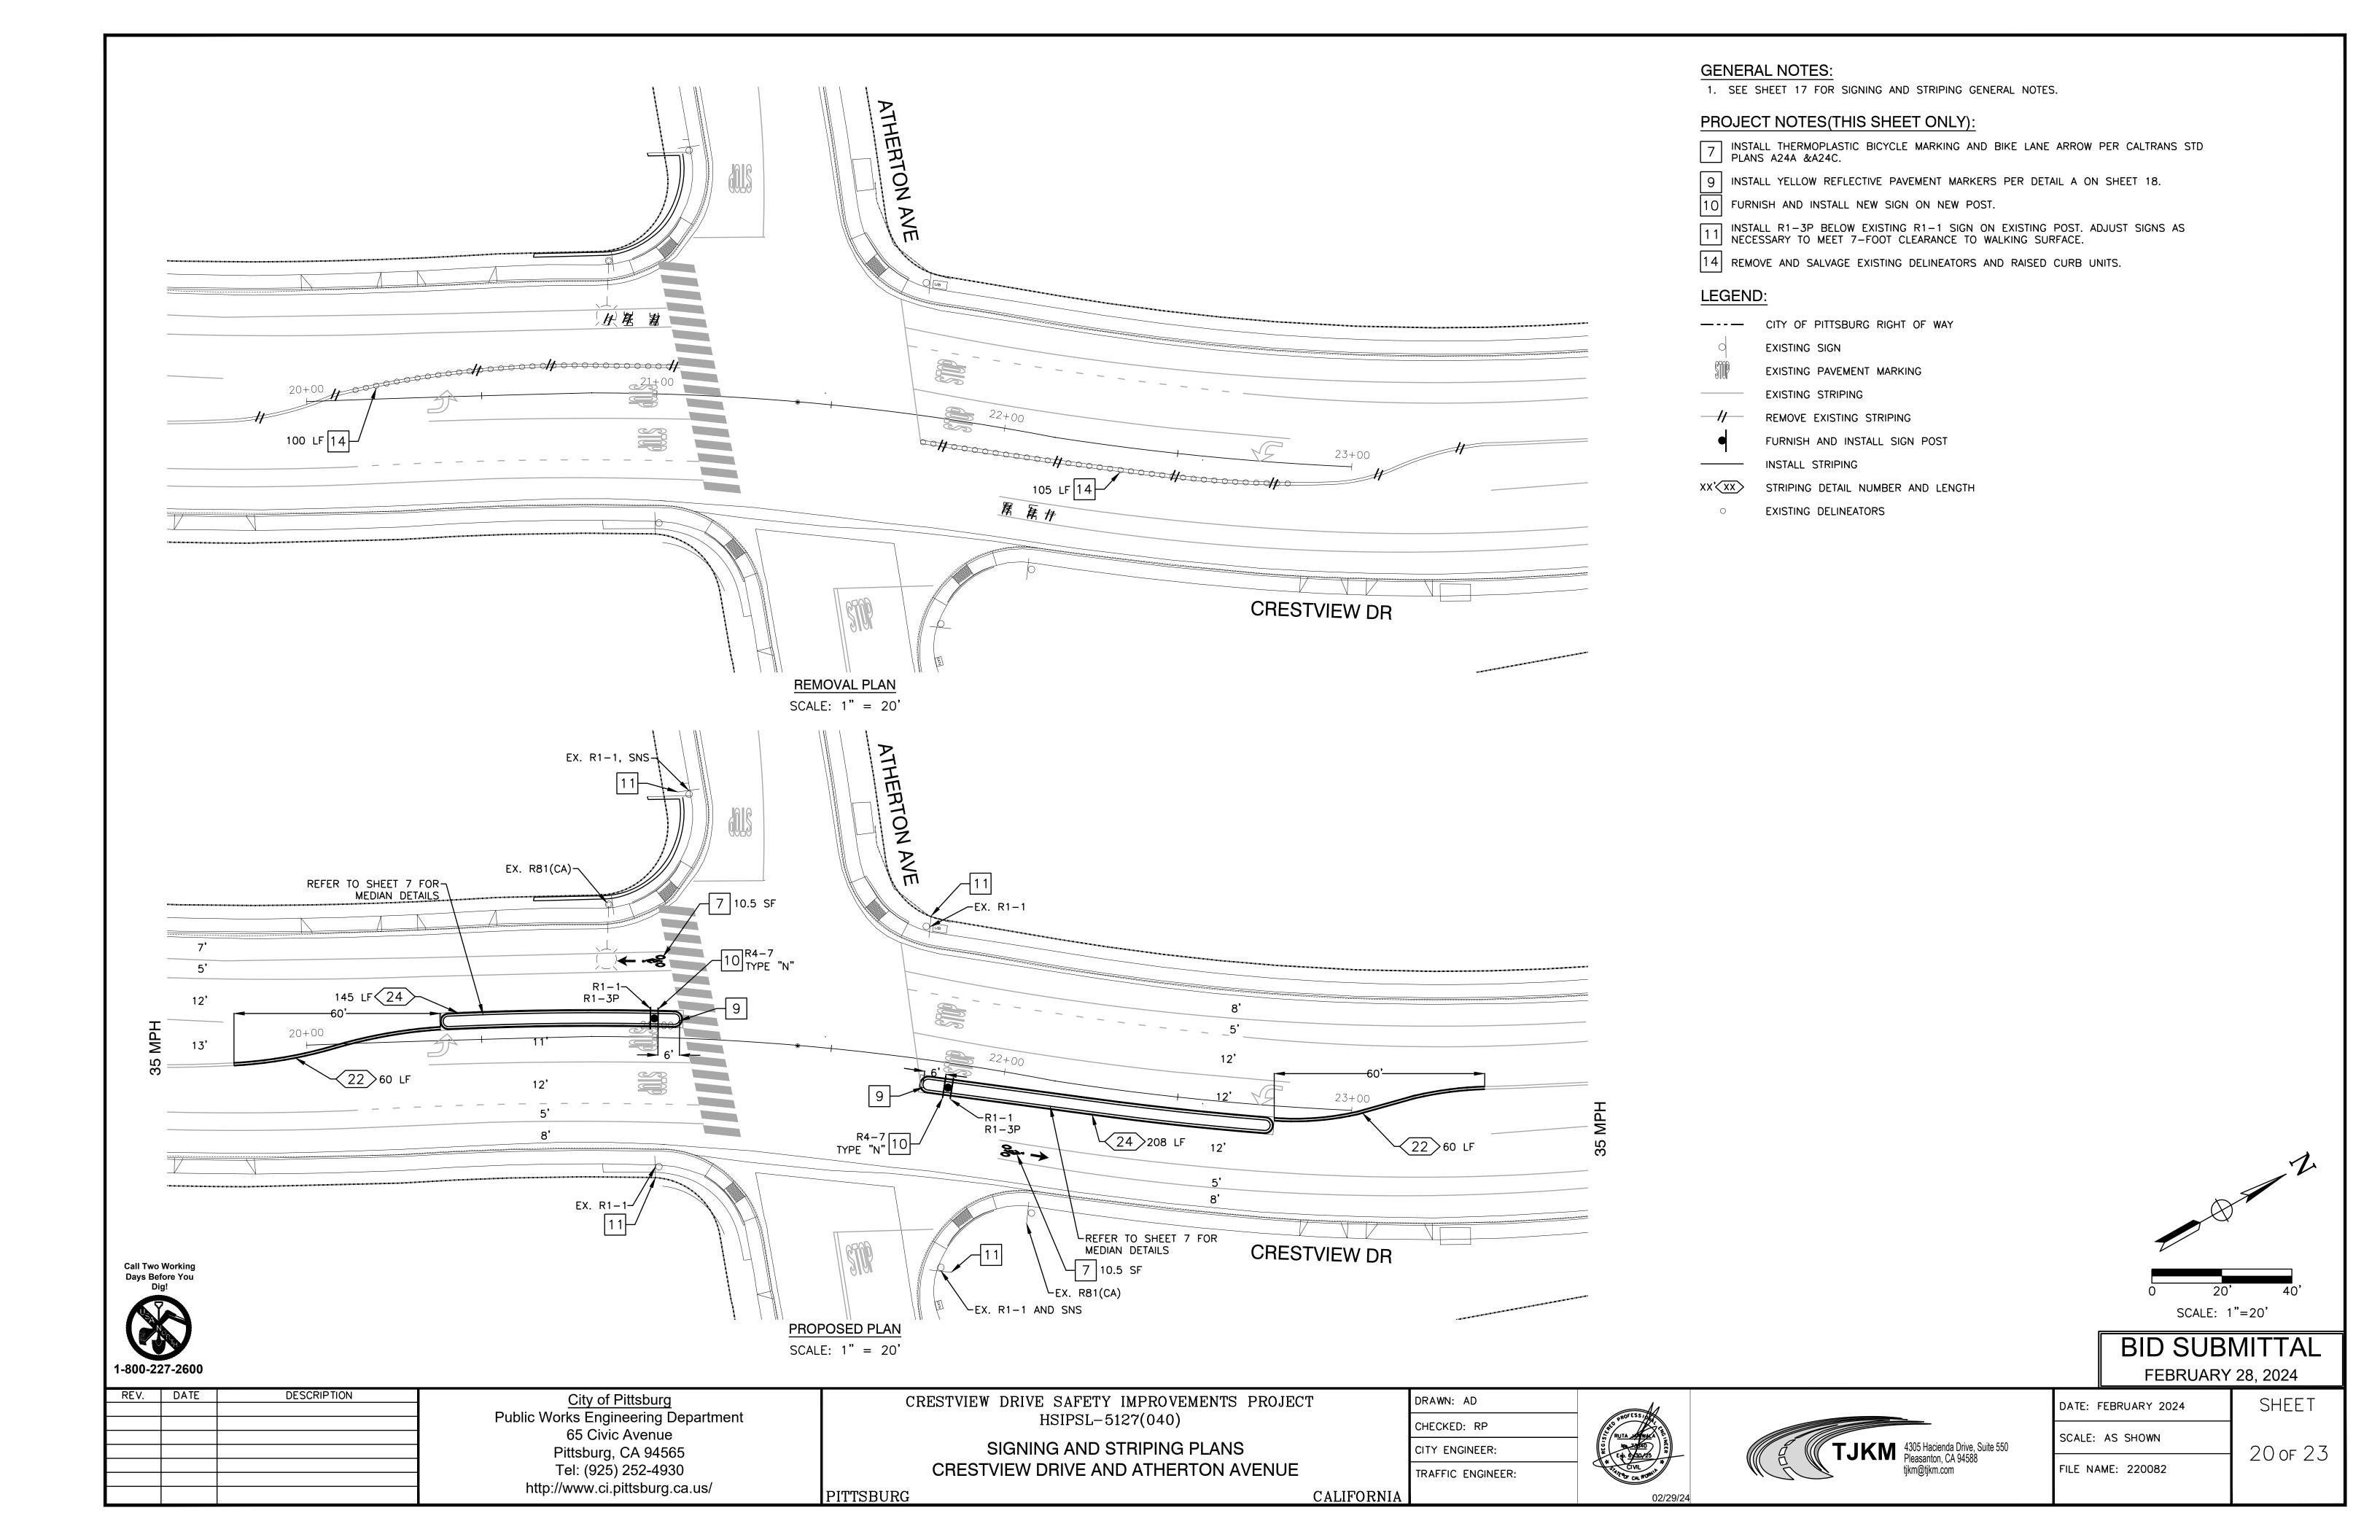

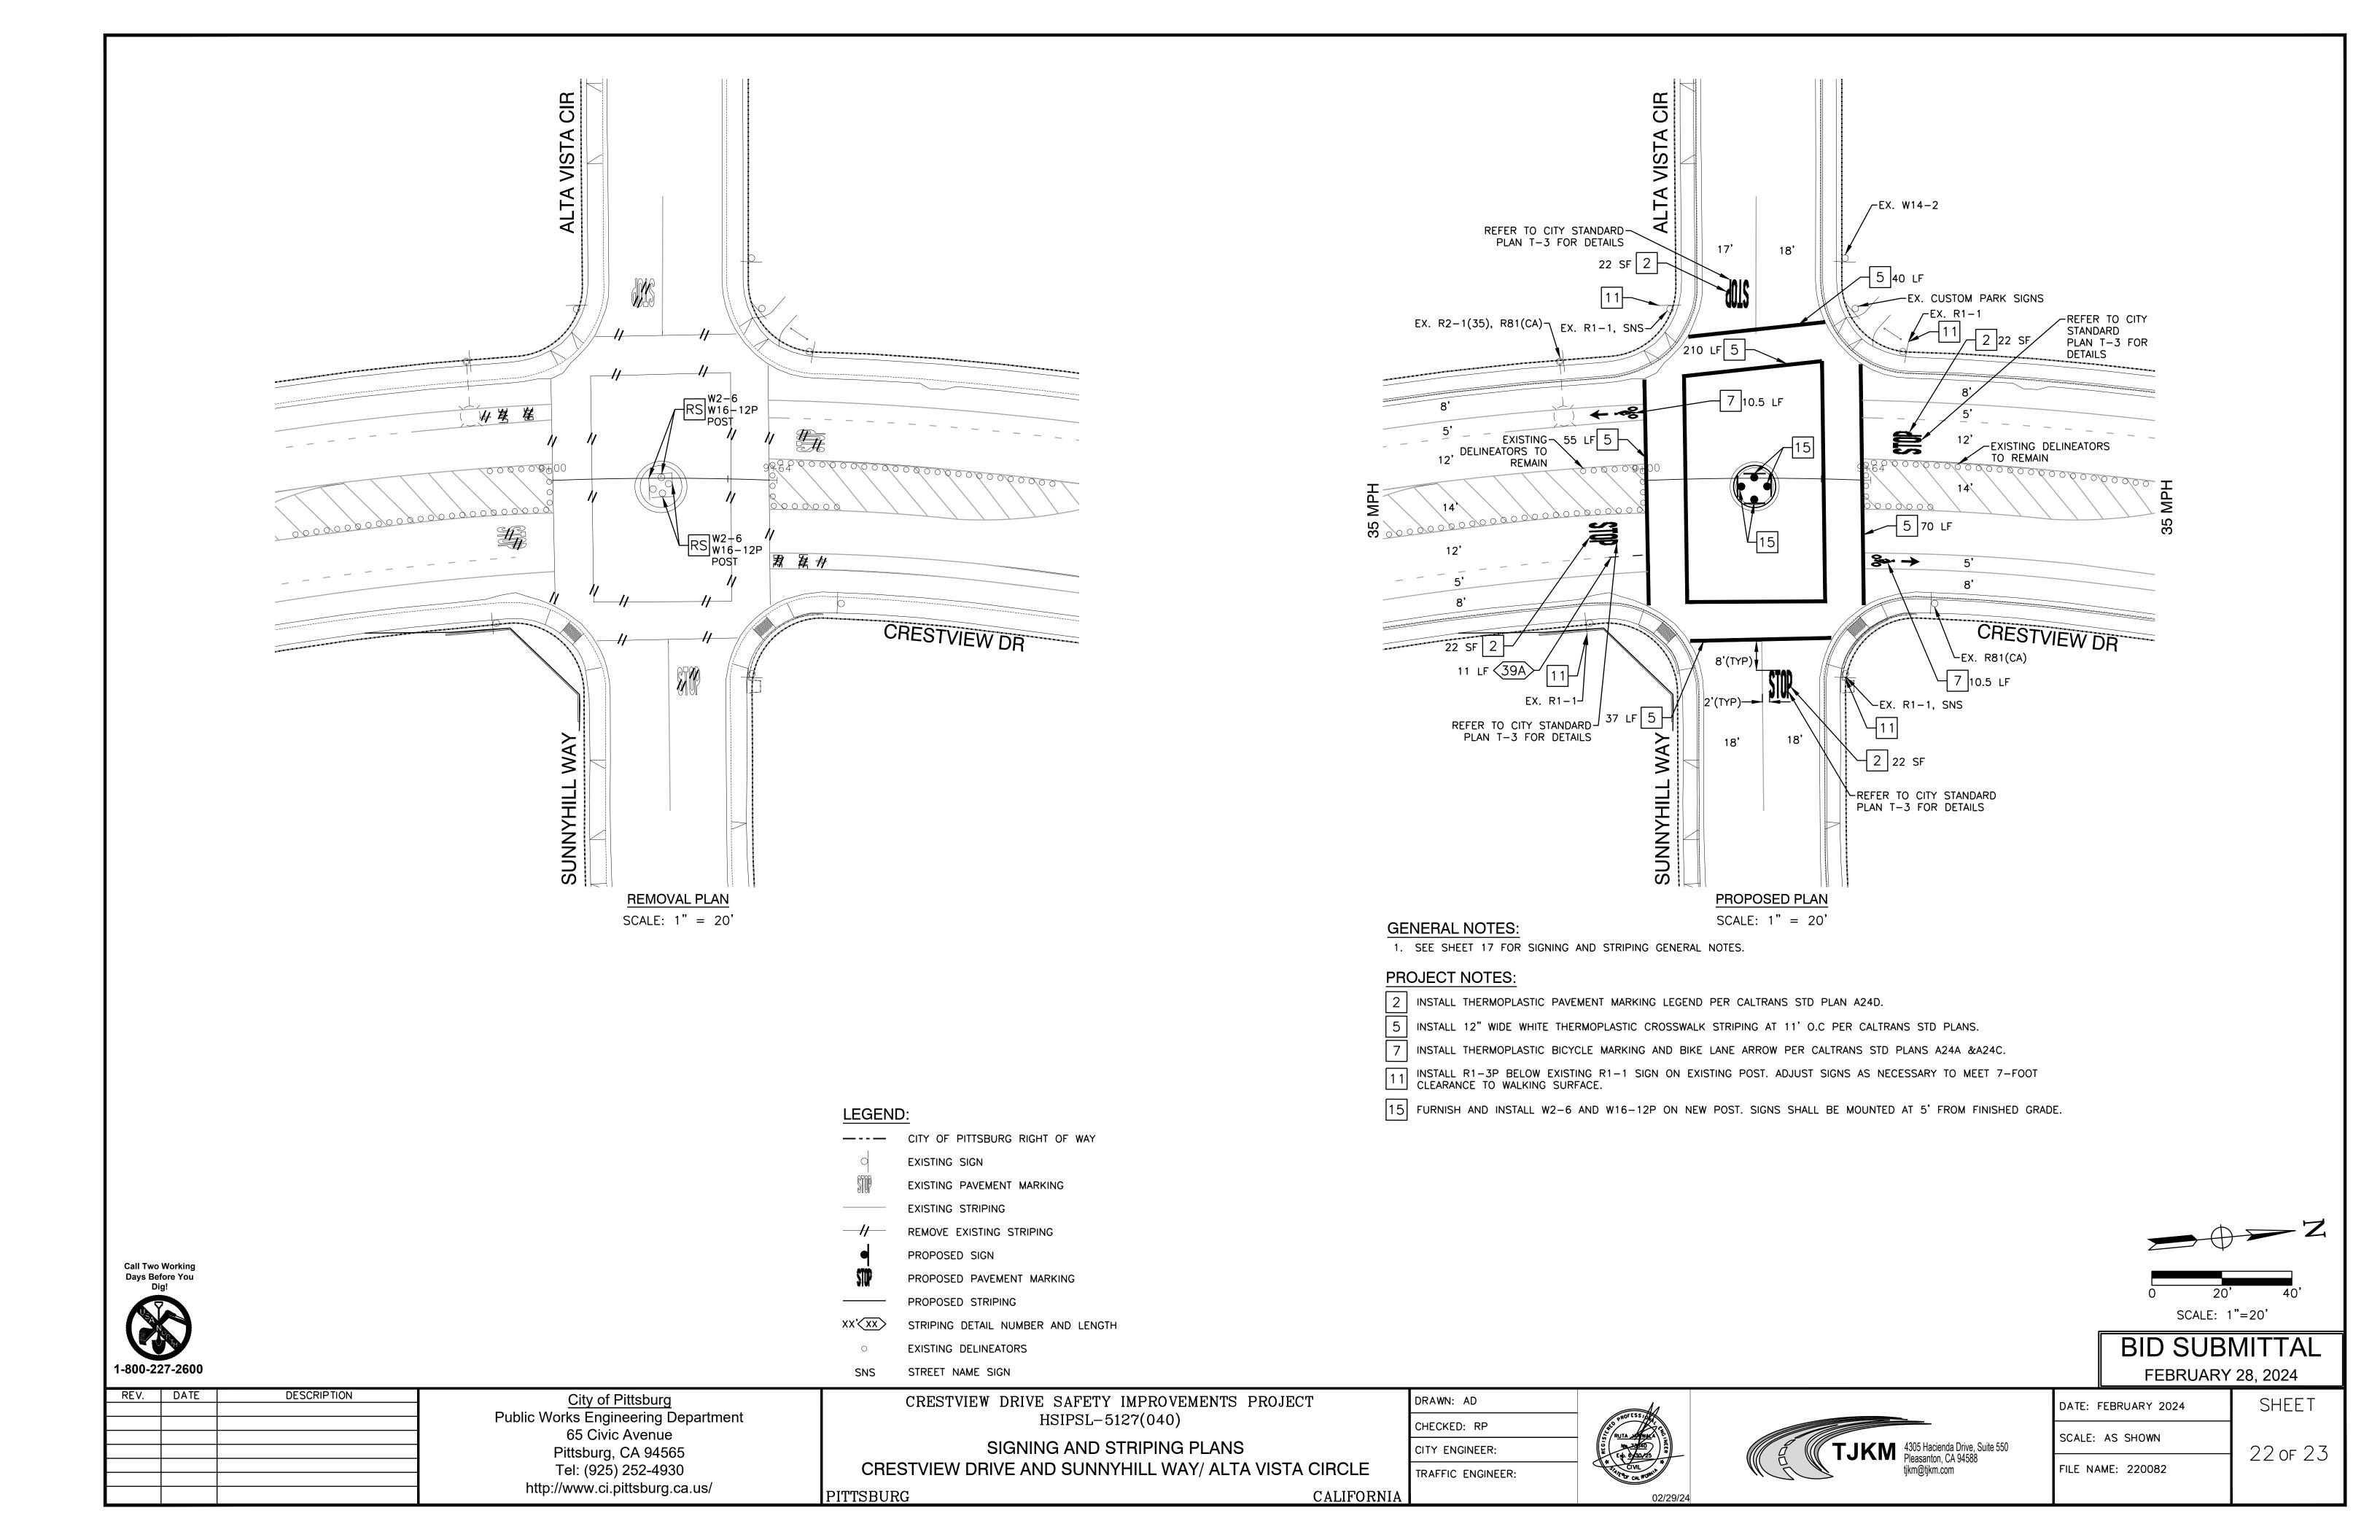

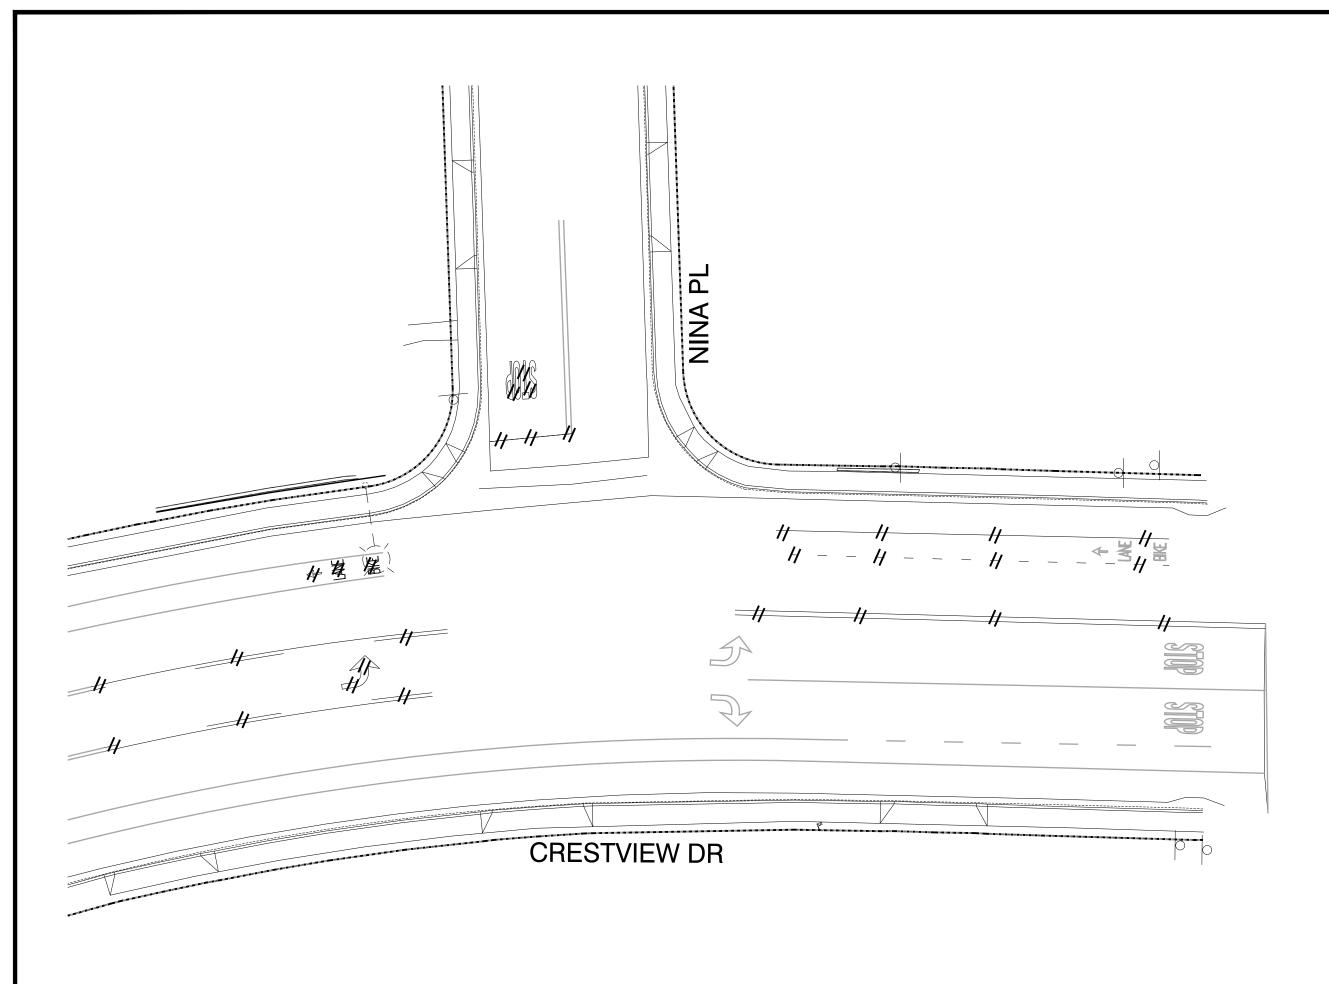

REMOVAL PLAN SCALE: 1" = 20'

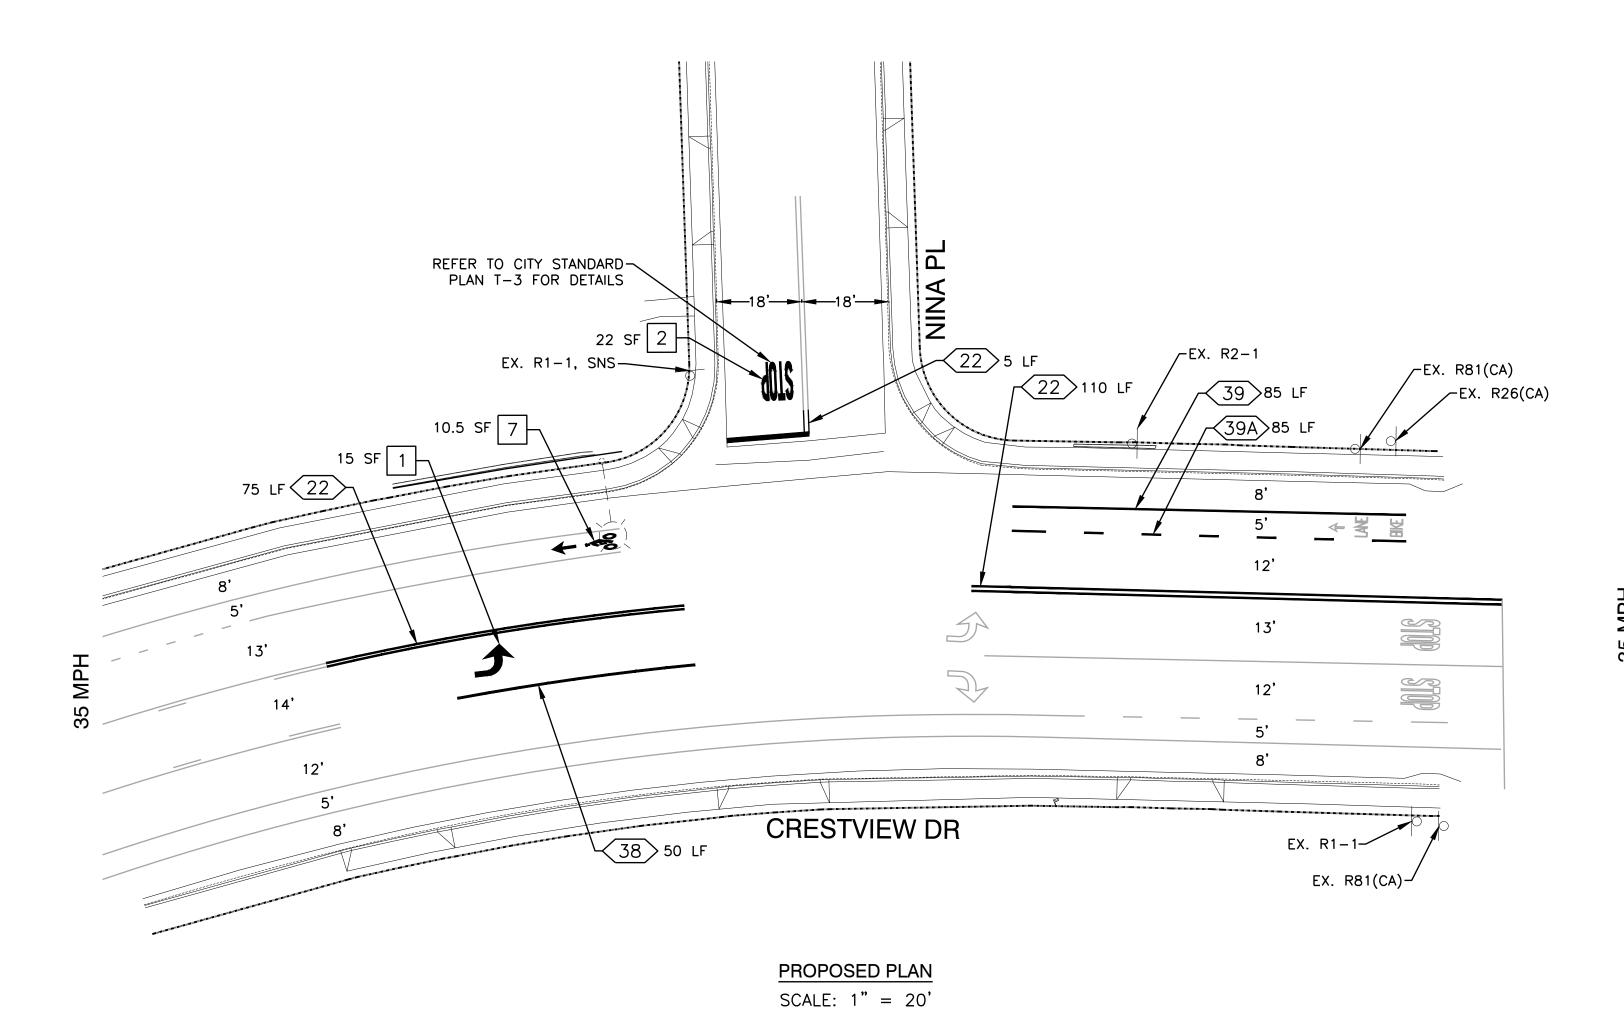

## **GENERAL NOTES:**

1. SEE SHEET 17 FOR SIGNING AND STRIPING GENERAL NOTES.

## PROJECT NOTES:

1 INSTALL THERMOPLASTIC TYPE IV(L) ARROW PER CALTRANS STD PLAN A24A.

7 INSTALL THERMOPLASTIC BICYCLE MARKING AND BIKE LANE ARROW PER CALTRANS STD PLANS A24A &A24C.

## LEGEND:

---- CITY OF PITTSBURG RIGHT OF WAY

EXISTING SIGN

EXISTING PAVEMENT MARKING

EXISTING STRIPING

REMOVE EXISTING STRIPING


PROPOSED SIGN

PROPOSED PAVEMENT MARKING

PROPOSED STRIPING

XX'XX STRIPING DETAIL NUMBER AND LENGTH

CALIFORNIA

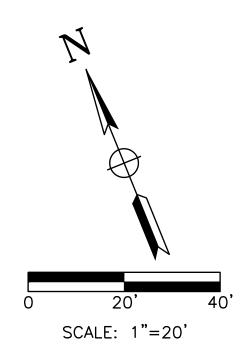

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REV. DATE

**BID SUBMITTAL** 

FEBRUARY 28, 2024

City of Pittsburg Public Works Engineering Department 65 Civic Avenue Pittsburg, CA 94565 Tel: (925) 252-4930 http://www.ci.pittsburg.ca.us/

DESCRIPTION

CRESTVIEW DRIVE SAFETY IMPROVEMENTS PROJECT HSIPSL-5127(040)

> SIGNING AND STRIPING PLANS CRESTVIEW DRIVE AND NINA PLACE

PITTSBURG

CKED: RP	PROFESSIAN RUTA JANNAL
Y ENGINEER:	Est 6/30/25
FFIC ENGINEER:	GIVIL CIVIL



DATE: FEBRUARY 2024	SHEET
SCALE: AS SHOWN	23 of 2
	L Z J OF z