


LEGEND

- SAWCUT AND CONFORM LINE
- RETAINING WALL
- A.C. PAVEMENT
- CONC. VALLEY GUTTER
- CONC. SIDEWALK OR PAD
- 6" CURB & GUTTER
- EDGE OF A.C. PAVEMENT
- 6" VERTICAL CURB
- CENTER LINE
- SANITARY SEWER MAIN
- STORM DRAIN MAIN
- PERFORATED PIPE
- WATER MAIN
- FIRE WATER MAIN
- DOMESTIC WATER MAIN
- CHILLED WATER MAIN
- IRRIGATION LINE
- HOT WATER SUPPLY & RETURN
- STEAM LINE
- TRENCH DRAIN
- CONDENSATE RETURN
- FLOW LINE
- CHAIN LINK FENCE
- GAS MAIN
- ELECTRIC AND SIGNAL DUCT BANK
- OVERHEAD ELECTRIC LINE
- UNDERGROUND ELECTRIC LINE
- STREET LIGHT CONDUIT
- CONTOUR ELEVATION LINE
- SPOT ELEVATION
- DIRECTION OF SLOPE
- GAS METER
- GAS VALVE
- WATER METER
- WATER VALVE
- FIRE HYDRANT
- BACK FLOW PREVENTOR
- POST INDICATOR VALVE
- FIRE DEPARTMENT CONNECTION
- WATER LINE TEE
- CAP AND PLUG END
- AIR RELEASE VALVE
- SIGN
- ACCESSIBLE RAMP
- CONCRETE THRUST BLOCK
- REDUCER
- SANITARY SEWER MANHOLE
- SANITARY SEWER CLEANOUT
- STORM DRAIN MANHOLE
- STORM DRAIN AREA DRAIN
- STORM DRAIN CATCH BASIN
- STORM DRAIN CURB INLET
- STORM DRAIN CLEANOUT
- ELECTROLYER
- JOINT POLE
- OVERLAND RELEASE

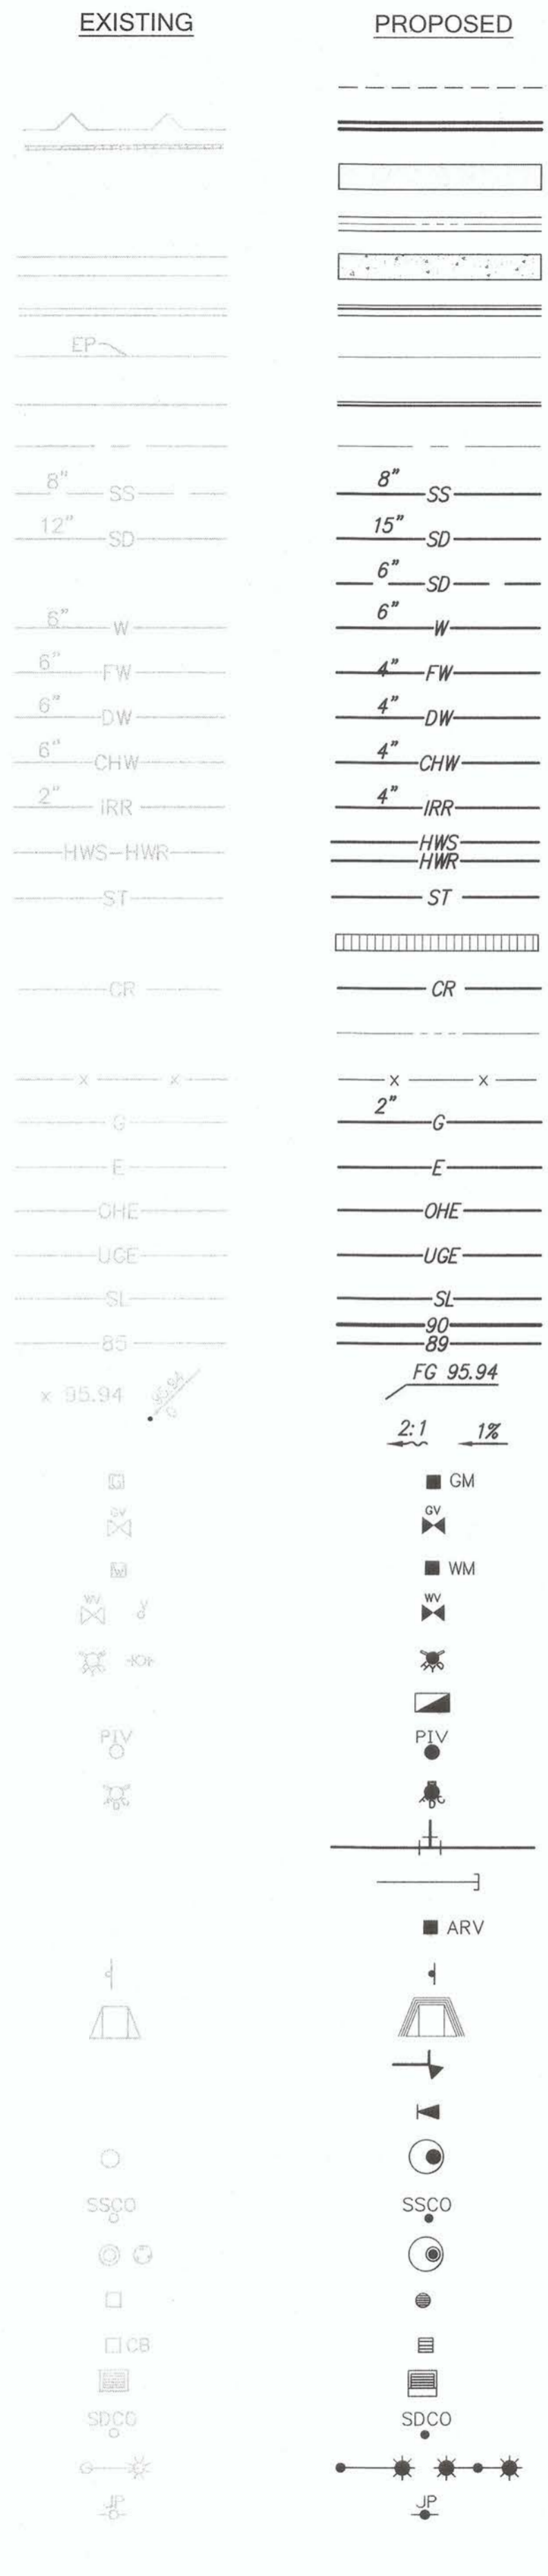

15
C5.2


DETAIL REFERENCE SHEET REFERENCE

ABBREVIATIONS

- AB - AGGREGATE BASE
- AC - ASPHALT CONCRETE
- AD - AREA DRAIN
- ADA - AMERICANS WITH DISABILITIES ACT
- ASB - AGGREGATE SUBBASE
- BC - BEGINNING OF CURVE
- BFP - BACK FLOW PREVENTOR
- BLDC - BUILDING CORNER
- BLDG - BUILDING
- BOL - BOTTOM OF DOCK
- BOLL - BOLLARD
- BOS - BOTTOM OF STEP
- BOW - FG @ BOTTOM OF WALL
- BVC - BEGIN VERTICAL CURVE
- BW - BACK OF WALK
- C - CONCRETE OR CIVIL
- C&G - CURB AND GUTTER
- CB - CATCH BASIN
- CI - COMBINATION INLET
- CIP - CAST IRON PIPE
- CL - CENTER LINE OR CLASS
- CMP - CORRUGATED METAL PIPE
- CO - CLEANOUT
- COI - CURB OPENING INLET
- CONC - CONCRETE
- CONST - CONSTRUCTION OR CONSTRUCT
- CY - CUBIC YARD
- DCDA - DOUBLE CHECK DETECTOR ASSEMBLY
- DI - DROP INLET
- DIP - DUCTILE IRON PIPE
- DOM - DOMESTIC
- DW - DOMESTIC WATER
- DWG - DRAWING
- E - EAST
- EC - END OF CURVE
- EP - EDGE OF PAVEMENT
- ER - END OF RETURN
- EVC - END VERTICAL CURVE
- ELEV - ELEVATION
- EX., EXIST. - EXISTING
- FC - FACE OF CURB
- FDC - FIRE DEPARTMENT CONNECTION
- FF - FINISHED FLOOR
- FG - FINISHED GRADE
- FH - FIRE HYDRANT
- FL - FLOW LINE
- FOUND - FOUNDATION
- FS - FINISHED SURFACE
- FT - FOOT
- FW - FIRE WATER
- G - GROUND ELEVATION
- GB - GRADE BREAK
- GV - GATE VALVE
- HCR - ACCESSIBLE RAMP
- HP - HIGH POINT
- INV - INVERT ELEVATION
- JP - JOINT POLE
- JT - JOINT TRENCH
- LIP - LIP OF GUTTER
- LP - LOW POINT
- LSA - LANDSCAPE ARCHITECT
- MAX - MAXIMUM
- MEP - MECHANICAL/ELECTRICAL/PLUMBING
- MH - MANHOLE
- MIN - MINIMUM
- MPCV - MIDPOINT OF VERTICAL CURVE
- MON - MONUMENT
- N - NORTH
- N.I.C. - NOT IN CONTRACT
- NO - NUMBER
- NTS - NOT TO SCALE
- P - PAVEMENT ELEVATION
- PCC - PORTLAND CEMENT CONCRETE / POINT OF CONTINUOUS CURVATURE
- PIV - POST INDICATOR VALVE
- PL - PROPERTY LINE
- PMH - POWER MANHOLE
- POC - POINT ON CURVE
- PP - POWER POLE
- PRC - POINT OF REVERSE CURVATURE
- PVC - POLYVINYL CHLORIDE PIPE
- R - RADIUS
- RC - RELATIVE COMPACTION
- RCP - REINFORCED CONCRETE PIPE
- RPPA - REDUCED PRESSURE PRINCIPLE ASSEMBLY
- R/W - RIGHT OF WAY
- S - SLOPE OR SOUTH
- S.A.D. - SEE ARCHITECTURAL DRAWINGS
- SB - SEDIMENT BASIN
- SD - STORM DRAIN
- S.E.D. - SEE ELECTRICAL DRAWINGS
- SF - SILT FENCE
- SG - SUBGRADE
- S.L.D. - SEE LANDSCAPE DRAWINGS
- S.M.D. - SEE MECHANICAL DRAWINGS
- SMH - SIGNAL MANHOLE
- S.P.D. - SEE PLUMBING DRAWINGS
- SS - SANITARY SEWER
- STA - STATION
- STD - STANDARD
- S/W - SIDEWALK
- TC - TOP OF CURB
- TD - TRENCH DRAIN
- TOD - TOP OF DOCK
- TOE - TOE OF SLOPE
- TOS - TOP OF STAIR
- TOW - FG @ TOP OF WALL
- TS - TOP OF SLAB
- TYP - TYPICAL
- UON - UNLESS OTHERWISE NOTED
- U/G - UNDERGROUND
- VC - VERTICAL CURVE
- WM - WATER METER
- WV - WATER VALVE
- W - WEST
- WWF - WELDED WIRE FABRIC
- W/ - WITH

FRONTAGE ROAD LIVING GREEN TRAIL DESIGN

100% DESIGN
PITTSBURG, CA

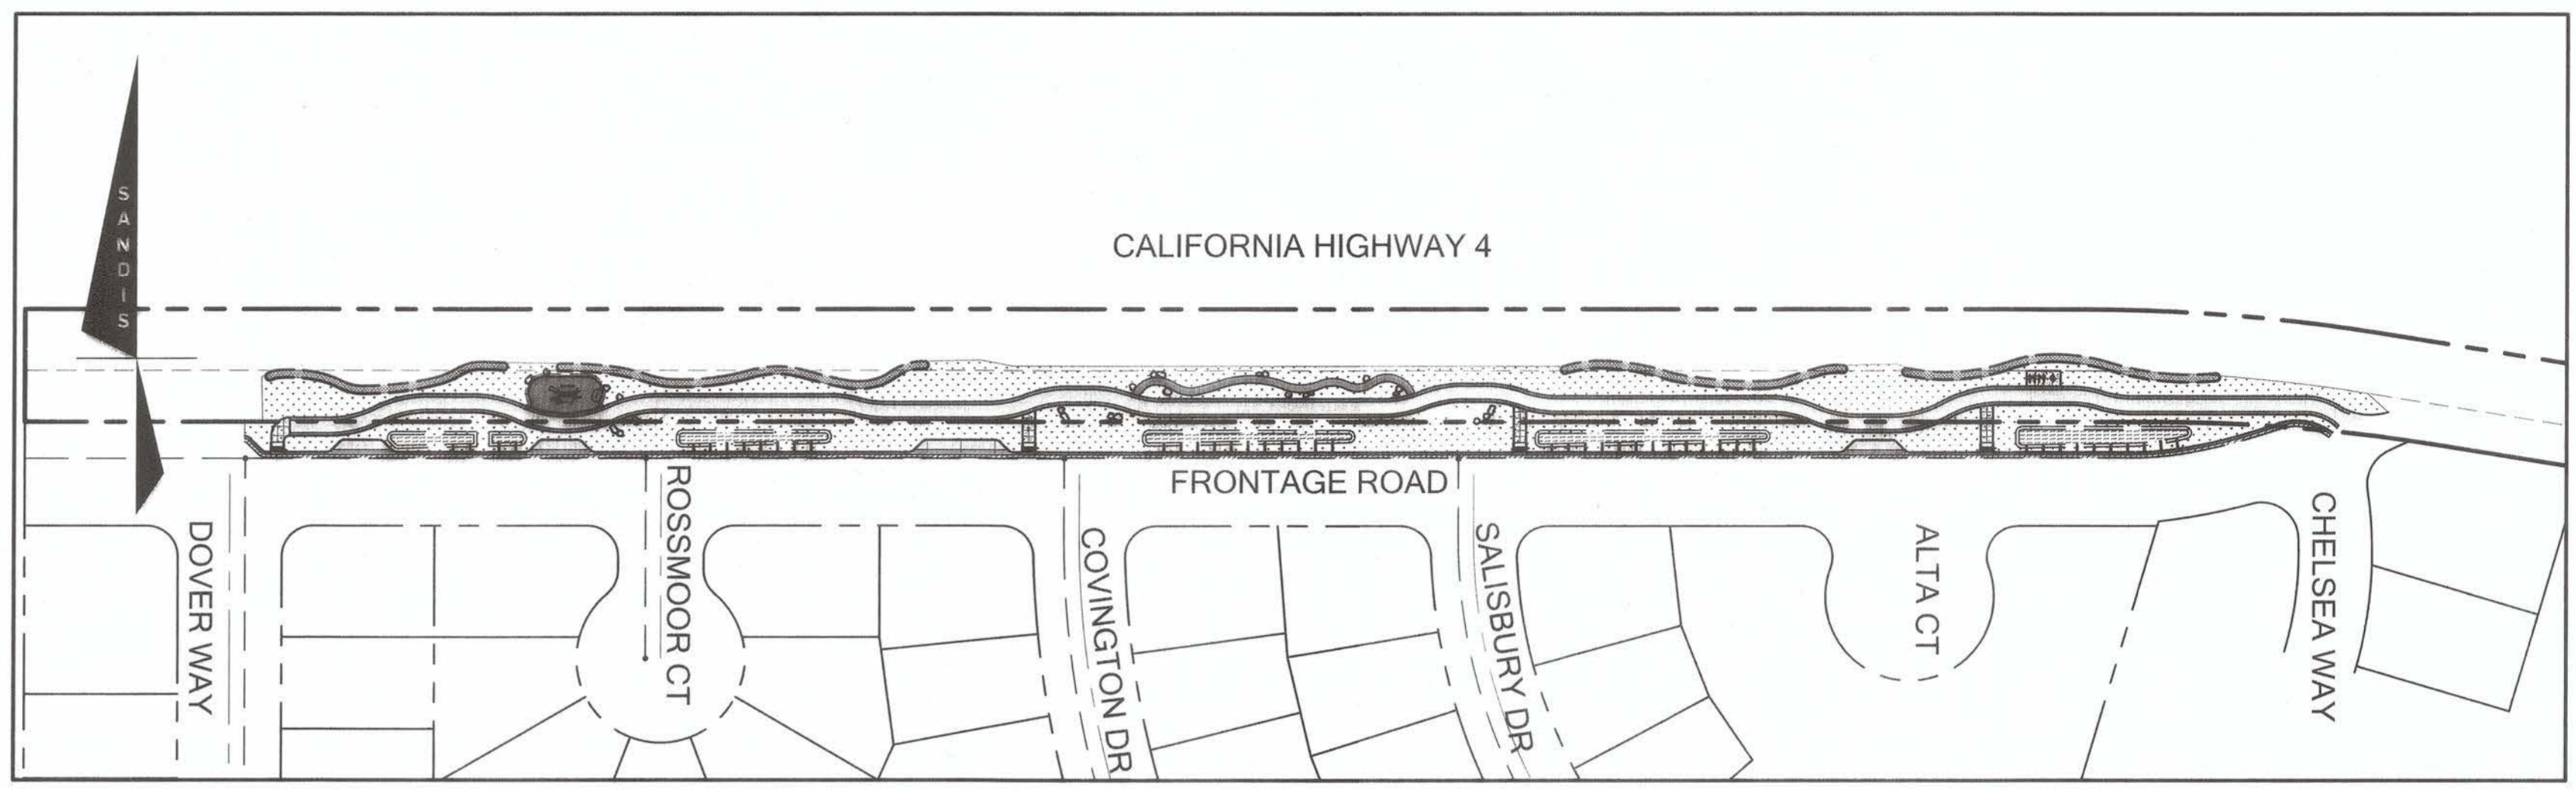

PROJECT DESCRIPTION

THIS PROJECT PROPOSES TO CONSTRUCT A MULTI-USE PATH AND STORMWATER TREATMENT.

OWNER INFO

CITY OF PITTSBURG
CONTACT PERSON: JOLAN LONGWAY
65 CIVIC AVENUE
PITTSBURG, CA 94565
PH: (925) 252-4803
EMAIL: JLONGWAY@PITTSBURGCA.GOV

SHEET INDEX

C	C	L	NOTES AND LEGEND
C-1.0	COVER SHEET	L1.01	PLANTING NOTES AND LEGEND
C-1.1	CONSTRUCTION NOTES	L1.02	LAYOUT PLAN
C-2.0	TOPOGRAPHIC SURVEY	L2.01	LAYOUT PLAN - ADD ALT
C-2.1	TOPOGRAPHIC SURVEY	L2.01A	LAYOUT PLAN
C-3.0	OVERALL SITE PLAN	L2.02	LAYOUT PLAN
C-4.0	DEMOLITION PLAN	L2.03	LAYOUT PLAN
C-4.1	DEMOLITION PLAN	L2.04	LAYOUT PLAN
C-4.2	DEMOLITION PLAN	L2.05	LAYOUT PLAN
C-4.3	DEMOLITION PLAN	L2.06	LAYOUT PLAN
C-5.0	GRADING AND DRAINAGE PLAN	L3.01	IRRIGATION PLAN
C-5.1	GRADING AND DRAINAGE PLAN	L3.02	IRRIGATION PLAN
C-5.2	GRADING AND DRAINAGE PLAN	L3.03	IRRIGATION PLAN
C-5.3	GRADING AND DRAINAGE PLAN	L3.04	IRRIGATION PLAN
C-6.0	UTILITY PLAN	L3.05	IRRIGATION PLAN
C-6.1	UTILITY PLAN	L3.06	IRRIGATION PLAN
C-6.2	UTILITY PLAN	L3.07	IRRIGATION NOTES AND LEGEND
C-6.3	UTILITY PLAN	L3.08	IRRIGATION DETAILS
C-7.0	STORMWATER MANAGEMENT PLAN	L3.09	IRRIGATION DETAILS
C-8.0	CONSTRUCTION DETAILS	L3.10	IRRIGATION WATER CALCULATIONS
C-8.1	CONSTRUCTION DETAILS	L4.01	PLANTING PLAN
C-8.2	CONSTRUCTION DETAILS	L4.02	PLANTING PLAN
C-8.3	CONSTRUCTION DETAILS	L4.03	PLANTING PLAN
C-9.0	SIGNAGE AND STRIPING PLAN	L4.04	PLANTING PLAN
C-10.0	EROSION CONTROL PLAN	L4.05	PLANTING PLAN
C-10.1	EROSION CONTROL DETAILS	L4.06	PLANTING PLAN
C-11.0	LIGHTING PLAN	L5.01	PLANTING DETAILS
C-11.1	LIGHTING PLAN	L5.02	CONSTRUCTION DETAILS
C-11.2	LIGHTING PLAN	L5.03	CONSTRUCTION DETAILS
C-11.3	LIGHTING PLAN	L5.04	CONSTRUCTION DETAILS
		L5.05	CONSTRUCTION DETAILS


KEY MAP

1"=100'

EARTHWORK QUANTITIES

CUT 2,400 CY
FILL 200 CY
BALANCE 2,200 CY EXPORT

THE EARTHWORK QUANTITIES SHOWN ARE PROVIDED FOR THE PURPOSE OF GRADING PERMIT APPROVAL ONLY. IT SHALL BE THE CONTRACTOR'S RESPONSIBILITY TO CARRY OUT THE CUT/FILL, IMPORT/EXPORT AS NECESSARY TO MEET THE DESIGN GRADES AS SHOWN ON THE PLANS REGARDLESS OF THE ESTIMATED EARTHWORK QUANTITIES AS INDICATED. SIGNIFICANT REVISIONS TO THE QUANTITIES NEED REVIEW BY THE CITY OF PITTSBURG. FILL SHORTAGE IS ANTICIPATED TO COME FROM ON-SITE SPOILS ACQUIRED FROM UTILITY TRENCHES AND FOOTING SPOILS.

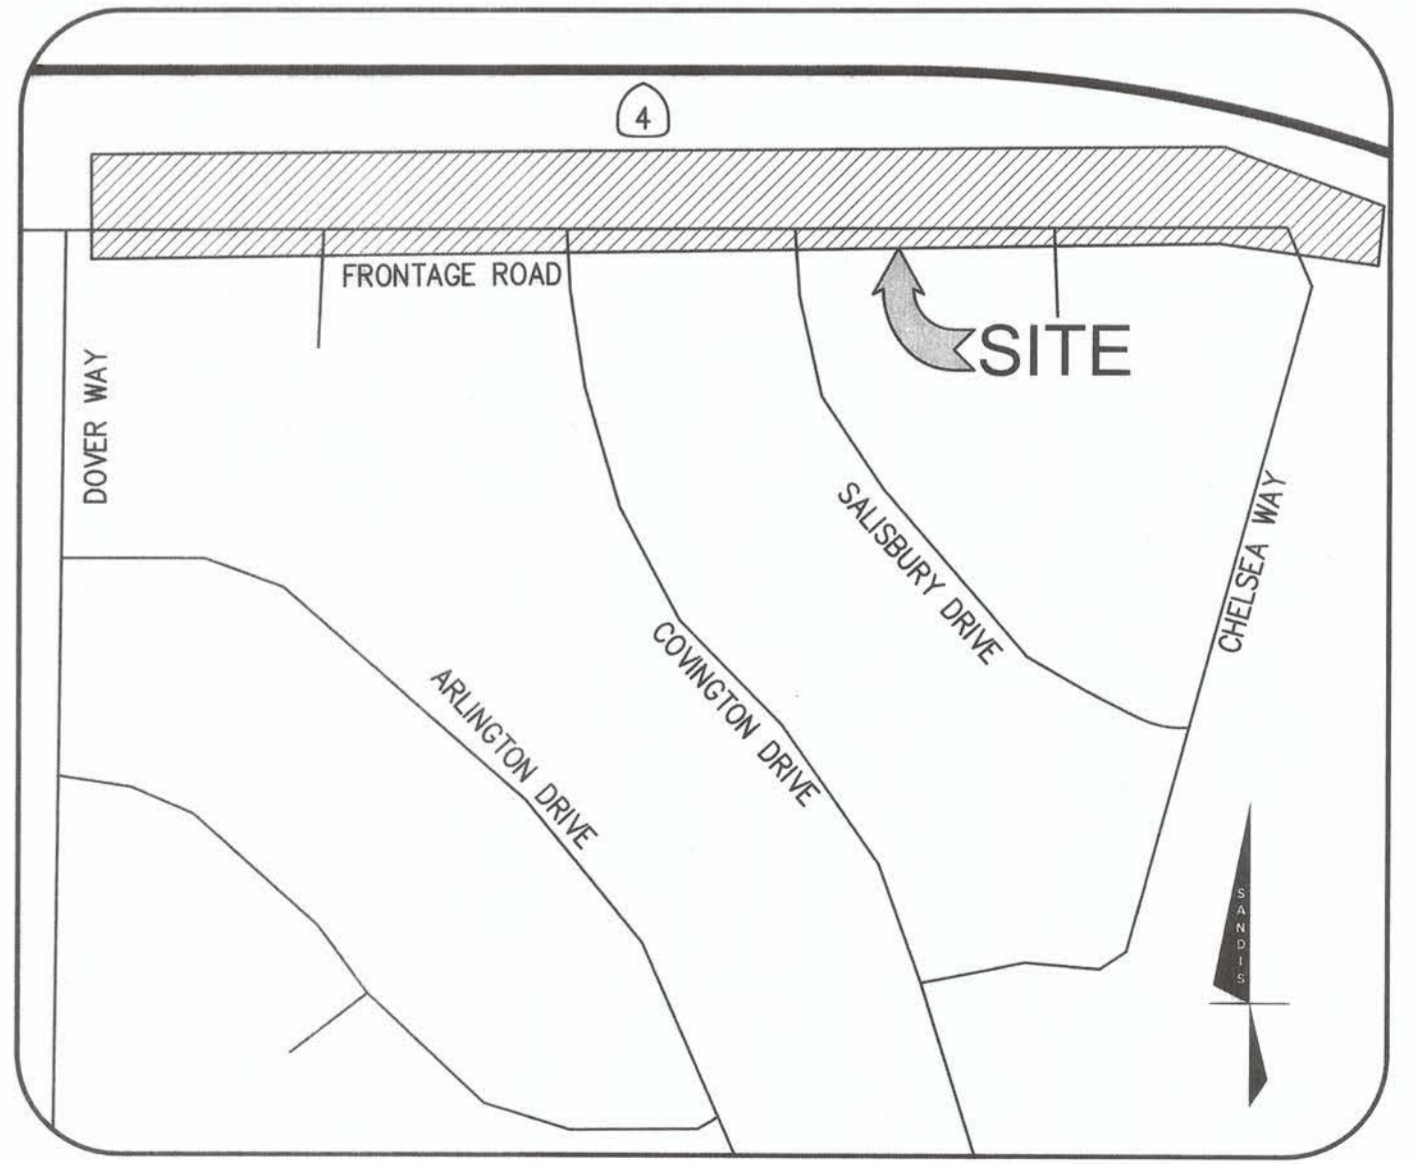

VICINITY MAP

N.T.S.

UNAUTHORIZED CHANGES AND USES

CAUTION: THE ENGINEER PREPARING THESE PLANS WILL NOT BE RESPONSIBLE FOR, OR LIABLE FOR, UNAUTHORIZED CHANGES TO OR USES OF THESE PLANS. ALL CHANGES TO THE PLANS MUST BE IN WRITING AND MUST BE APPROVED BY THE PREPARER OF THE PLANS.



PREPARED UNDER THE DIRECTION OF:
Chad J. Browning
DATE: 9/20/23

ACCEPTED FOR USE:
John Samuelson
City Engineer
DATE: 9/24/23

CHAD J. BROWNING
P.E. No. 68315
EXPIRES: 9-30-25




FRONTAGE ROAD LIVING GREEN TRAIL DESIGN COVER SHEET

DATE	REV	DESCRIPTION	BY	SCALE

SHEET NO. 1 OF 59
DWG. NO. C-10



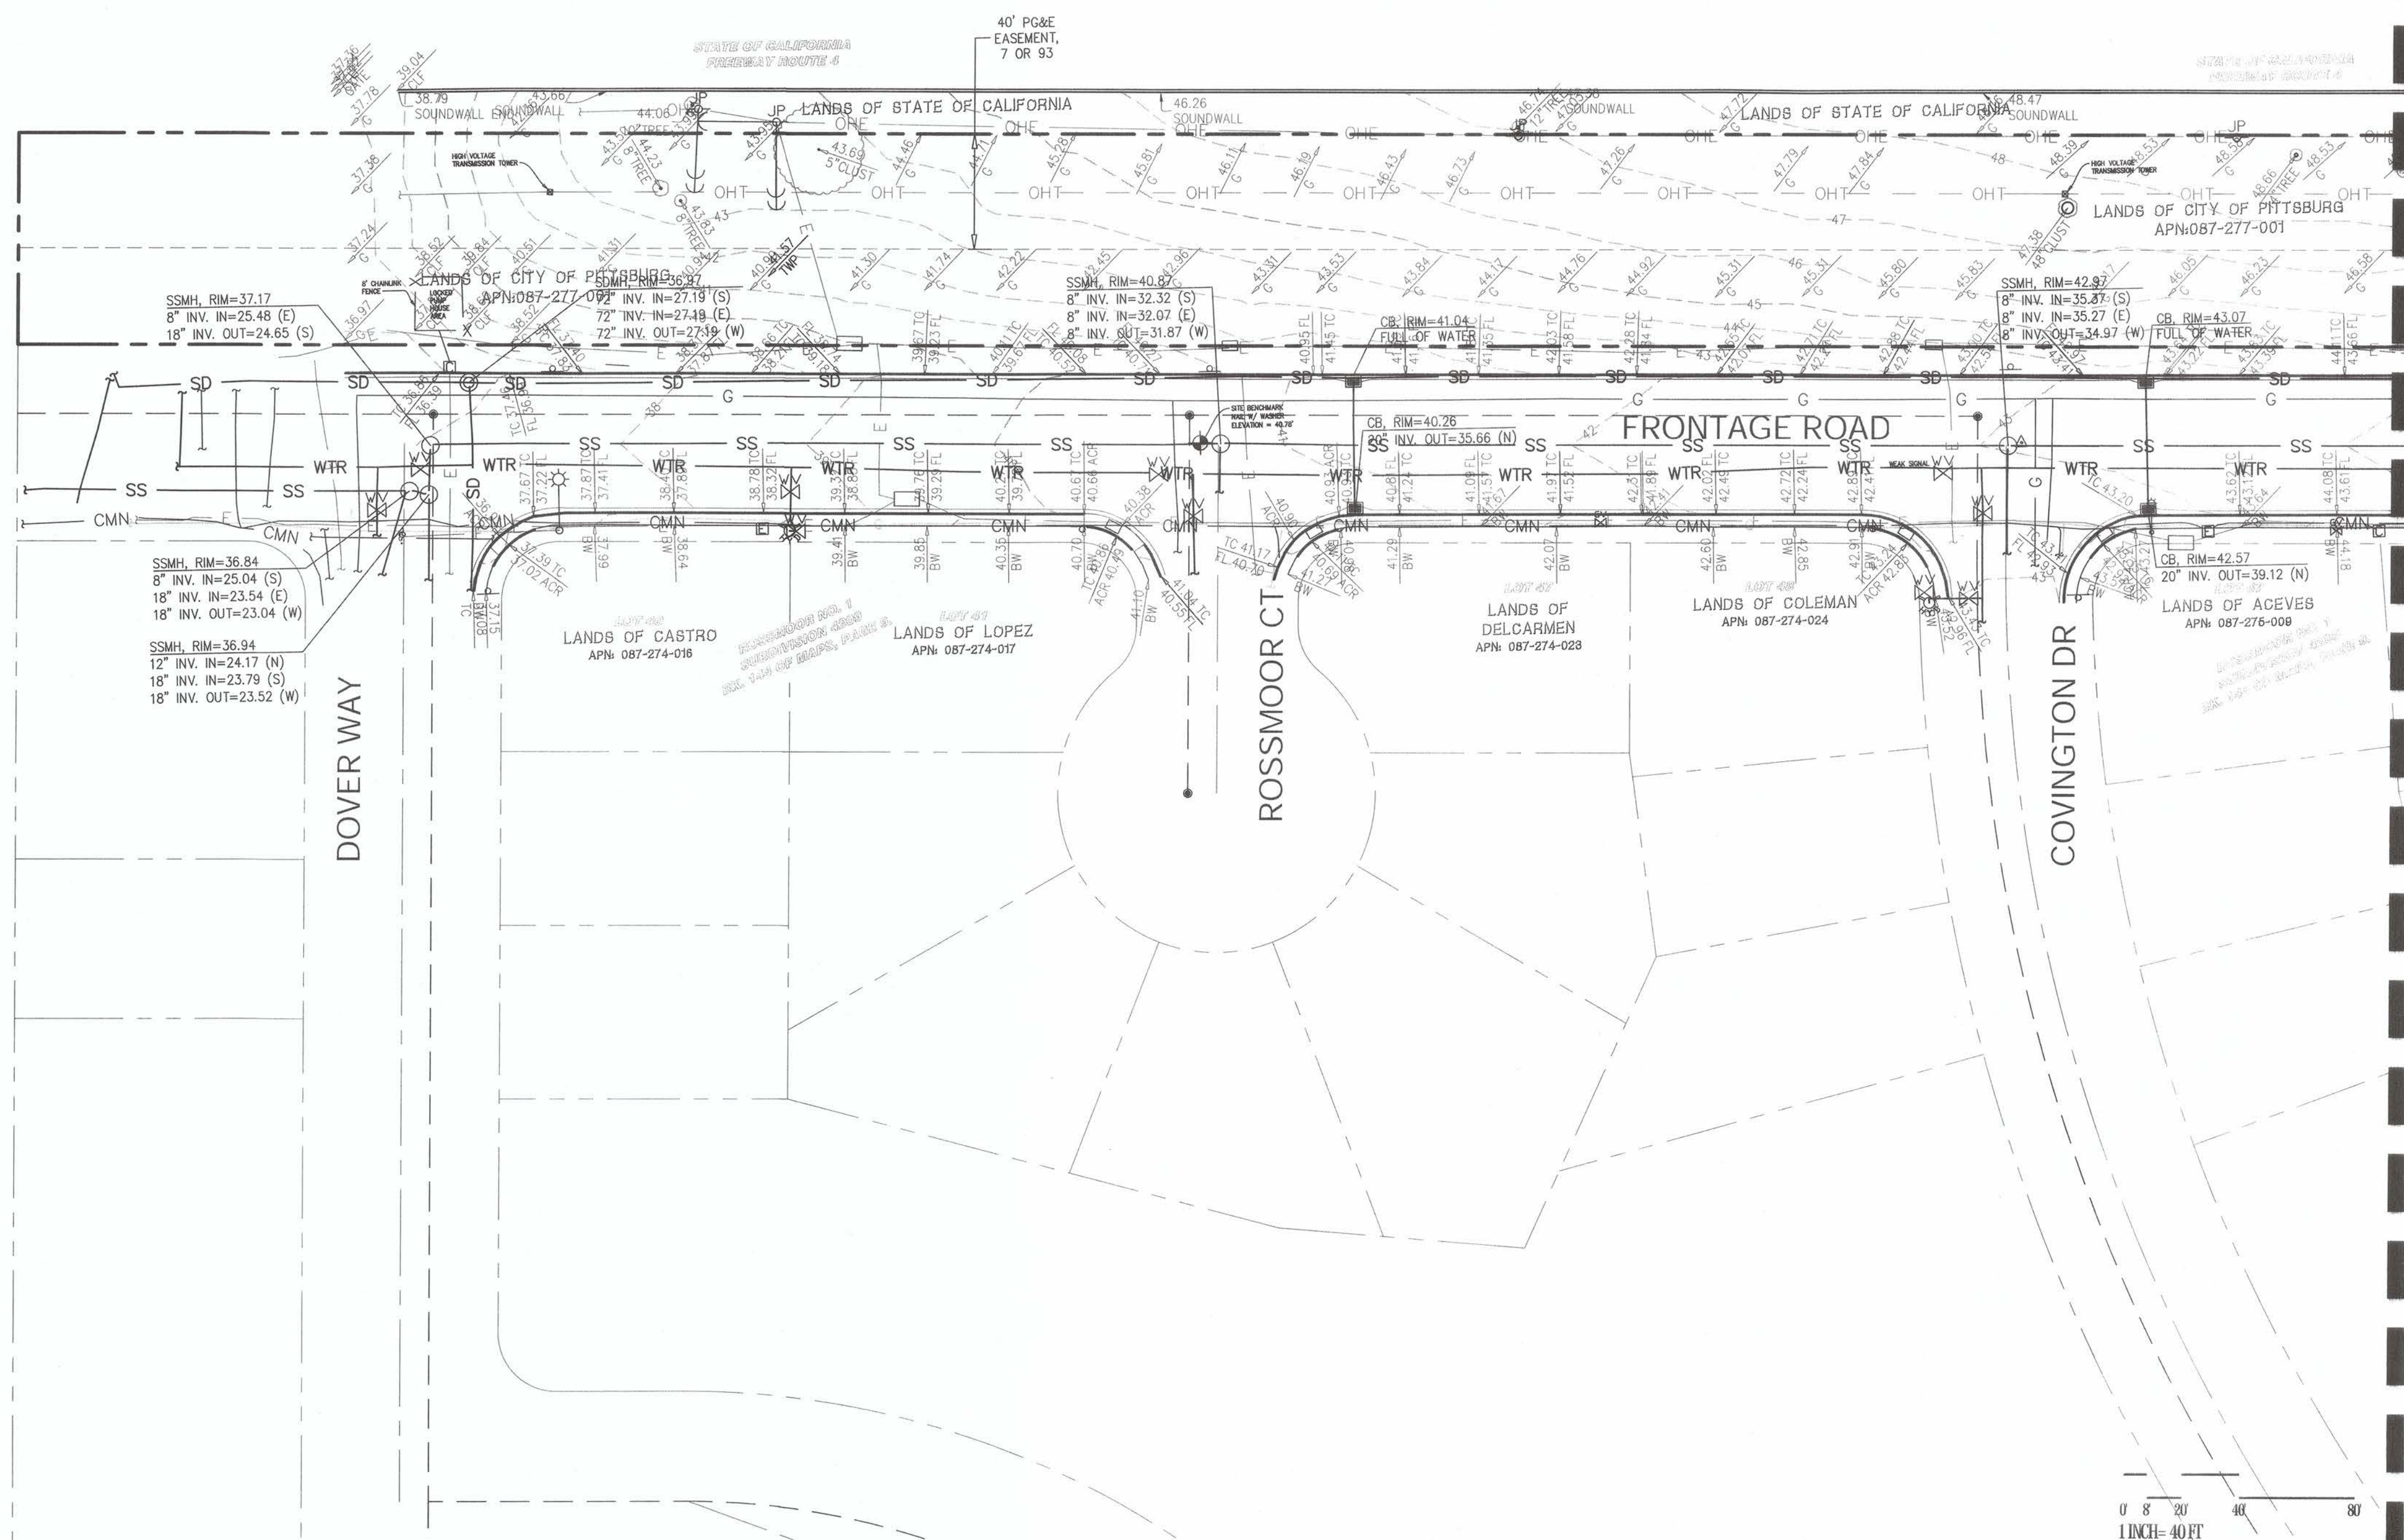

SURVEY NOTES

- EXISTING TOPOGRAPHIC SURVEY INFORMATION SHOWN HEREON IS BASED UPON TOPOGRAPHIC SURVEYS COMPLETED BY SANDIS ON 10/29/2022 AND 11/04/2022, UNDER THE DIRECTION OF LAURA CABRAL, PLS 7756.
- UTILITIES SHOWN ON THIS SURVEY ARE BASED ON SURFACE OBSERVATIONS. NO WARRANTIES ARE EXPRESSED OR IMPLIED CONCERNING THE EXISTENCE, SIZE, DEPTH, CONDITION, CAPACITY, OR LOCATION OR ANY UTILITY EXISTING ON THE SITE, WHETHER PRIVATE, MUNICIPAL, OR PUBLIC OWNED.
- CONTRACTOR SHALL VERIFY ALL UTILITIES PRIOR TO CONSTRUCTION AND REPORT BACK TO CIVIL ENGINEER ANY DISCREPANCIES WITH PLAN PRIOR TO COMMENCEMENT OF WORK.
- TREE LOCATIONS SHOWN HEREON ARE SHOWN SYMBOLICALLY WITH SYMBOL SIZES BASED UPON TRUNK DIAMETER AT CHEST HEIGHT, AT THE LOCATION WHERE THE TREE ENTERS THE GROUND SURFACE. LOCATIONS AND SIZES OF TREE TRUNKS CAN ONLY BE CONSIDERED APPROXIMATE UNLESS OTHERWISE STATED ON THE MAP. TREES OF TRUNK DIAMETER SIZES OF 6 INCHES OR GREATER WERE LOCATED BY THE FIELD CREW.
- HORIZONTAL CONTROL WAS BASED ON A GPS SURVEY USING GNSS RTK METHODS CONNECTED TO THE LEICA SMARTNET REAL TIME NETWORK TIED INTO CALIFORNIA STATE PLANE COORDINATES NAD83, EPOCH 2020.50. VERTICAL CONTROL WAS BASED ON CONTRA COSTA COUNTY BENCHMARK 171.

BENCHMARK

THE ELEVATION REFERENCE FOR THIS SURVEY IS A CONTRA COSTA COUNTY BENCHMARK, BM ID 171, SET ON AN EBMU BOX ON THE EAST SIDE OF RAILROAD AVENUE AT THE INTERSECTION OF RAILROAD AVENUE AND ALVARDO STREET.

ELEVATION= 105.39 FEET NAVD 88

SITE BENCHMARK

MAG NAIL WITH WASHER SET IN ASPHALT AT THE INTERSECTION OF ROSSMOOR COURT AND FRONTAGE ROAD

ELEVATION=43.51 FEET NAVD 88

UNDERGROUND UTILITY NOTE

THE TYPES, LOCATIONS, SIZES AND/OR DEPTHS OF EXISTING UNDERGROUND UTILITIES AS SHOWN ON THIS TOPOGRAPHIC SURVEY ARE APPROXIMATE AND WERE OBTAINED FROM SOURCES OF VARYING RELIABILITY. ONLY ACTUAL EXCAVATION WILL REVEAL THE TYPES, EXTENT, SIZES, LOCATIONS AND DEPTHS OF SUCH UNDERGROUND UTILITIES. A REASONABLE EFFORT HAS BEEN MADE TO LOCATE AND DELINEATE ALL KNOWN UNDERGROUND UTILITIES. HOWEVER, THE ENGINEER CAN ASSUME NO RESPONSIBILITY FOR THE COMPLETENESS OR ACCURACY OF ITS DELINEATION OF SUCH UNDERGROUND UTILITIES WHICH MAY BE ENCOUNTERED, BUT WHICH ARE NOT SHOWN ON THIS SURVEY.


OVERHEAD UTILITY NOTE

OVERHEAD UTILITY LINES SHOWN HEREON ARE FOR REFERENCE ONLY, DEPICTING THAT OVERHEAD LINES EXIST. ACTUAL ATTACHMENT, LOCATION, HEIGHT AND TYPE OF UTILITY SERVICE LINES SHALL BE VERIFIED BY THE USER.

BOUNDARY NOTE

THE PARCEL LINES SHOWN HEREON ARE BASED UPON RECORD INFORMATION AS SHOWN ON THAT CERTAIN SUBDIVISION MAP FILED IN BOOK 144 OF MAPS, PAGE 9, CONTRA COSTA COUNTY RECORDS. NO TITLE REPORT WAS OBTAINED BY SANDIS ENGINEERS. EASEMENTS MAY EXIST THAT ARE NOT SHOWN HEREON

MATCHLINE - SEE SHEET C-2.1

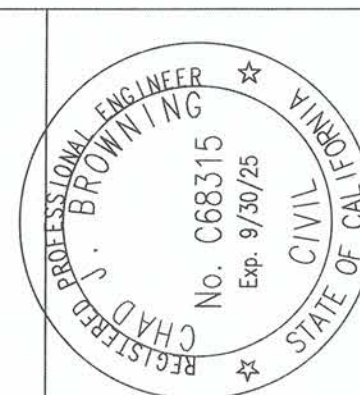

PREPARED UNDER THE DIRECTION OF:

 CHAD J. BROWNING
 P.C.E. NO. 68315
 EXPIRES 9-30-25

ACCEPTED FOR USE:

 JOHN SAMUELSON
 City Engineer
 Date: 9/20/23




**FRONTAGE ROAD
 LIVING GREEN TRAIL DESIGN
 TOPOGRAPHIC SURVEY**
 CONTRACT NAME:
 CONTRACT NUMBER:

BY	DRAWN: CW
CHECKED: SC	
REVIEWED: CB	
DATE: 09/05/23	
SCALE: AS NOTED	

DATE	REV	DESCRIPTION

SHEET NO.
 3 OF 59
 DWG. NO.
C-20

MATCHLINE - SEE SHEET C-2.0

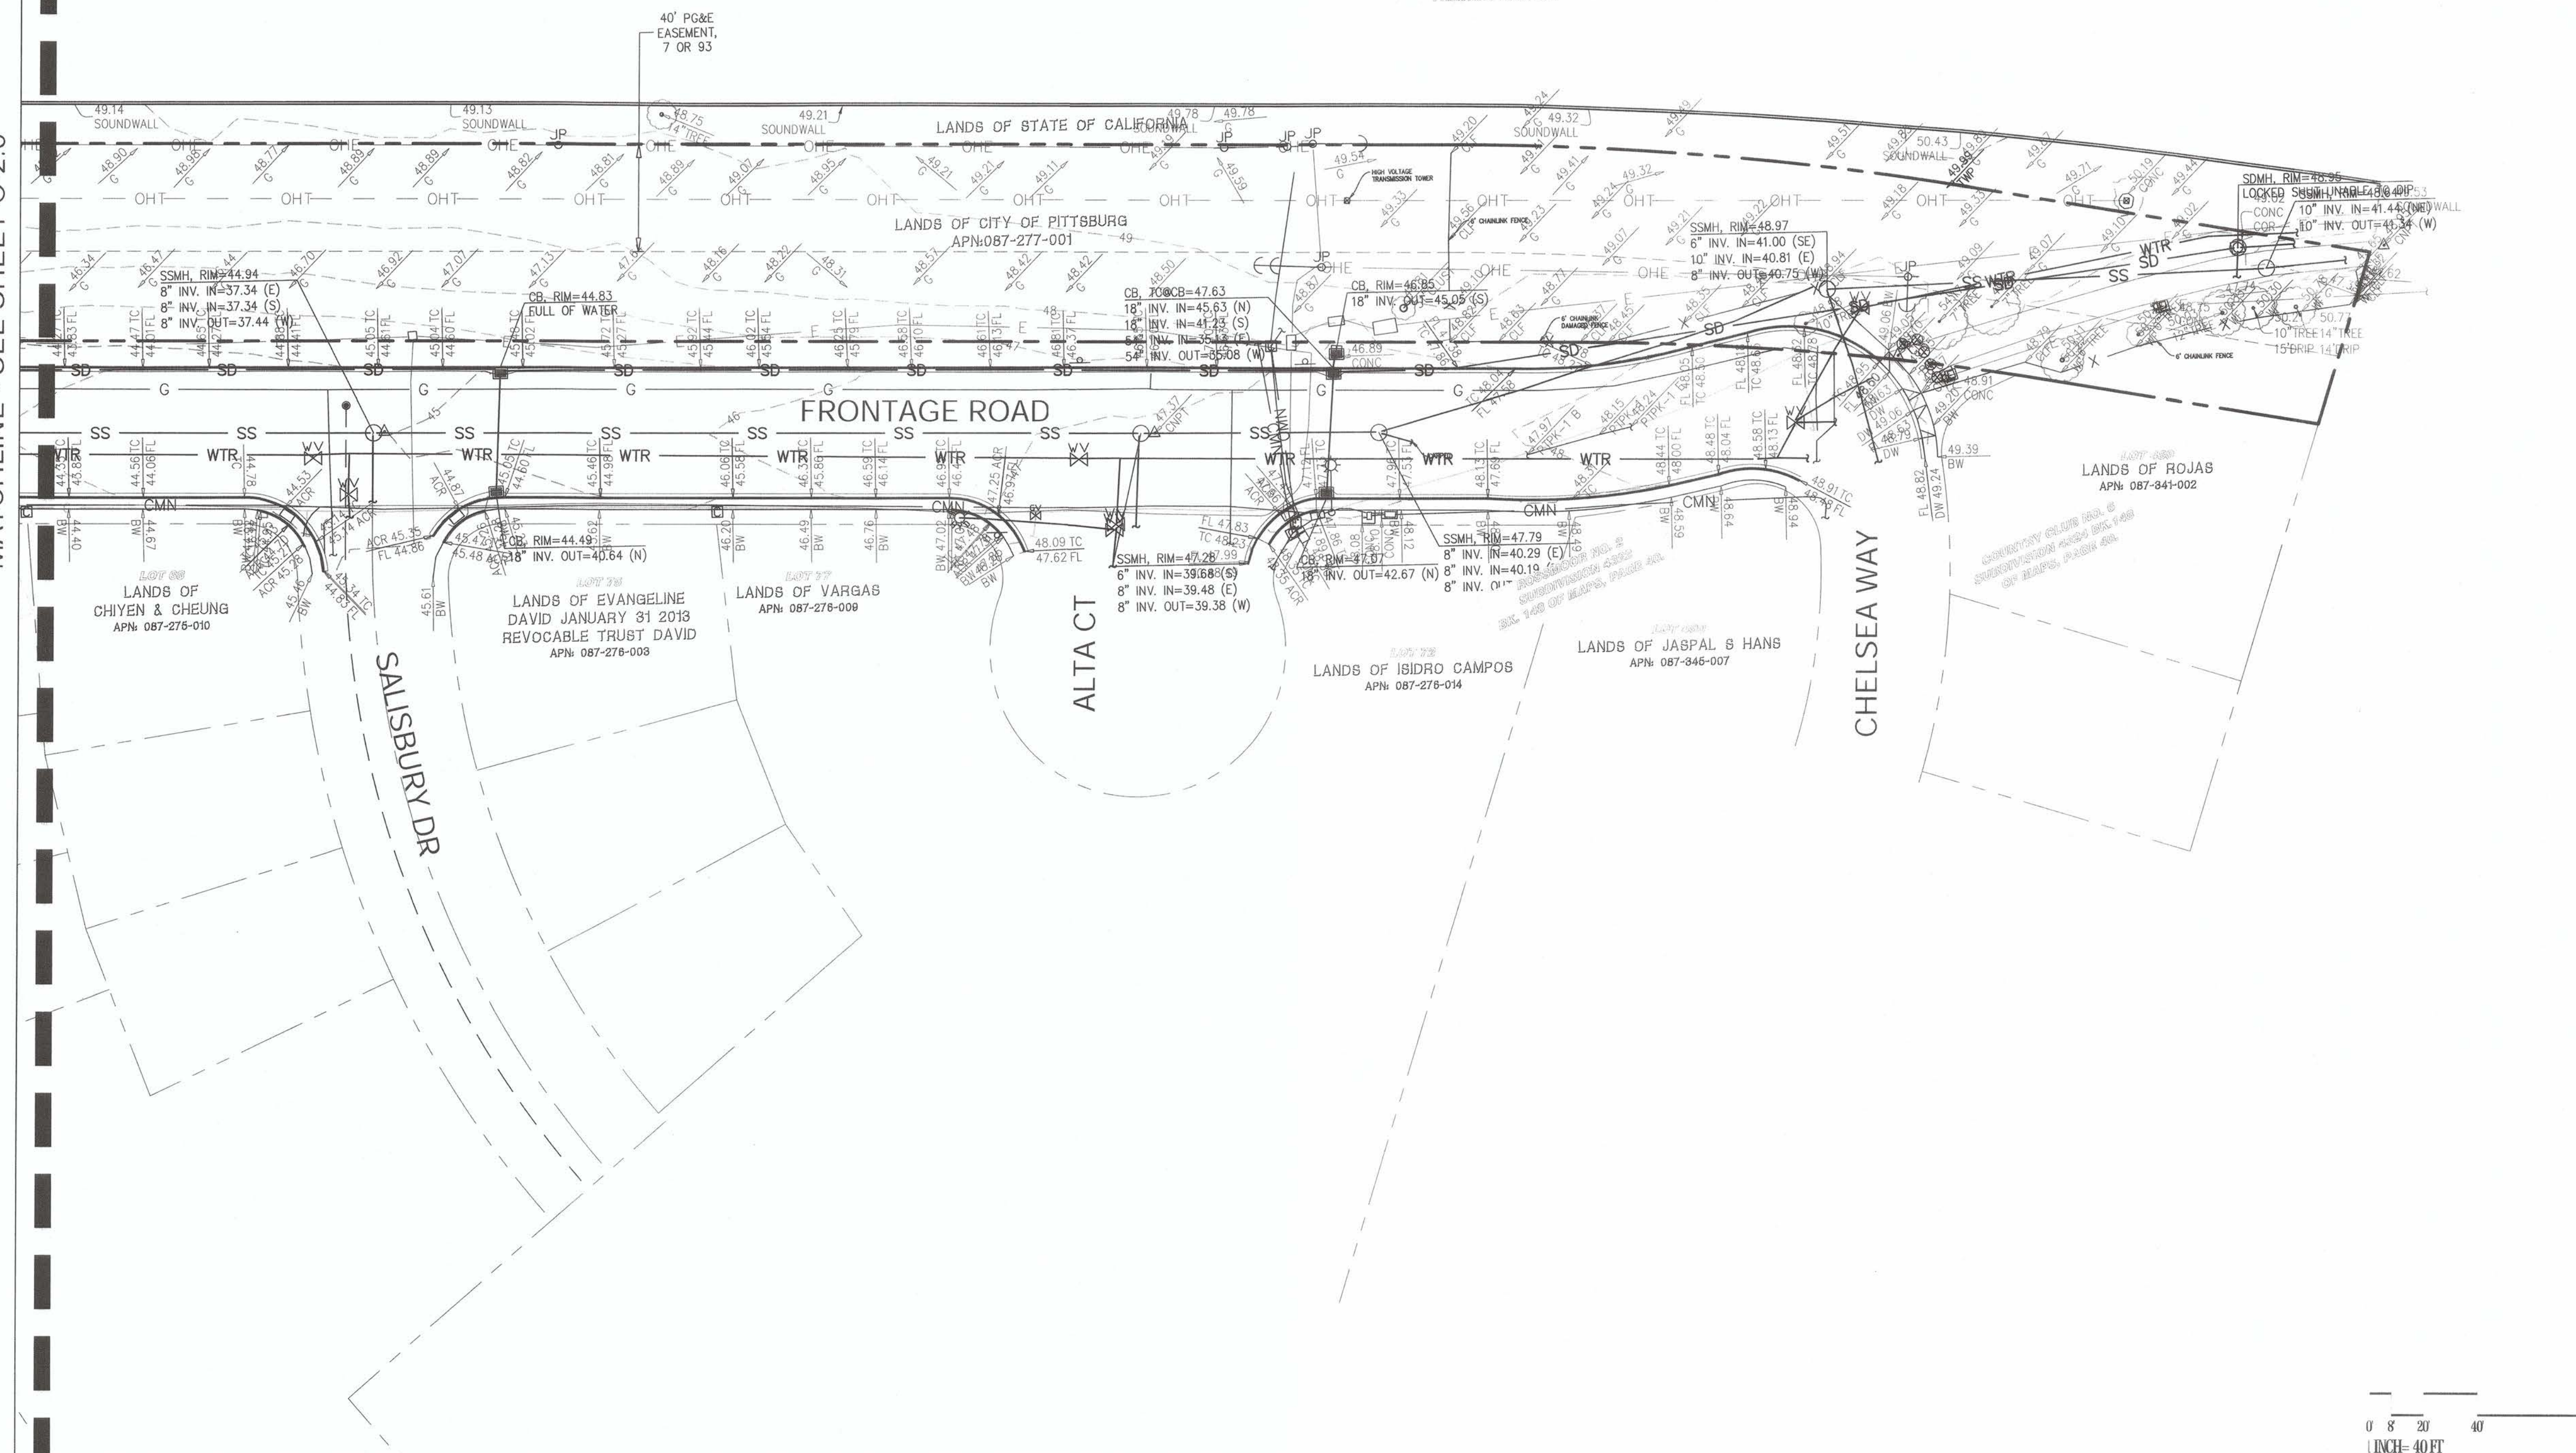

SURVEY NOTES

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SITE BENCHMARK

MAG NAIL WITH WASHER SET IN ASPHALT AT THE INTERSECTION OF ROSSMOOR COURT AND FRONTAGE ROAD

ELEVATION=43.51 FEET NAVD 88

UNDERGROUND UTILITY NOTE


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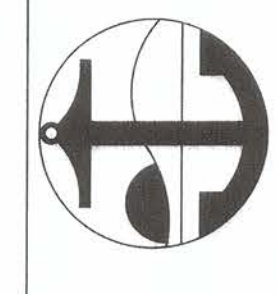


PREPARED UNDER THE DIRECTION OF:

Chad J. Browning
 P.C.E. NO. 068315
 Exp. 9-30-23

ACCEPTED FOR USE:

John Samuelson
 City Engineer
 Date: 9/26/23

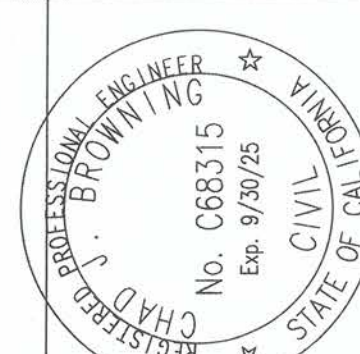

FRONTAGE ROAD
 LIVING GREEN TRAIL DESIGN
 TOPOGRAPHIC SURVEY

CONTRACT NAME:
 CONTRACT NUMBER:

DATE	REV	DESCRIPTION	BY	DRAWN: CW	CHECKED: SC	REVIEWED: CB	DATE: 09/05/23	SCALE: AS NOTED
SHEET NO. 4 OF 59								DWG. NO. C-21




PREPARED UNDER THE DIRECTION OF:
Chad J. Browning
 CHAD J. BROWNING
 P.E. CIVIL ENGINEER
 EXPIRES 9-30-25

ACCEPTED FOR USE:
John Samuelson
 JOHN SAMUELSON
 City Engineer
 Date: 9/26/23


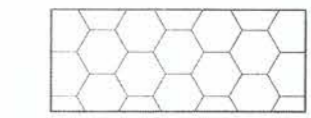
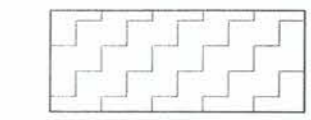
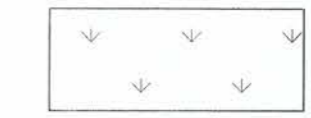
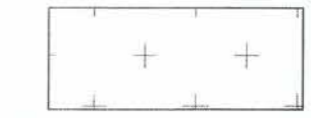






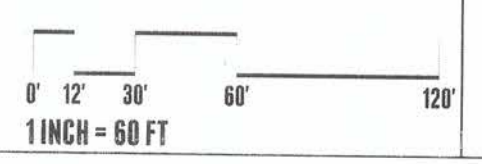




**FRONTAGE ROAD
 LIVING GREEN TRAIL DESIGN
 OVERALL SITE PLAN**
 CONTRACT NAME:
 CONTRACT NUMBER:

DATE	REV	DESCRIPTION	BY	DRAWN: CW	CHECKED: SC	REVIEWED: CB	DATE: 09/05/23	SCALE: AS NOTED
SHEET NO. 5 OF 59								
DWG. NO. C-30								



LEGEND

-  SAWCUT LINE. CONTRACTOR SHALL SAWCUT WITH A NEAT, CLEAN EDGE. SAWCUT CONCRETE AT NEAREST JOINT TO SAWCUT LINE SHOWN ON PLAN.
-  DEMOLISH AND REMOVE AC PAVING AND ANY ASSOCIATED BASE ROCK. STABILIZE THE EXISTING SUBGRADE. DEMOLISHED MATERIAL MAY BE USED AS BASE ROCK IF APPROVED BY GEOTECHNICAL ENGINEER.
-  DEMOLISH AND REMOVE CONCRETE INCLUDING ANY ASSOCIATED BASE ROCK AND REBAR. STABILIZE THE EXISTING SUBGRADE. DEMOLISHED MATERIAL MAY BE USED AS BASE ROCK IF APPROVED BY THE GEOTECHNICAL ENGINEER.
-  CLEAR AND GRUB EXISTING LANDSCAPE AREA SO NO ORGANICS ARE STILL PRESENT.
-  DEMOLISH AND REMOVE EXISTING BUILDING, SEE ARCHITECTURAL PLANS FOR EXTENT OF BUILDING DEMOLITION. STABILIZE THE EXISTING SUBGRADE.
-  DEMOLISH AND REMOVE EXISTING CURB AND GUTTER, INCLUDING ANY ASSOCIATED REBAR OR BASE ROCK. SAWCUT WITH NEAT, CLEAN EDGE.
-  REMOVE EXISTING WALL OR FENCE INCLUDING ASSOCIATED FOOTINGS. RETURN FENCE TO OWNER.
-  DEMOLISH AND REMOVE EX. UTILITY LINE. BACKFILL EMPTY TRENCH WITH APPROVED FILL PER GEOTECHNICAL REPORT.
-  DEMOLISH AND REMOVE EX. UTILITY STRUCTURE
-  CAP EXISTING UTILITY WHERE SHOWN PER UTILITY OWNERS SPECIFICATIONS AND REQUIREMENTS. IF PRESSURIZED UTILITY CONTRACTOR SHALL HAVE COMPETENT PROFESSIONAL DESIGN PIPE RESTRAINTS.
-  DEMOLISH AND REMOVE EX. STREET LIGHT AND FOUNDATION
-  PROTECT EXISTING UTILITY TO REMAIN
-  REMOVE EXISTING TREE AND ROOT BALL. COORDINATE WITH LANDSCAPE ARCHITECT AND PROJECT ARBORIST PRIOR TO REMOVING ANY TREES.
-  PROTECT EXISTING TREE TO REMAIN. SEE LANDSCAPE PLANS AND ARBORIST'S REPORT FOR TREE PROTECTION DETAILS.



PREPARED UNDER THE DIRECTION OF:
 CHAD J. BROWNING
 No. 068315
 Exp. 9/20/25
 CIVIL ENGINEER
 STATE OF CALIFORNIA
 DATE: 9/20/23

ACCEPTED FOR USE:
 JOHN SAMUELSON
 City Engineer
 Date: 9/26/23





**FRONTAGE ROAD
 LIVING GREEN TRAIL DESIGN
 DEMOLITION PLAN**
 CONTRACT NAME:
 CONTRACT NUMBER:

BY: DRAWN: CW
 CHECKED: SC
 REVIEWED: CB
 DATE: 09/05/23
 SCALE: AS NOTED

DATE	REV	DESCRIPTION


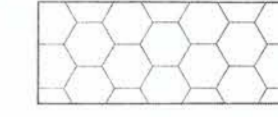
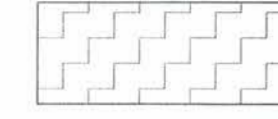
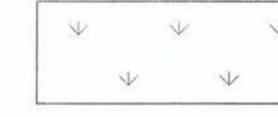


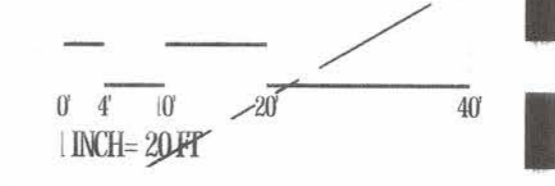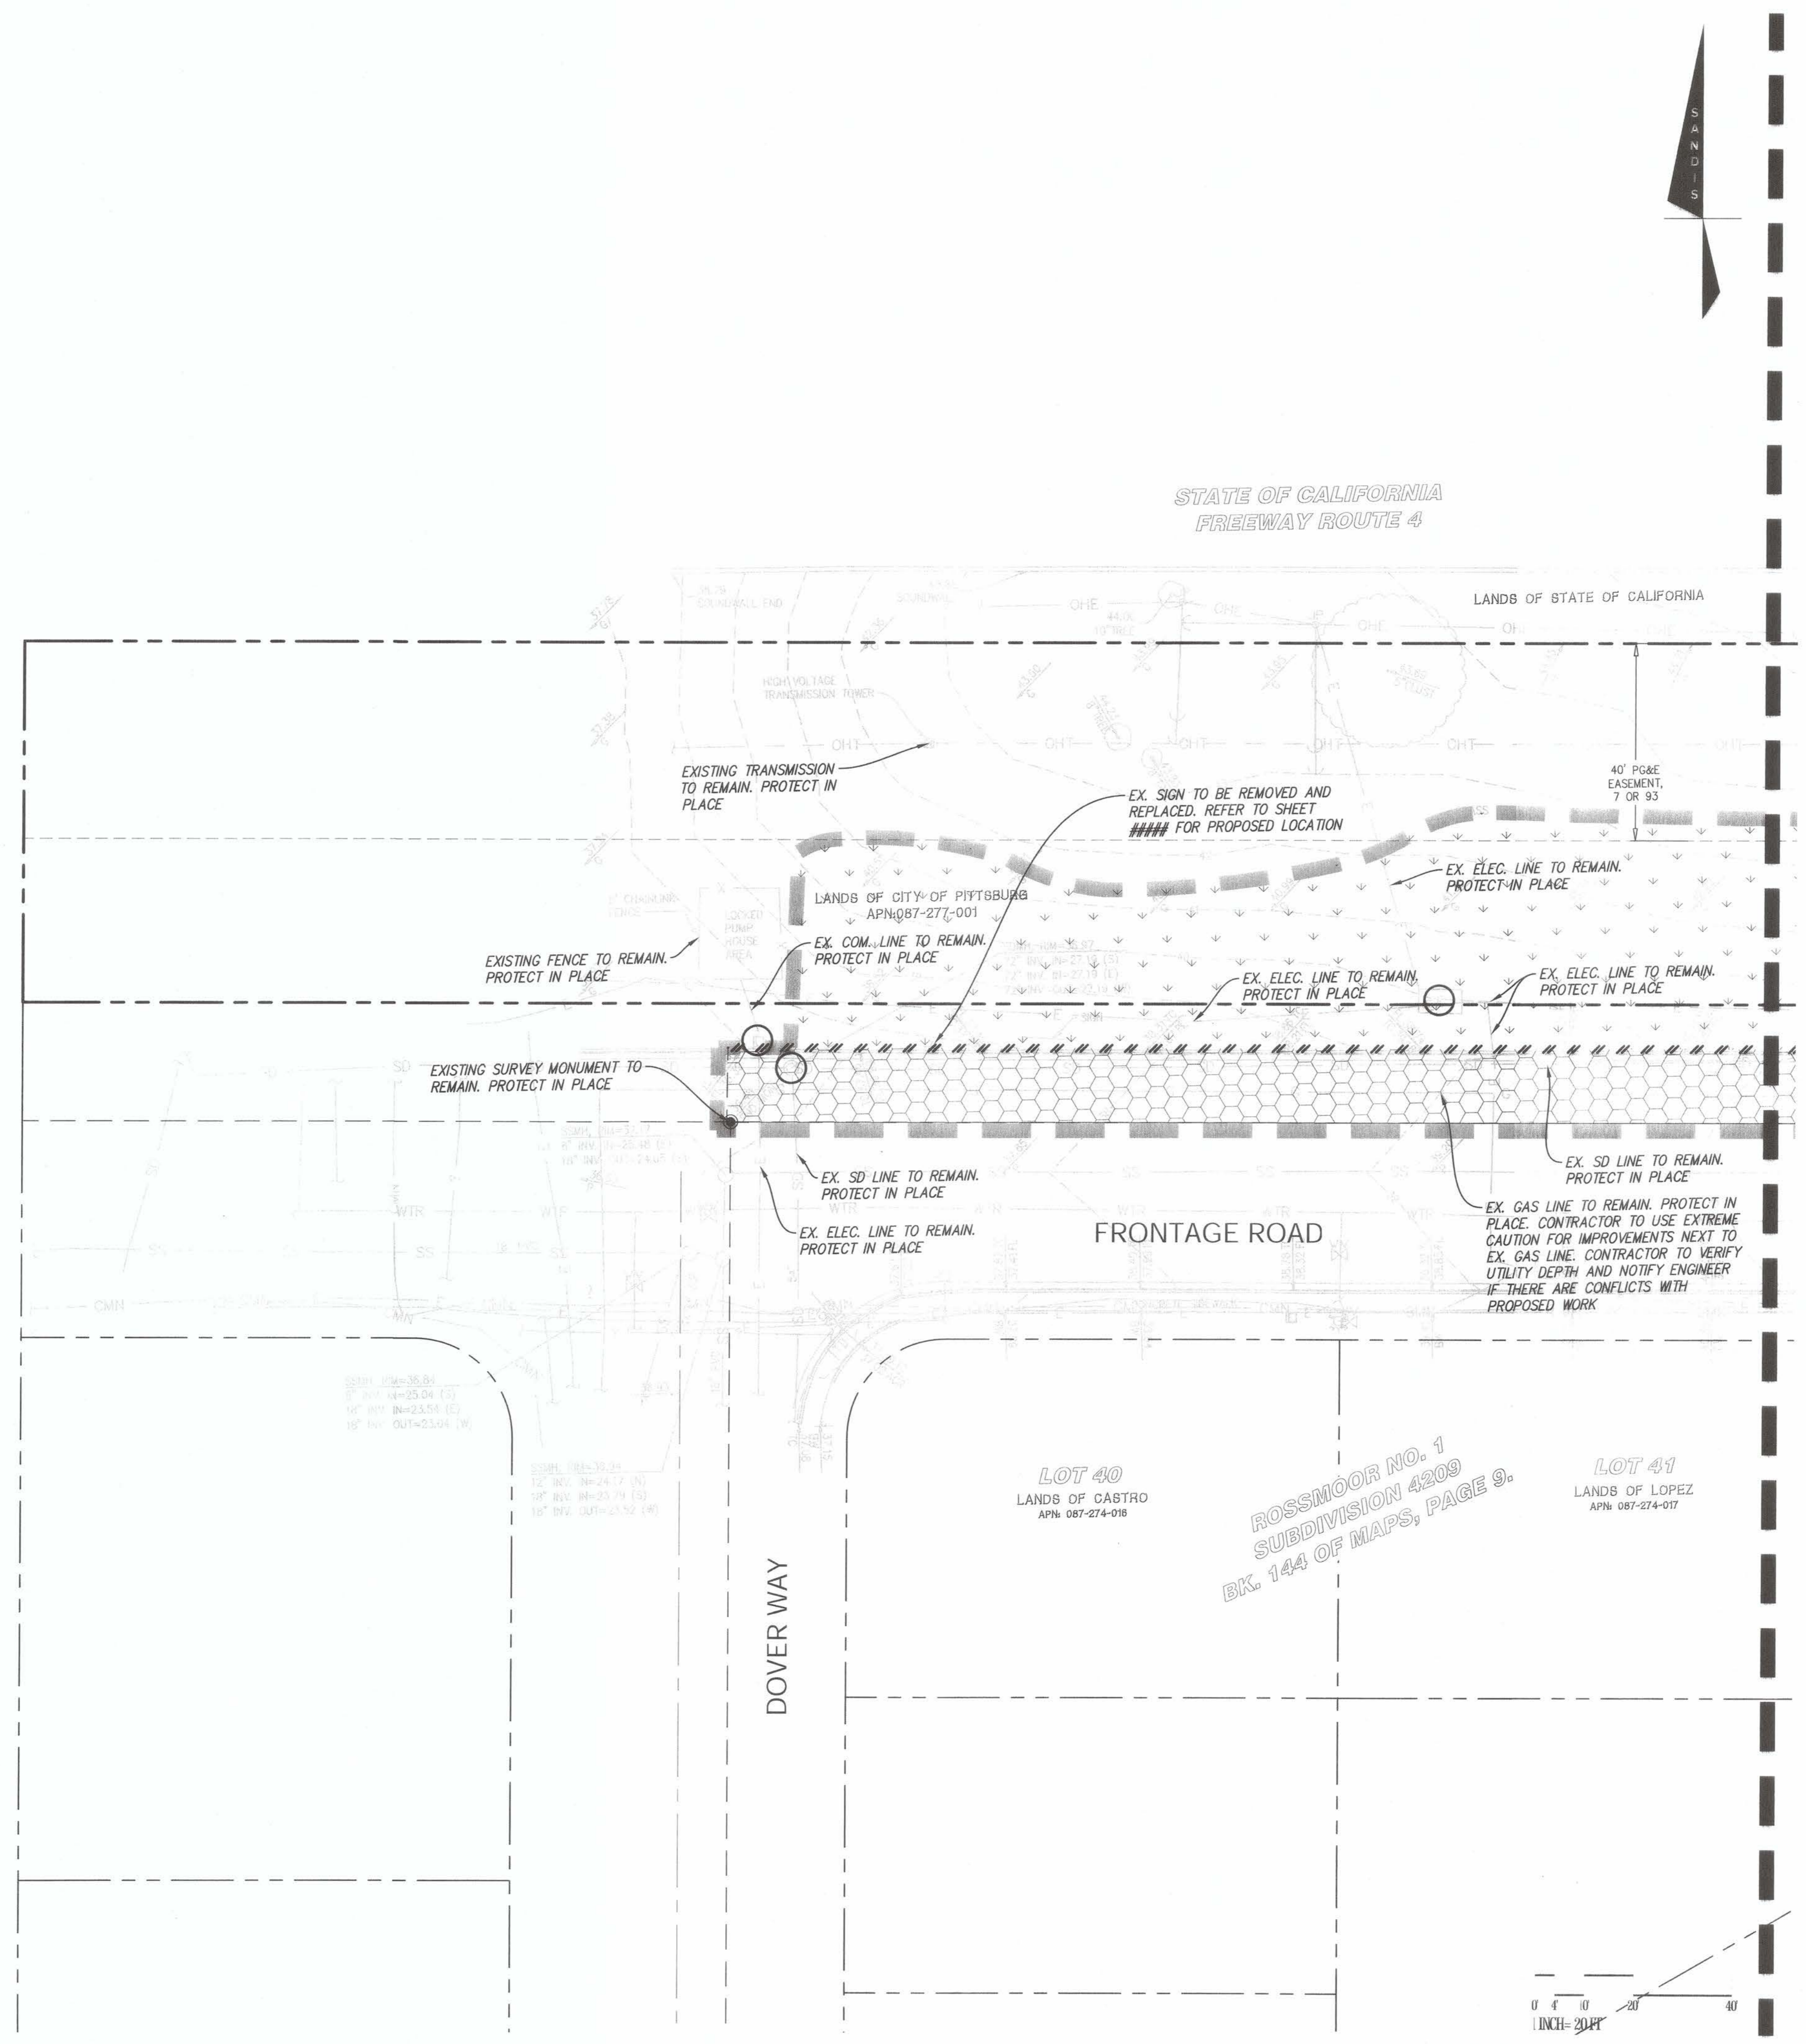







SHEET NO.
 6 OF 59
 DWG. NO.
C-40




MATCHLINE - SEE SHEET C-4.0

MATCHLINE - SEE SHEET C-4.2

LEGEND

-  SAWCUT LINE. CONTRACTOR SHALL SAWCUT WITH A NEAT, CLEAN EDGE. SAWCUT CONCRETE AT NEAREST JOINT TO SAWCUT LINE SHOWN ON PLAN.
-  DEMOLISH AND REMOVE AC PAVING AND ANY ASSOCIATED BASE ROCK. STABILIZE THE EXISTING SUBGRADE. DEMOLISHED MATERIAL MAY BE USED AS BASE ROCK IF APPROVED BY GEOTECHNICAL ENGINEER.
-  DEMOLISH AND REMOVE CONCRETE INCLUDING ANY ASSOCIATED BASE ROCK AND REBAR. STABILIZE THE EXISTING SUBGRADE. DEMOLISHED MATERIAL MAY BE USED AS BASE ROCK IF APPROVED BY THE GEOTECHNICAL ENGINEER.
-  CLEAR AND GRUB EXISTING LANDSCAPE AREA SO NO ORGANICS ARE STILL PRESENT.
-  DEMOLISH AND REMOVE EXISTING BUILDING, SEE ARCHITECTURAL PLANS FOR EXTENT OF BUILDING DEMOLITION. STABILIZE THE EXISTING SUBGRADE.
-  DEMOLISH AND REMOVE EXISTING CURB AND GUTTER, INCLUDING ANY ASSOCIATED REBAR OR BASE ROCK. SAWCUT WITH NEAT, CLEAN EDGE.
-  REMOVE EXISTING WALL OR FENCE INCLUDING ASSOCIATED FOOTINGS. RETURN FENCE TO OWNER.
-  DEMOLISH AND REMOVE EX. UTILITY LINE. BACKFILL EMPTY TRENCH WITH APPROVED FILL PER GEOTECHNICAL REPORT.
-  DEMOLISH AND REMOVE EX. UTILITY STRUCTURE.
-  CAP EXISTING UTILITY WHERE SHOWN PER UTILITY OWNERS SPECIFICATIONS AND REQUIREMENTS. IF PRESSURIZED UTILITY CONTRACTOR SHALL HAVE COMPETENT PROFESSIONAL DESIGN PIPE RESTRAINTS.
-  DEMOLISH AND REMOVE EX. STREET LIGHT AND FOUNDATION.
-  PROTECT EXISTING UTILITY TO REMAIN.
-  REMOVE EXISTING TREE AND ROOT BALL. COORDINATE WITH LANDSCAPE ARCHITECT AND PROJECT ARBORIST PRIOR TO REMOVING ANY TREES.
-  PROTECT EXISTING TREE TO REMAIN. SEE LANDSCAPE PLANS AND ARBORIST'S REPORT FOR TREE PROTECTION DETAILS.

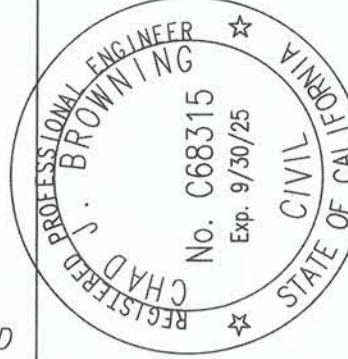

PREPARED UNDER THE DIRECTION OF:
Chad L. Browning 9/20/23 DATE:
 CHAD L. BROWNING 9/20/23 DATE:
 P.C.E. No. C68315 EXPIRES: 9-30-25

ACCEPTED FOR USE:
John Samuelson
 City Engineer
 Date: 9/26/23





**FRONTAGE ROAD
 LIVING GREEN TRAIL DESIGN
 DEMOLITION PLAN**
 CONTRACT NAME:
 CONTRACT NUMBER:

BY	DRAWN: CW
CHECKED: SC	
REVIEWED: CB	
DATE: 09/05/23	
SCALE: AS NOTED	

DATE	REV	DESCRIPTION


SHEET NO.
7 OF 59
 DWG. NO.
C-41

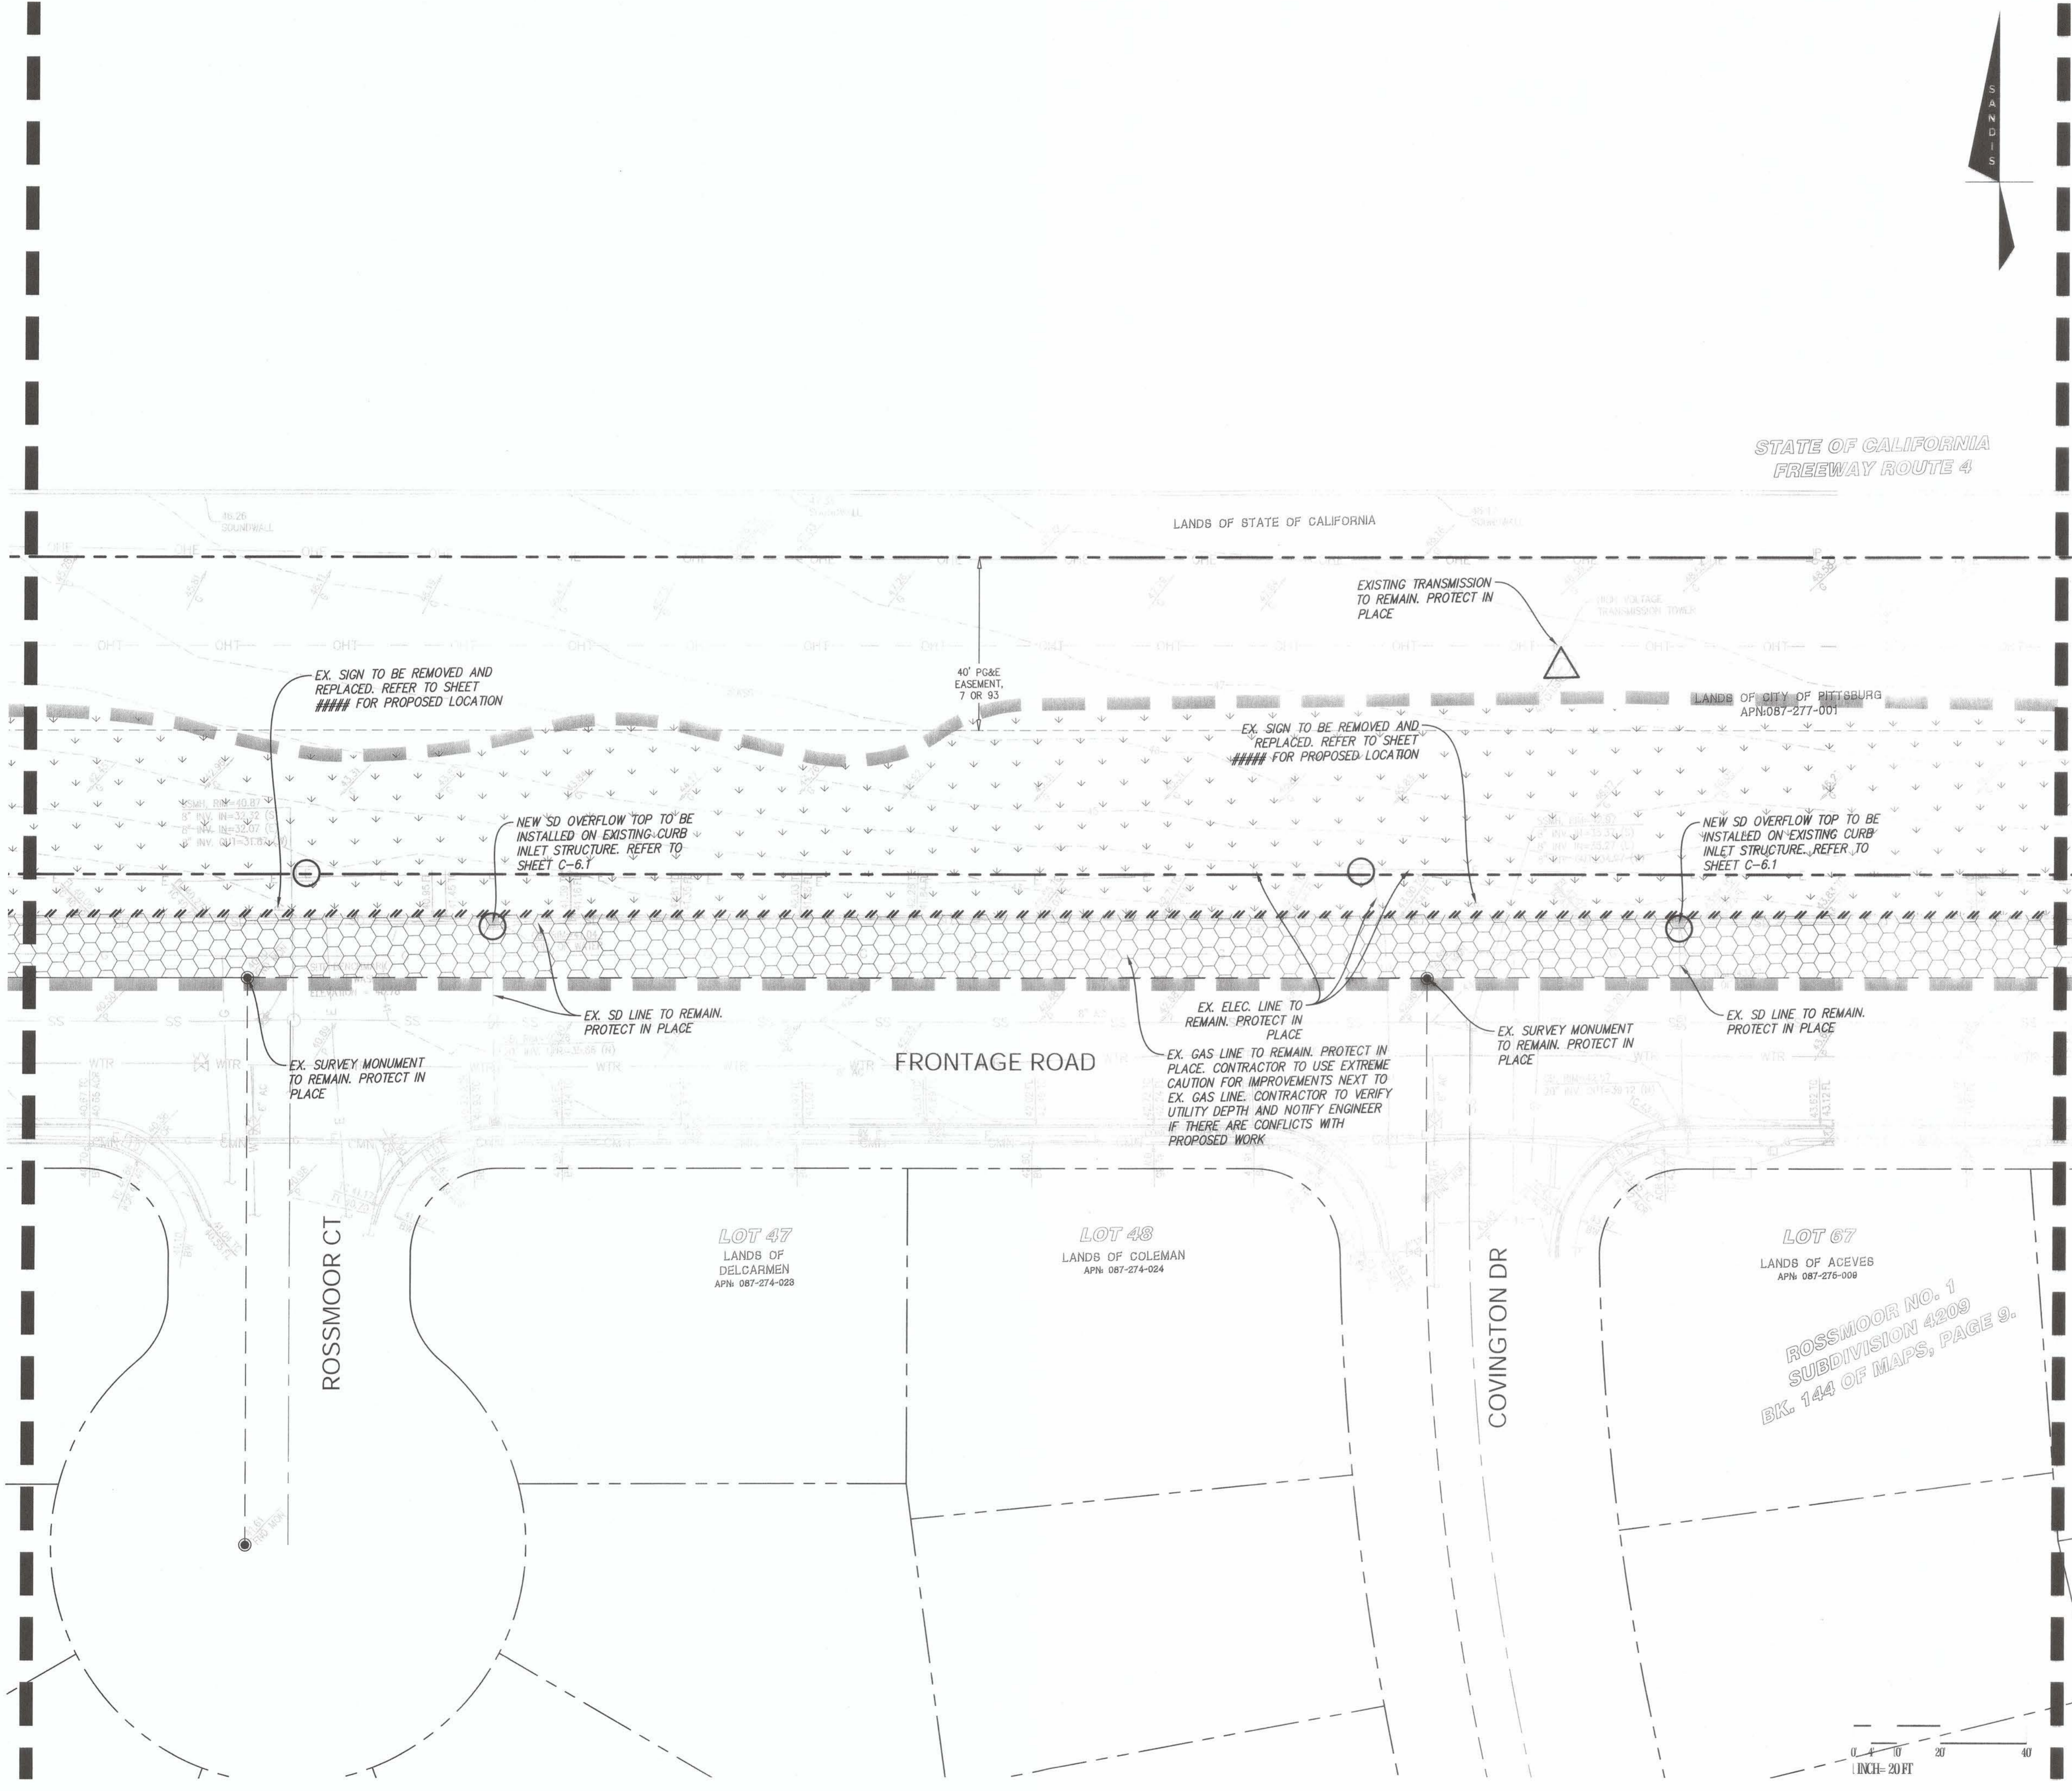

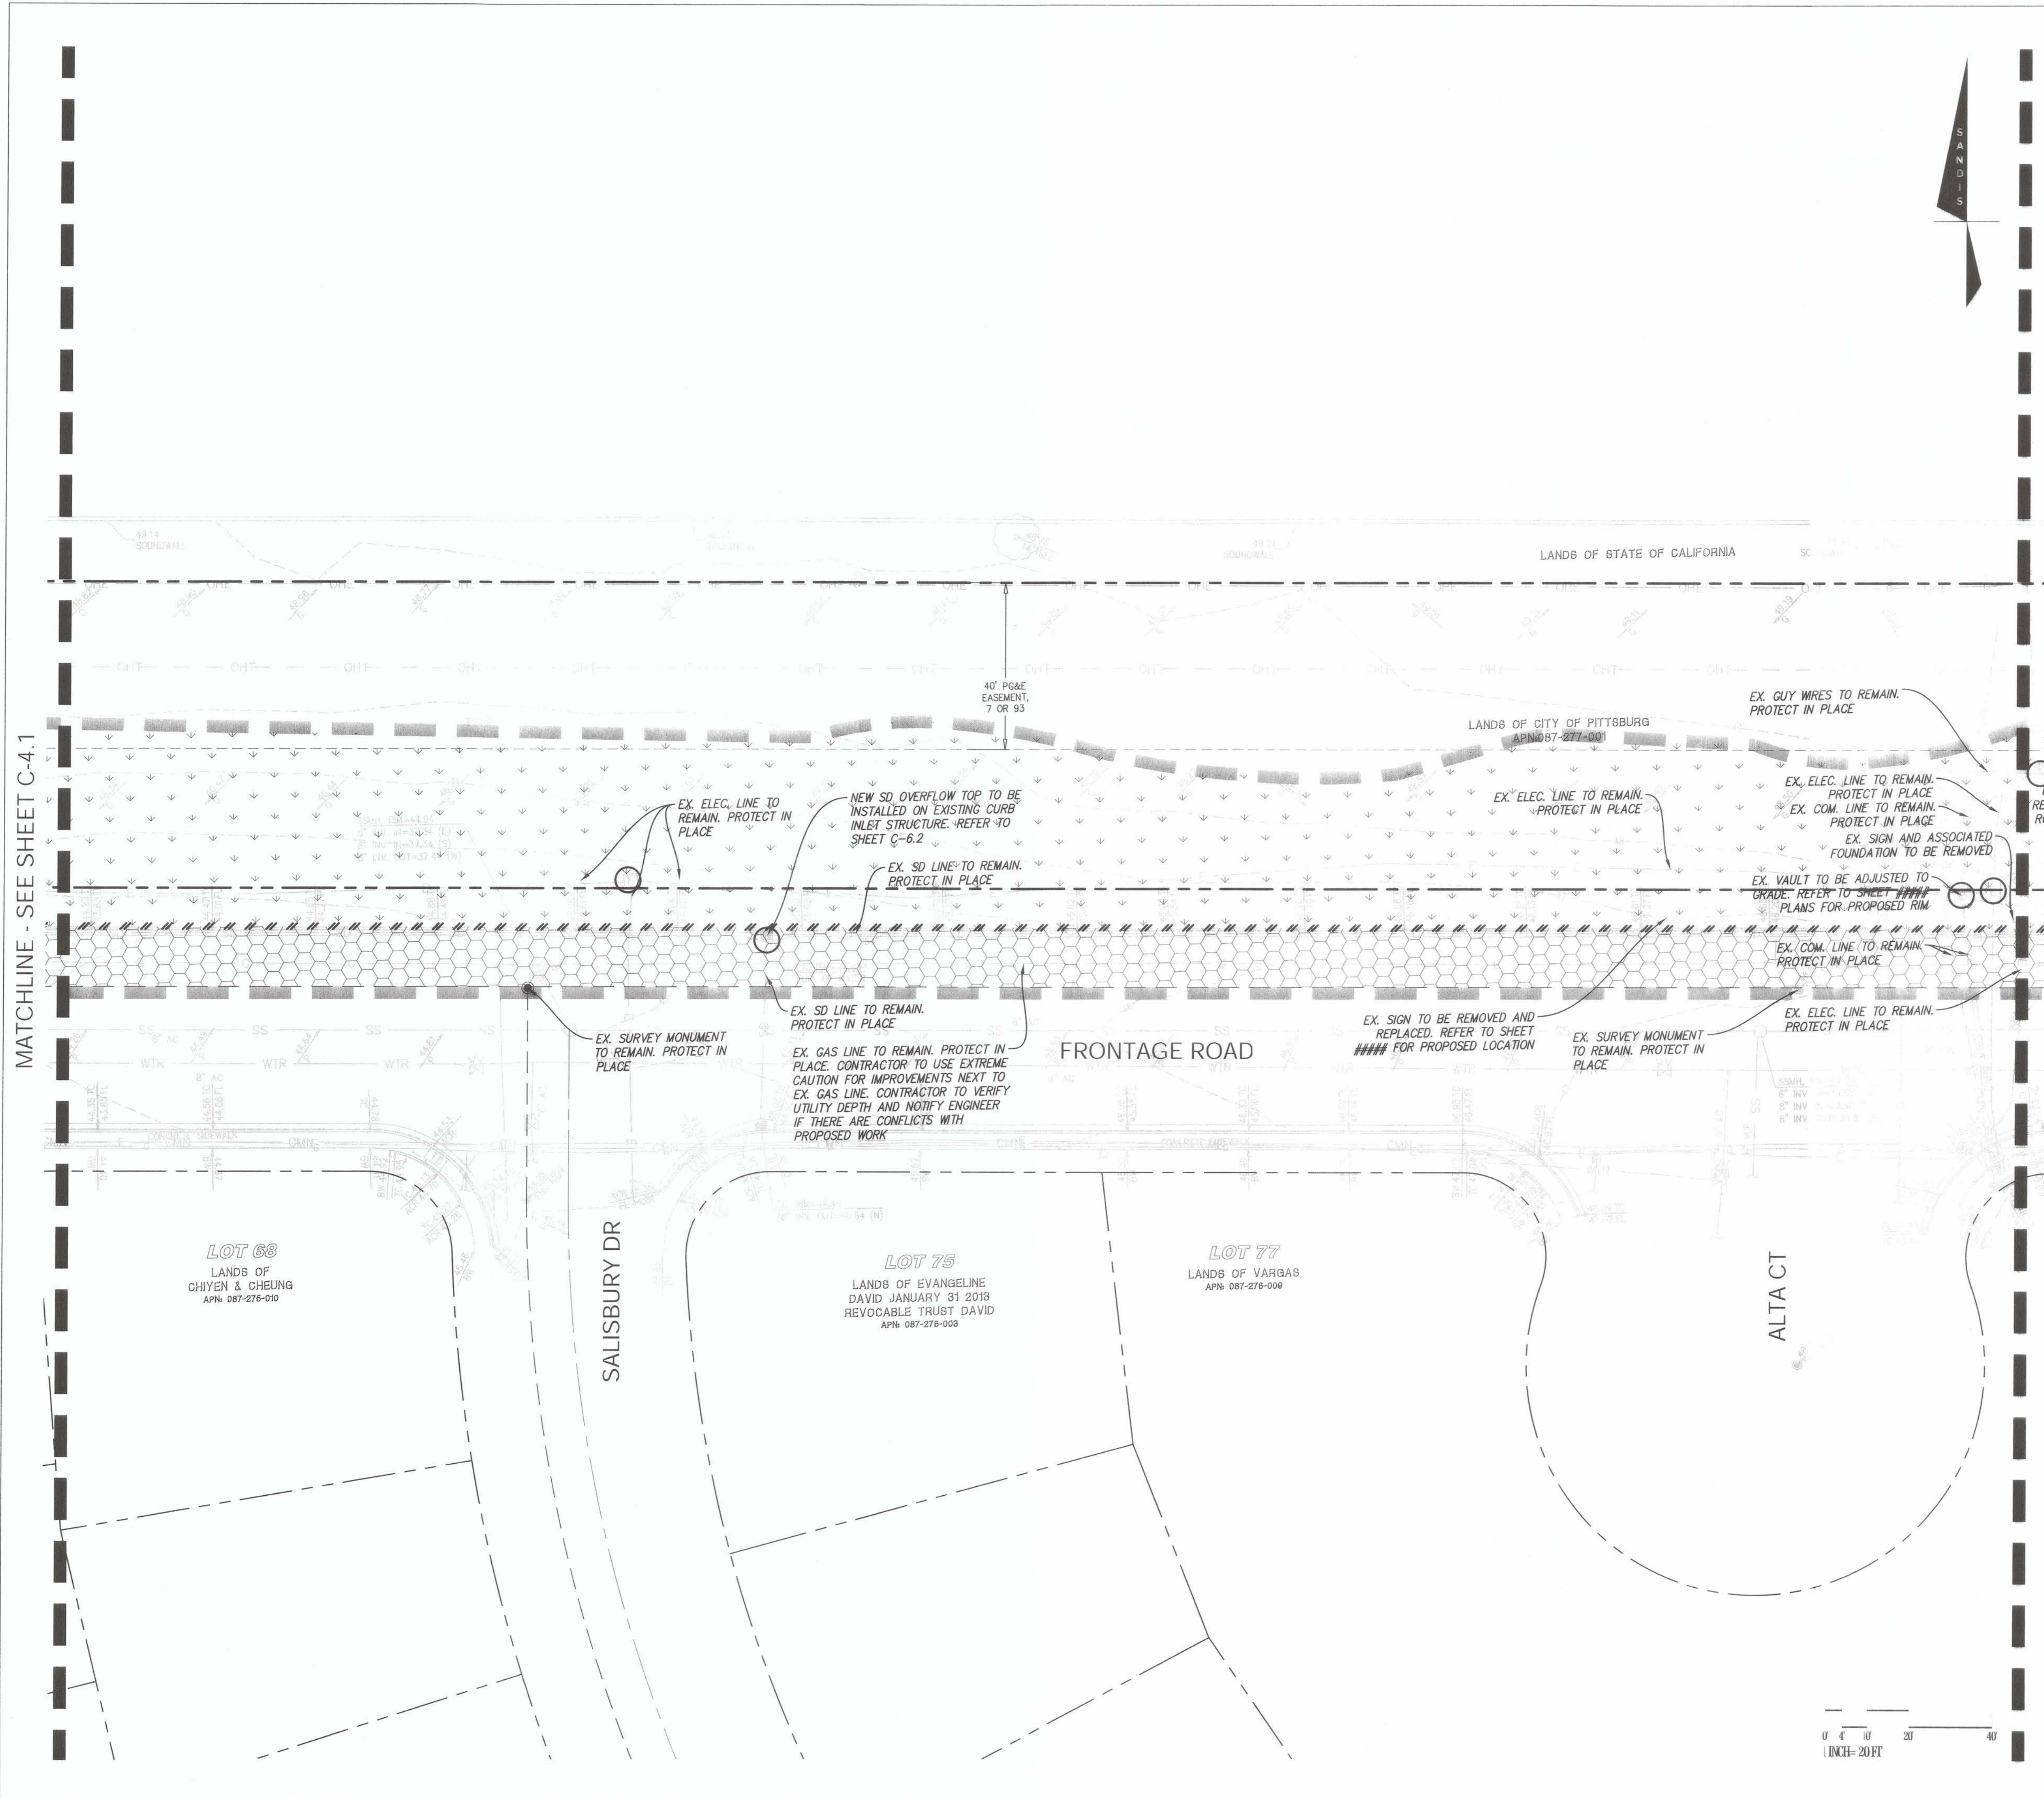

LEGEND

- SAWCUT LINE. CONTRACTOR SHALL SAWCUT WITH A NEAT, CLEAN EDGE. SAWCUT CONCRETE AT NEAREST JOINT TO SAWCUT LINE SHOWN ON PLAN.
- DEMOLISH AND REMOVE AC PAVING AND ANY ASSOCIATED BASE ROCK. STABILIZE THE EXISTING SUBGRADE. DEMOLISHED MATERIAL MAY BE USED AS BASE ROCK IF APPROVED BY GEOTECHNICAL ENGINEER.
- DEMOLISH AND REMOVE CONCRETE INCLUDING ANY ASSOCIATED BASE ROCK AND REBAR. STABILIZE THE EXISTING SUBGRADE. DEMOLISHED MATERIAL MAY BE USED AS BASE ROCK IF APPROVED BY THE GEOTECHNICAL ENGINEER.
- CLEAR AND GRUB EXISTING LANDSCAPE AREA SO NO ORGANICS ARE STILL PRESENT.
- DEMOLISH AND REMOVE EXISTING BUILDING, SEE ARCHITECTURAL PLANS FOR EXTENT OF BUILDING DEMOLITION. STABILIZE THE EXISTING SUBGRADE.
- DEMOLISH AND REMOVE EXISTING CURB AND GUTTER, INCLUDING ANY ASSOCIATED REBAR OR BASE ROCK. SAWCUT WITH NEAT, CLEAN EDGE.
- REMOVE EXISTING WALL OR FENCE INCLUDING ASSOCIATED FOOTINGS. RETURN FENCE TO OWNER.
- DEMOLISH AND REMOVE EX. UTILITY LINE. BACKFILL EMPTY TRENCH WITH APPROVED FILL PER GEOTECHNICAL REPORT.
- DEMOLISH AND REMOVE EX. UTILITY STRUCTURE
- CAP EXISTING UTILITY WHERE SHOWN PER UTILITY OWNERS SPECIFICATIONS AND REQUIREMENTS. IF PRESSURIZED UTILITY CONTRACTOR SHALL HAVE COMPETENT PROFESSIONAL DESIGN PIPE RESTRAINTS.
- DEMOLISH AND REMOVE EX. STREET LIGHT AND FOUNDATION
- PROTECT EXISTING UTILITY TO REMAIN
- REMOVE EXISTING TREE AND ROOT BALL. COORDINATE WITH LANDSCAPE ARCHITECT AND PROJECT ARBORIST PRIOR TO REMOVING ANY TREES.
- PROTECT EXISTING TREE TO REMAIN. SEE LANDSCAPE PLANS AND ARBORIST'S REPORT FOR TREE PROTECTION DETAILS.

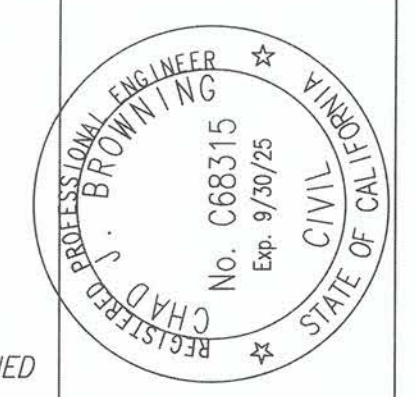

PREPARED UNDER THE DIRECTION OF:
 DATE: 9/20/23
 CHAD J. BROWNING
 CIVIL ENGINEER
 EXPIRES: 9-30-25


ACCEPTED FOR USE:
 JOHN SAMUELSON
 City Engineer
 Date: 9/26/23



**FRONTAGE ROAD
 LIVING GREEN TRAIL DESIGN
 DEMOLITION PLAN**
 CONTRACT NAME:
 CONTRACT NUMBER:

BY	DRAWN: CW
DATE	CHECKED: SC
REV	REVIEWED: CB
DESCRIPTION	DATE: 09/05/23
	SCALE: AS NOTED


SHEET NO.	8 OF 59
DWG. NO.	C-42

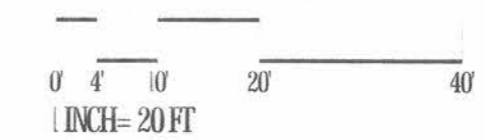



STATE OF CALIFORNIA
FREWAY ROUTE 4





LEGEND


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
SAWCUT LINE. CONTRACTOR SHALL SAWCUT WITH A NEAT, CLEAN EDGE. SAWCUT CONCRETE AT NEAREST JOINT TO SAWCUT LINE SHOWN ON PLAN.
- 

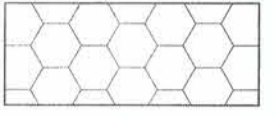
DEMOLISH AND REMOVE AC PAVING AND ANY ASSOCIATED BASE ROCK. STABILIZE THE EXISTING SUBGRADE. DEMOLISHED MATERIAL MAY BE USED AS BASE ROCK IF APPROVED BY GEOTECHNICAL ENGINEER.
- 

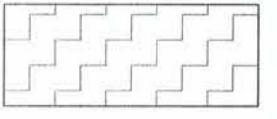
DEMOLISH AND REMOVE CONCRETE INCLUDING ANY ASSOCIATED BASE ROCK AND REBAR. STABILIZE THE EXISTING SUBGRADE. DEMOLISHED MATERIAL MAY BE USED AS BASE ROCK IF APPROVED BY THE GEOTECHNICAL ENGINEER.
- 

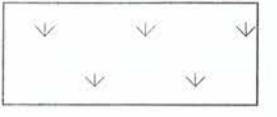
CLEAR AND GRUB EXISTING LANDSCAPE AREA SO NO ORGANICS ARE STILL PRESENT.
- 


DEMOLISH AND REMOVE EXISTING BUILDING, SEE ARCHITECTURAL PLANS FOR EXTENT OF BUILDING DEMOLITION. STABILIZE THE EXISTING SUBGRADE.
- 


DEMOLISH AND REMOVE EXISTING CURB AND GUTTER, INCLUDING ANY ASSOCIATED REBAR OR BASE ROCK. SAWCUT WITH NEAT, CLEAN EDGE.
- 


REMOVE EXISTING WALL OR FENCE INCLUDING ASSOCIATED FOOTINGS. RETURN FENCE TO OWNER.
- 


DEMOLISH AND REMOVE EX. UTILITY LINE. BACKFILL EMPTY TRENCH WITH APPROVED FILL PER GEOTECHNICAL REPORT.
- 

DEMOLISH AND REMOVE EX. UTILITY STRUCTURE
- 


CAP EXISTING UTILITY WHERE SHOWN PER UTILITY OWNERS SPECIFICATIONS AND REQUIREMENTS. IF PRESSURIZED UTILITY CONTRACTOR SHALL HAVE COMPETENT PROFESSIONAL DESIGN PIPE RESTRAINTS.
- 

DEMOLISH AND REMOVE EX. STREET LIGHT AND FOUNDATION
- 

PROTECT EXISTING UTILITY TO REMAIN
- 


REMOVE EXISTING TREE AND ROOT BALL. COORDINATE WITH LANDSCAPE ARCHITECT AND PROJECT ARBORIST PRIOR TO REMOVING ANY TREES.
- 

PROTECT EXISTING TREE TO REMAIN. SEE LANDSCAPE PLANS AND ARBORIST'S REPORT FOR TREE PROTECTION DETAILS.

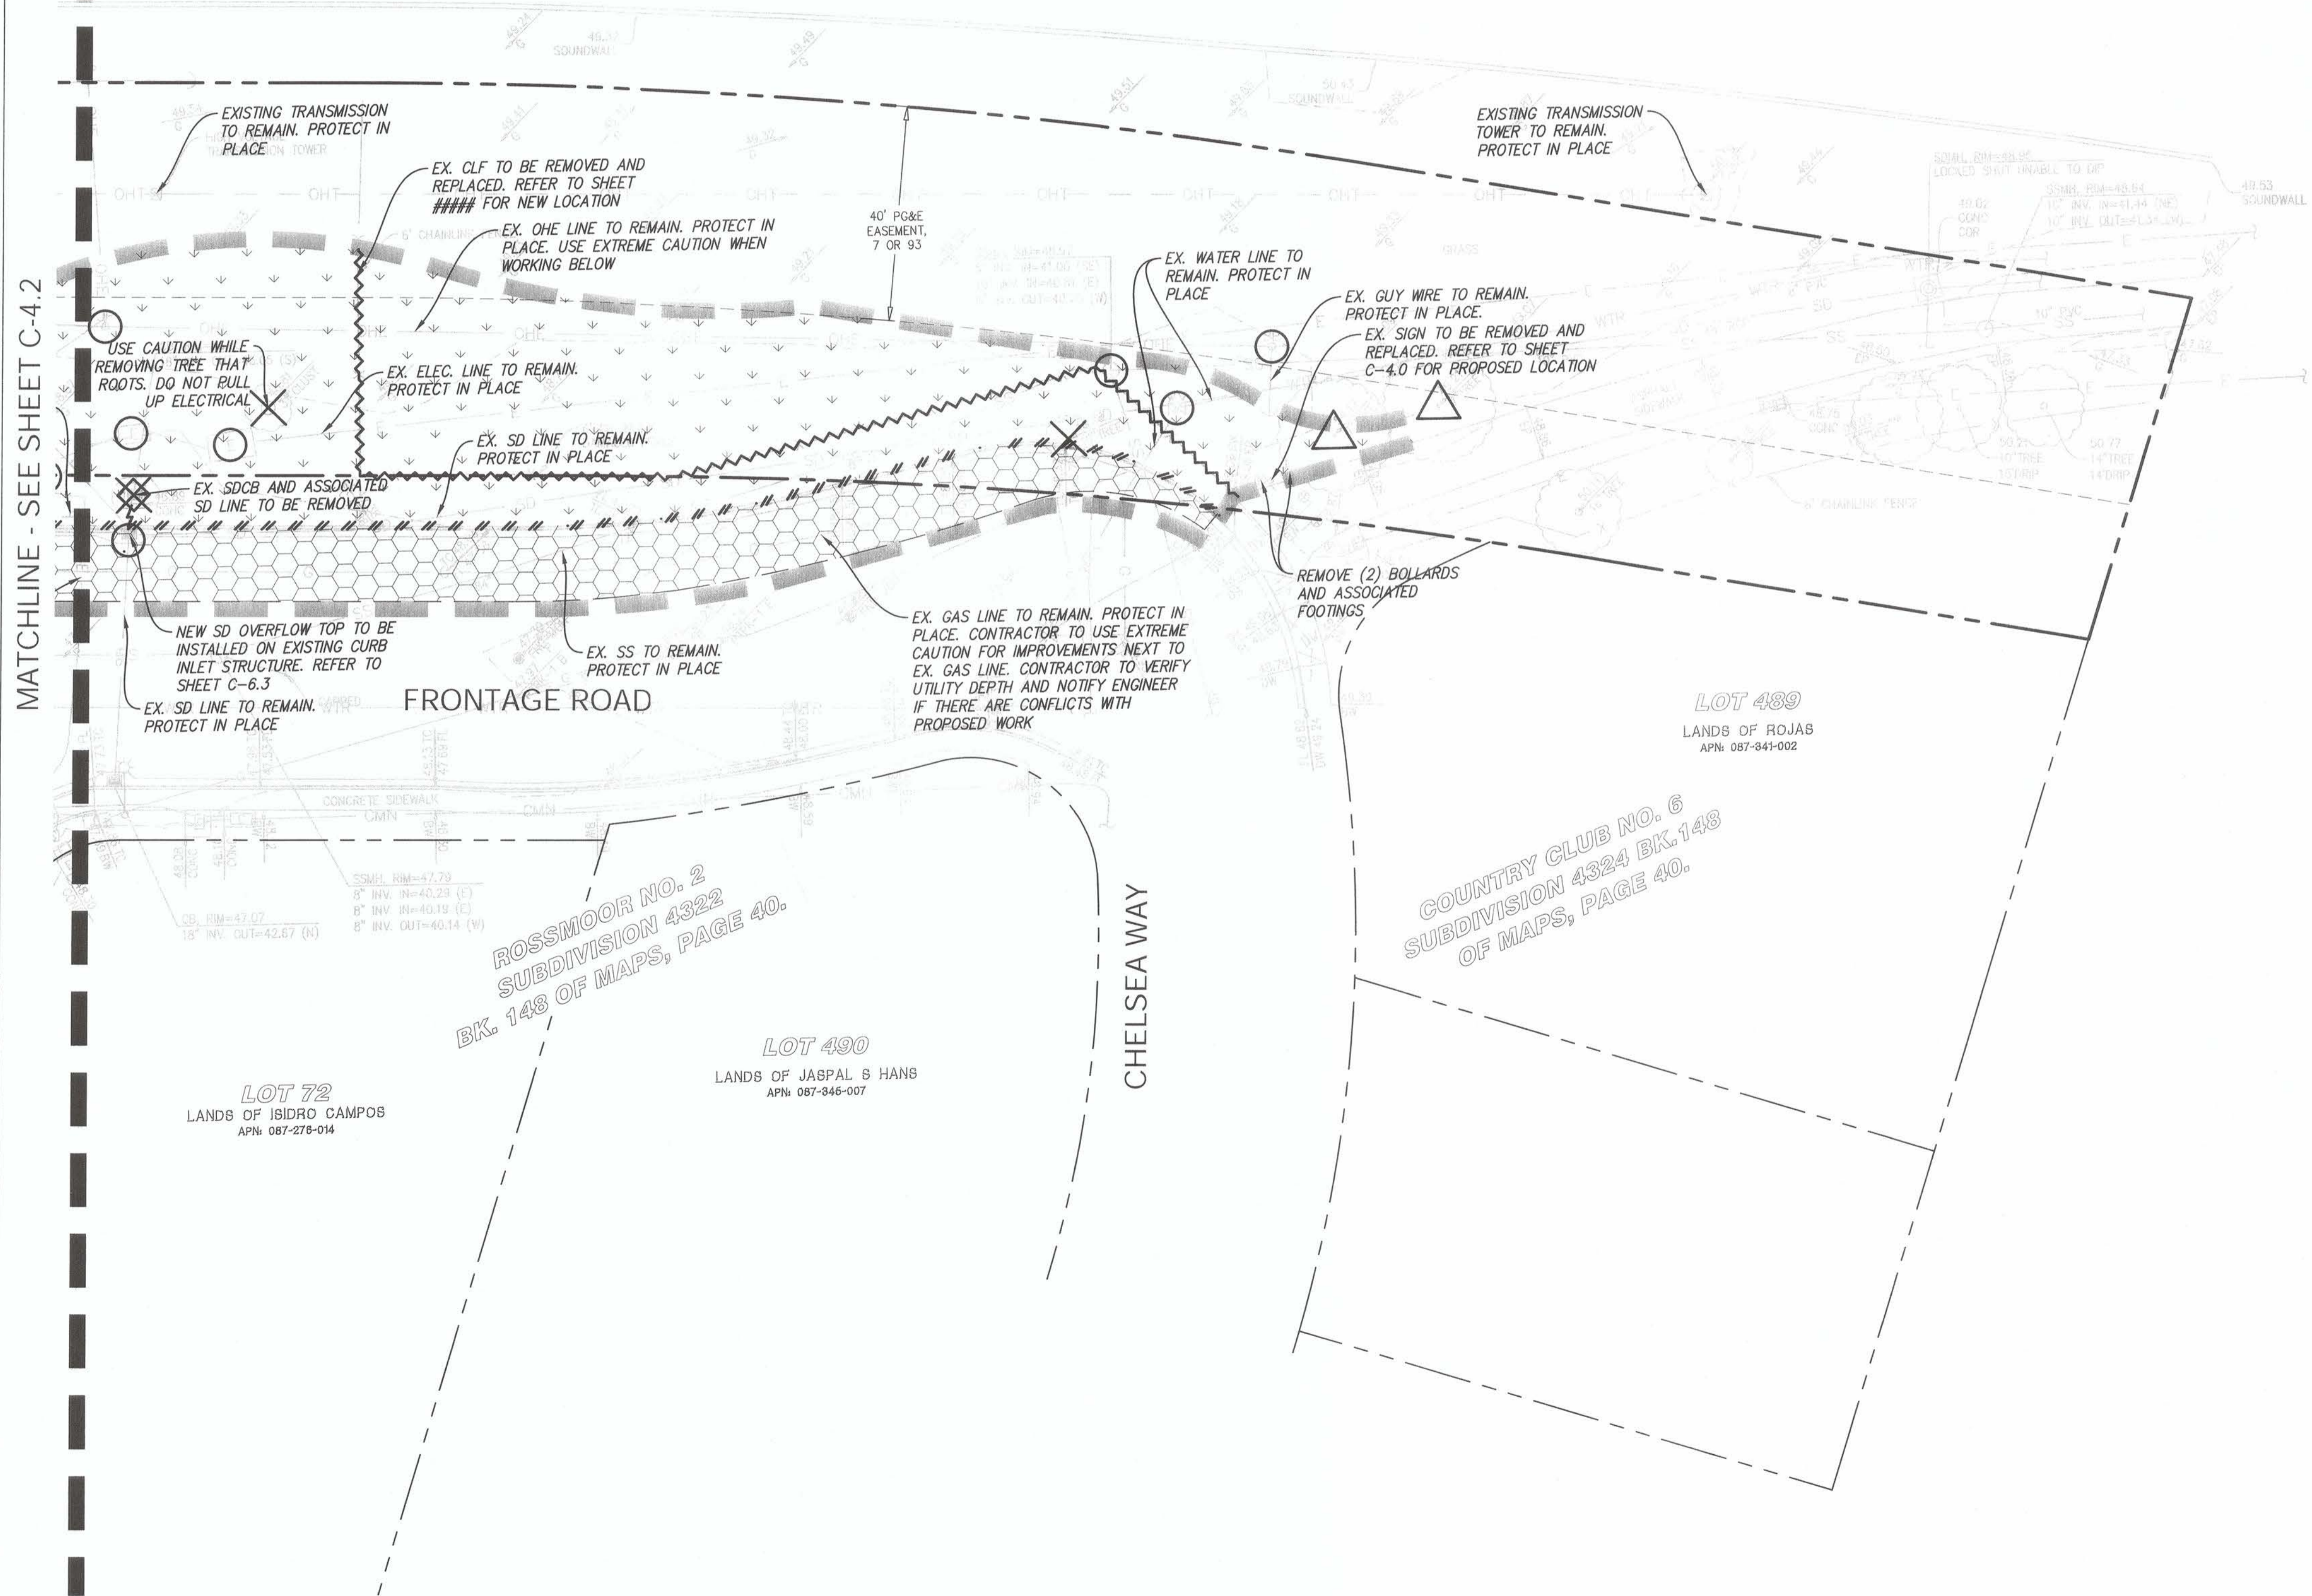

MATCHLINE - SEE SHEET C-4.2



PREPARED UNDER THE DIRECTION OF:

 DATE: 9/20/23
 CHAD J. BROWNING
 P.E. No. CB8315
 EXPIRES: 9-30-25

ACCEPTED FOR USE:


 JOHN SAMUELSON
 City Engineer
 Date: 9/26/23




**FRONTAGE ROAD
LIVING GREEN TRAIL DESIGN
DEMOLITION PLAN**
 CONTRACT NAME:
 CONTRACT NUMBER:

DATE	REV	DESCRIPTION	BY

SHEET NO.
9 OF 59
 DWG. NO.
C-43

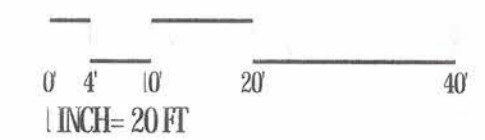

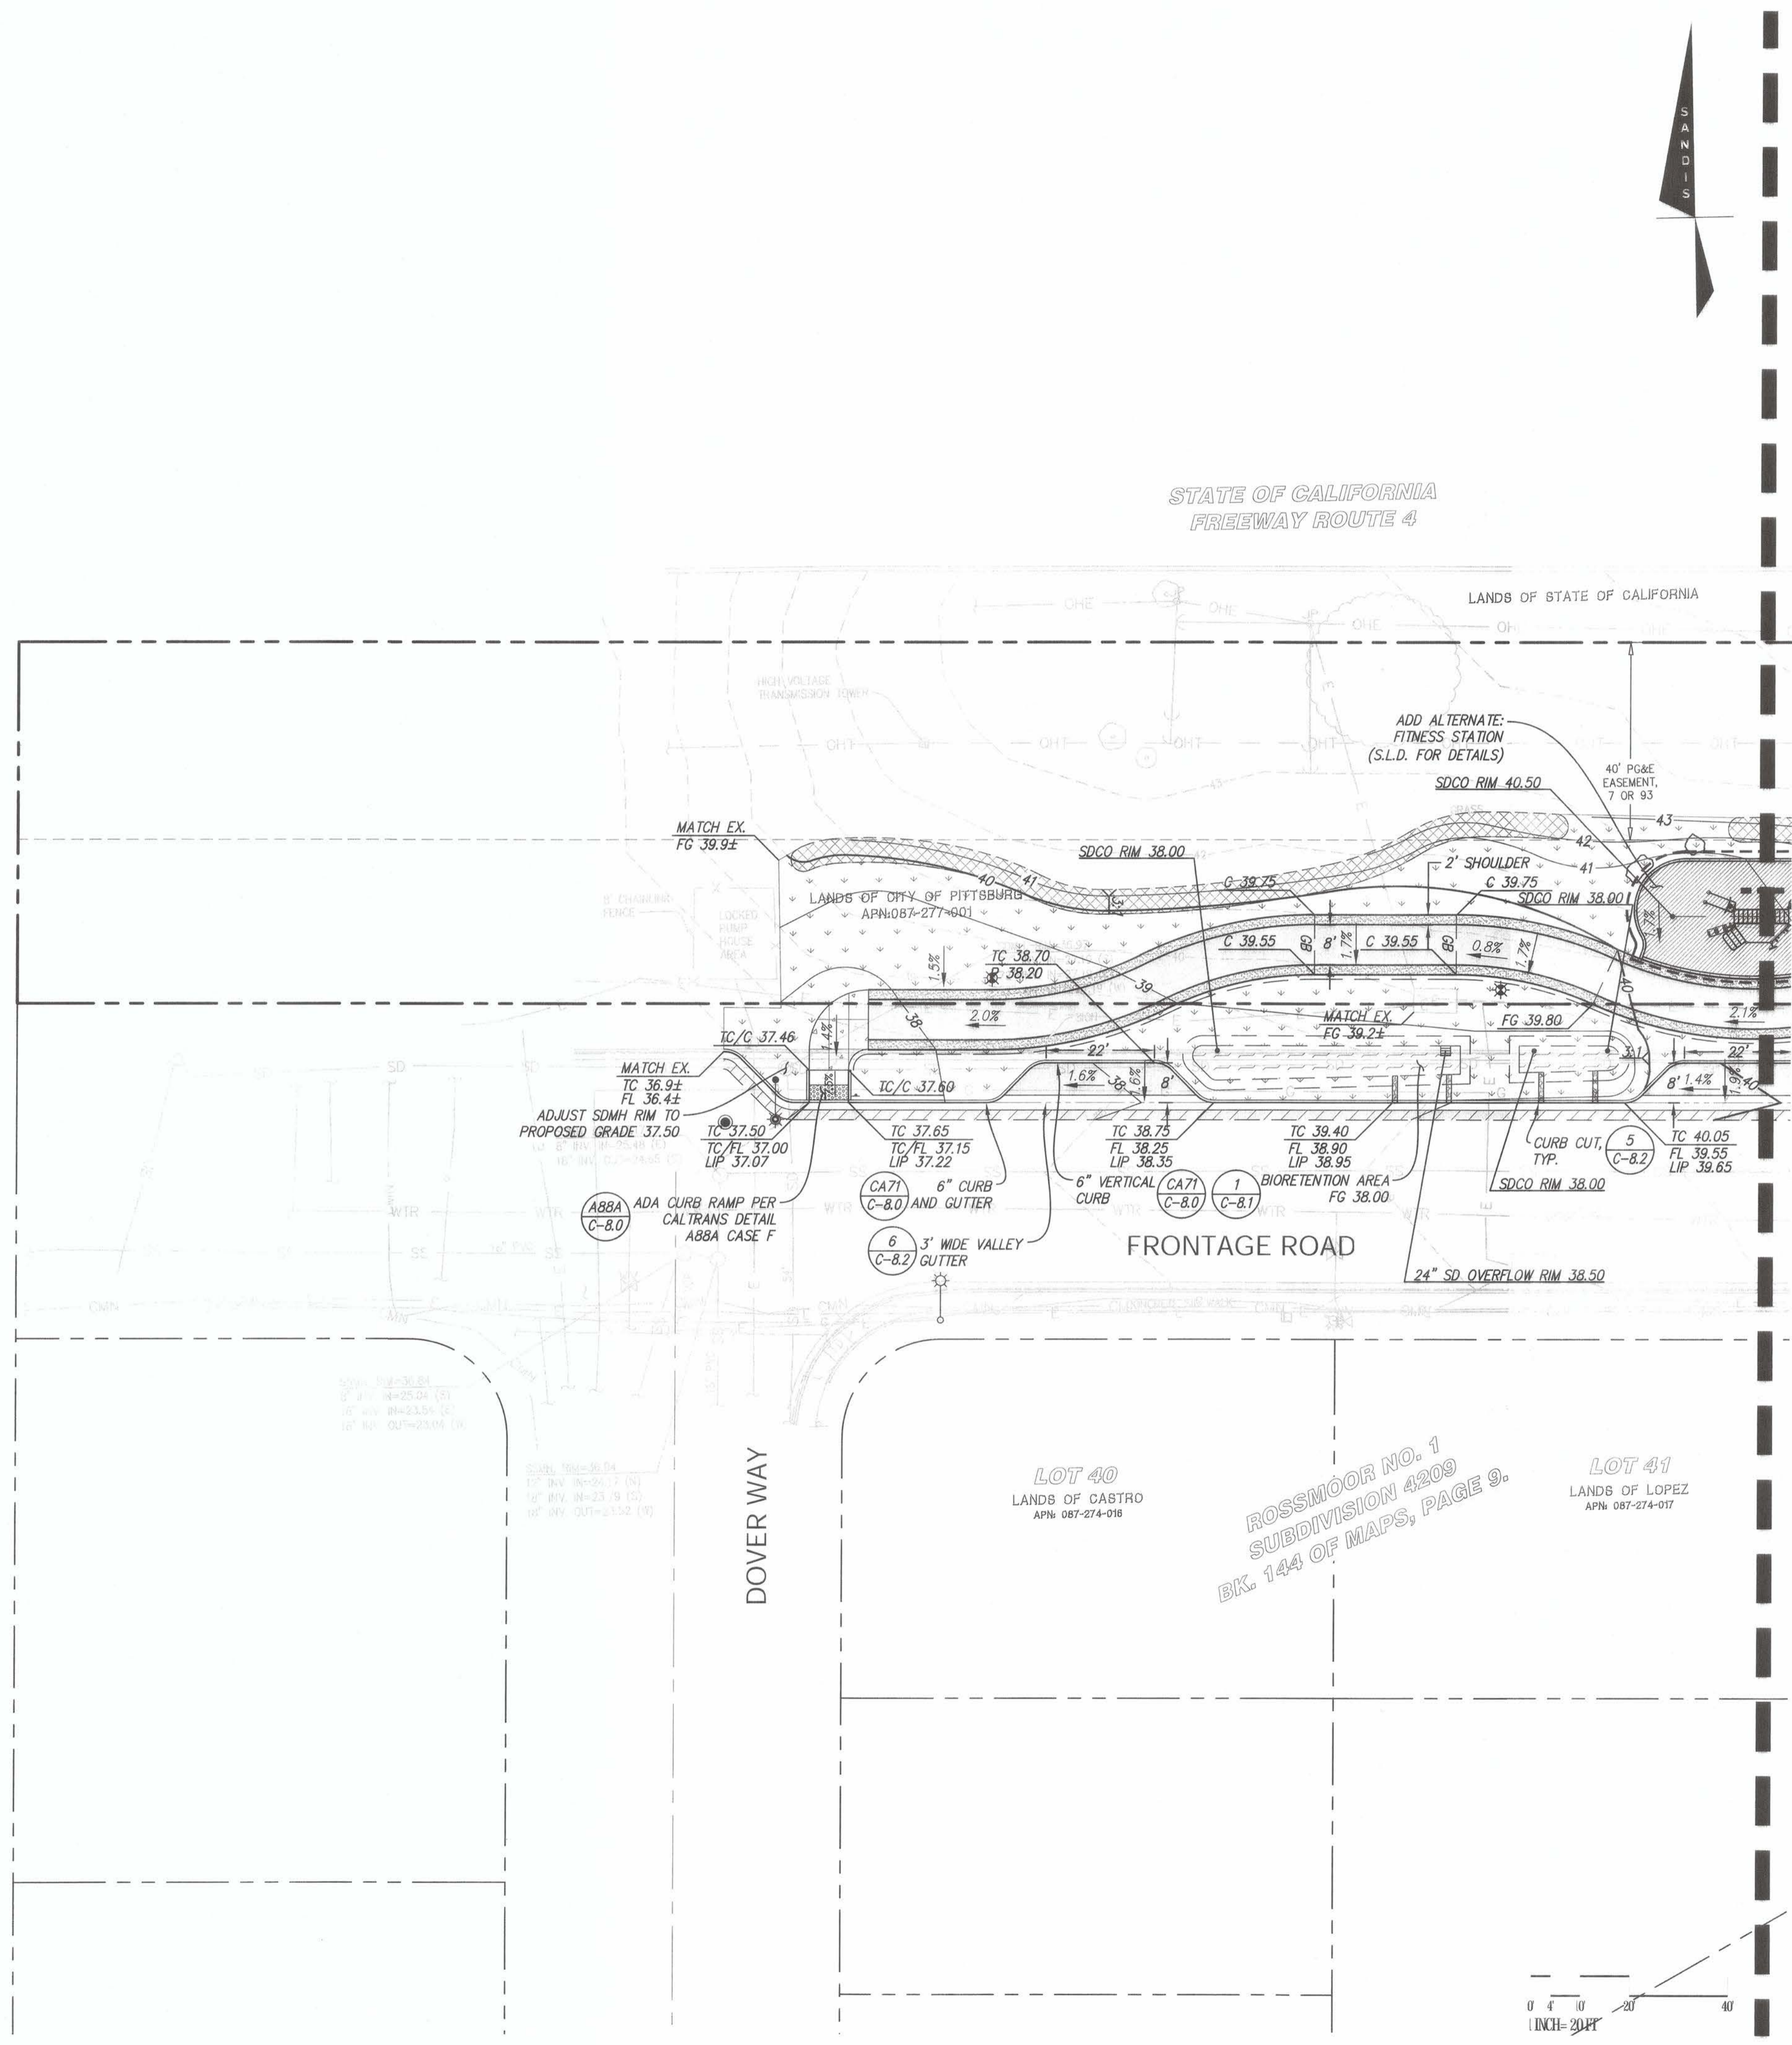


LEGEND

- PROPERTY LINE
- SAWCUT LINE
- DIRECTION OF STEEP SLOPE
- FLOW LINE
- GRADE BREAK
- CONTOURS
- AC PAVEMENT (1,2 / C-8.2)
- DEEP LIFT (4 / C-8.2)
- CONCRETE SIDEWALK (3 / C-8.2)
- PLANTING, S.L.D. FOR DETAILS
- BIO-TREATMENT AREA (1 / C-8.1)
- DECOMPOSED GRANITE, S.L.D. FOR DETAILS
- RIP-RAP, S.L.D. FOR DETAILS
- MULCH, S.L.D. FOR DETAILS

GRADING AND DRAINAGE NOTES:


1. ADJUST ALL UTILITY STRUCTURE RIMS/LIDS TO PROPOSED GRADE AND REPLACE ANY RIMS/LIDS THAT ARE IN A WALKWAY OR SIDEWALK WITH AN ACCESSIBLE RIM/LID.
2. CROSSWALK STRIPING TO BE INSTALLED BY CITY AFTER PROJECT COMPLETION.

MATCHLINE - SEE SHEET C-5.1

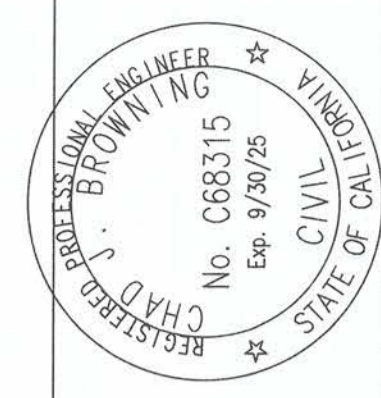

PREPARED UNDER THE DIRECTION OF:
Chad J. Browning
 CHAD J. BROWNING
 R.C.E. NO. 68315
 EXPIRES 9-30-25
 DATE: 9/20/23

ACCEPTED FOR USE:
John Samuelson
 JOHN SAMUELSON
 City Engineer
 Date: 9/26/23

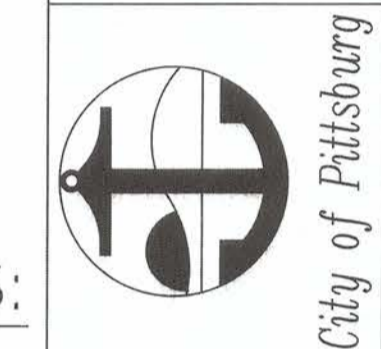



**FRONTAGE ROAD
 LIVING GREEN TRAIL DESIGN
 GRADING AND DRAINAGE PLAN**
 CONTRACT NAME:
 CONTRACT NUMBER:

BY	DESCRIPTION	DATE	REV
DRAWN: CW	CHECKED: SC	REVIEWED: CB	DATE: 09/05/23
			SCALE: AS NOTED

DATE	REV	DESCRIPTION

SHEET NO.
 10 OF 59
 DWG. NO.
C-50

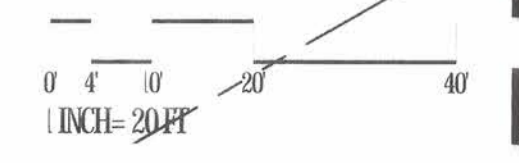

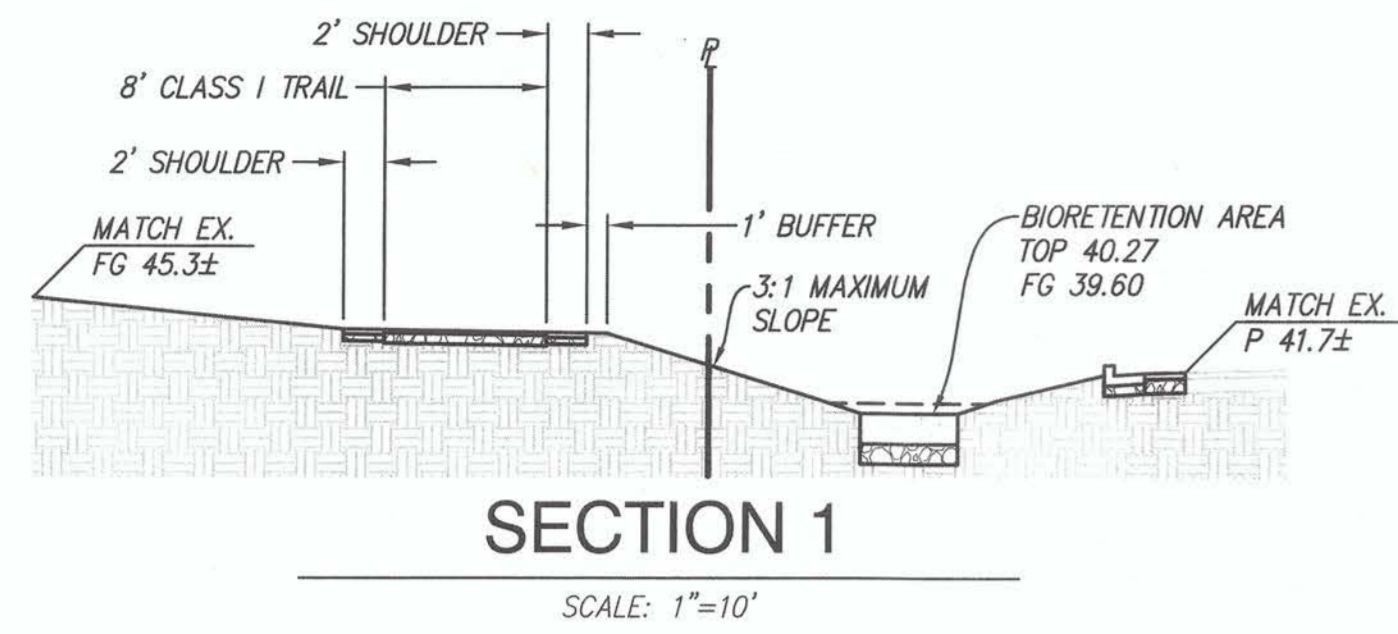


STATE OF CALIFORNIA
FREEWAY ROUTE 4

LANDS OF STATE OF CALIFORNIA

MATCHLINE - SEE SHEET C-5.0

MATCHLINE - SEE SHEET C-5.2

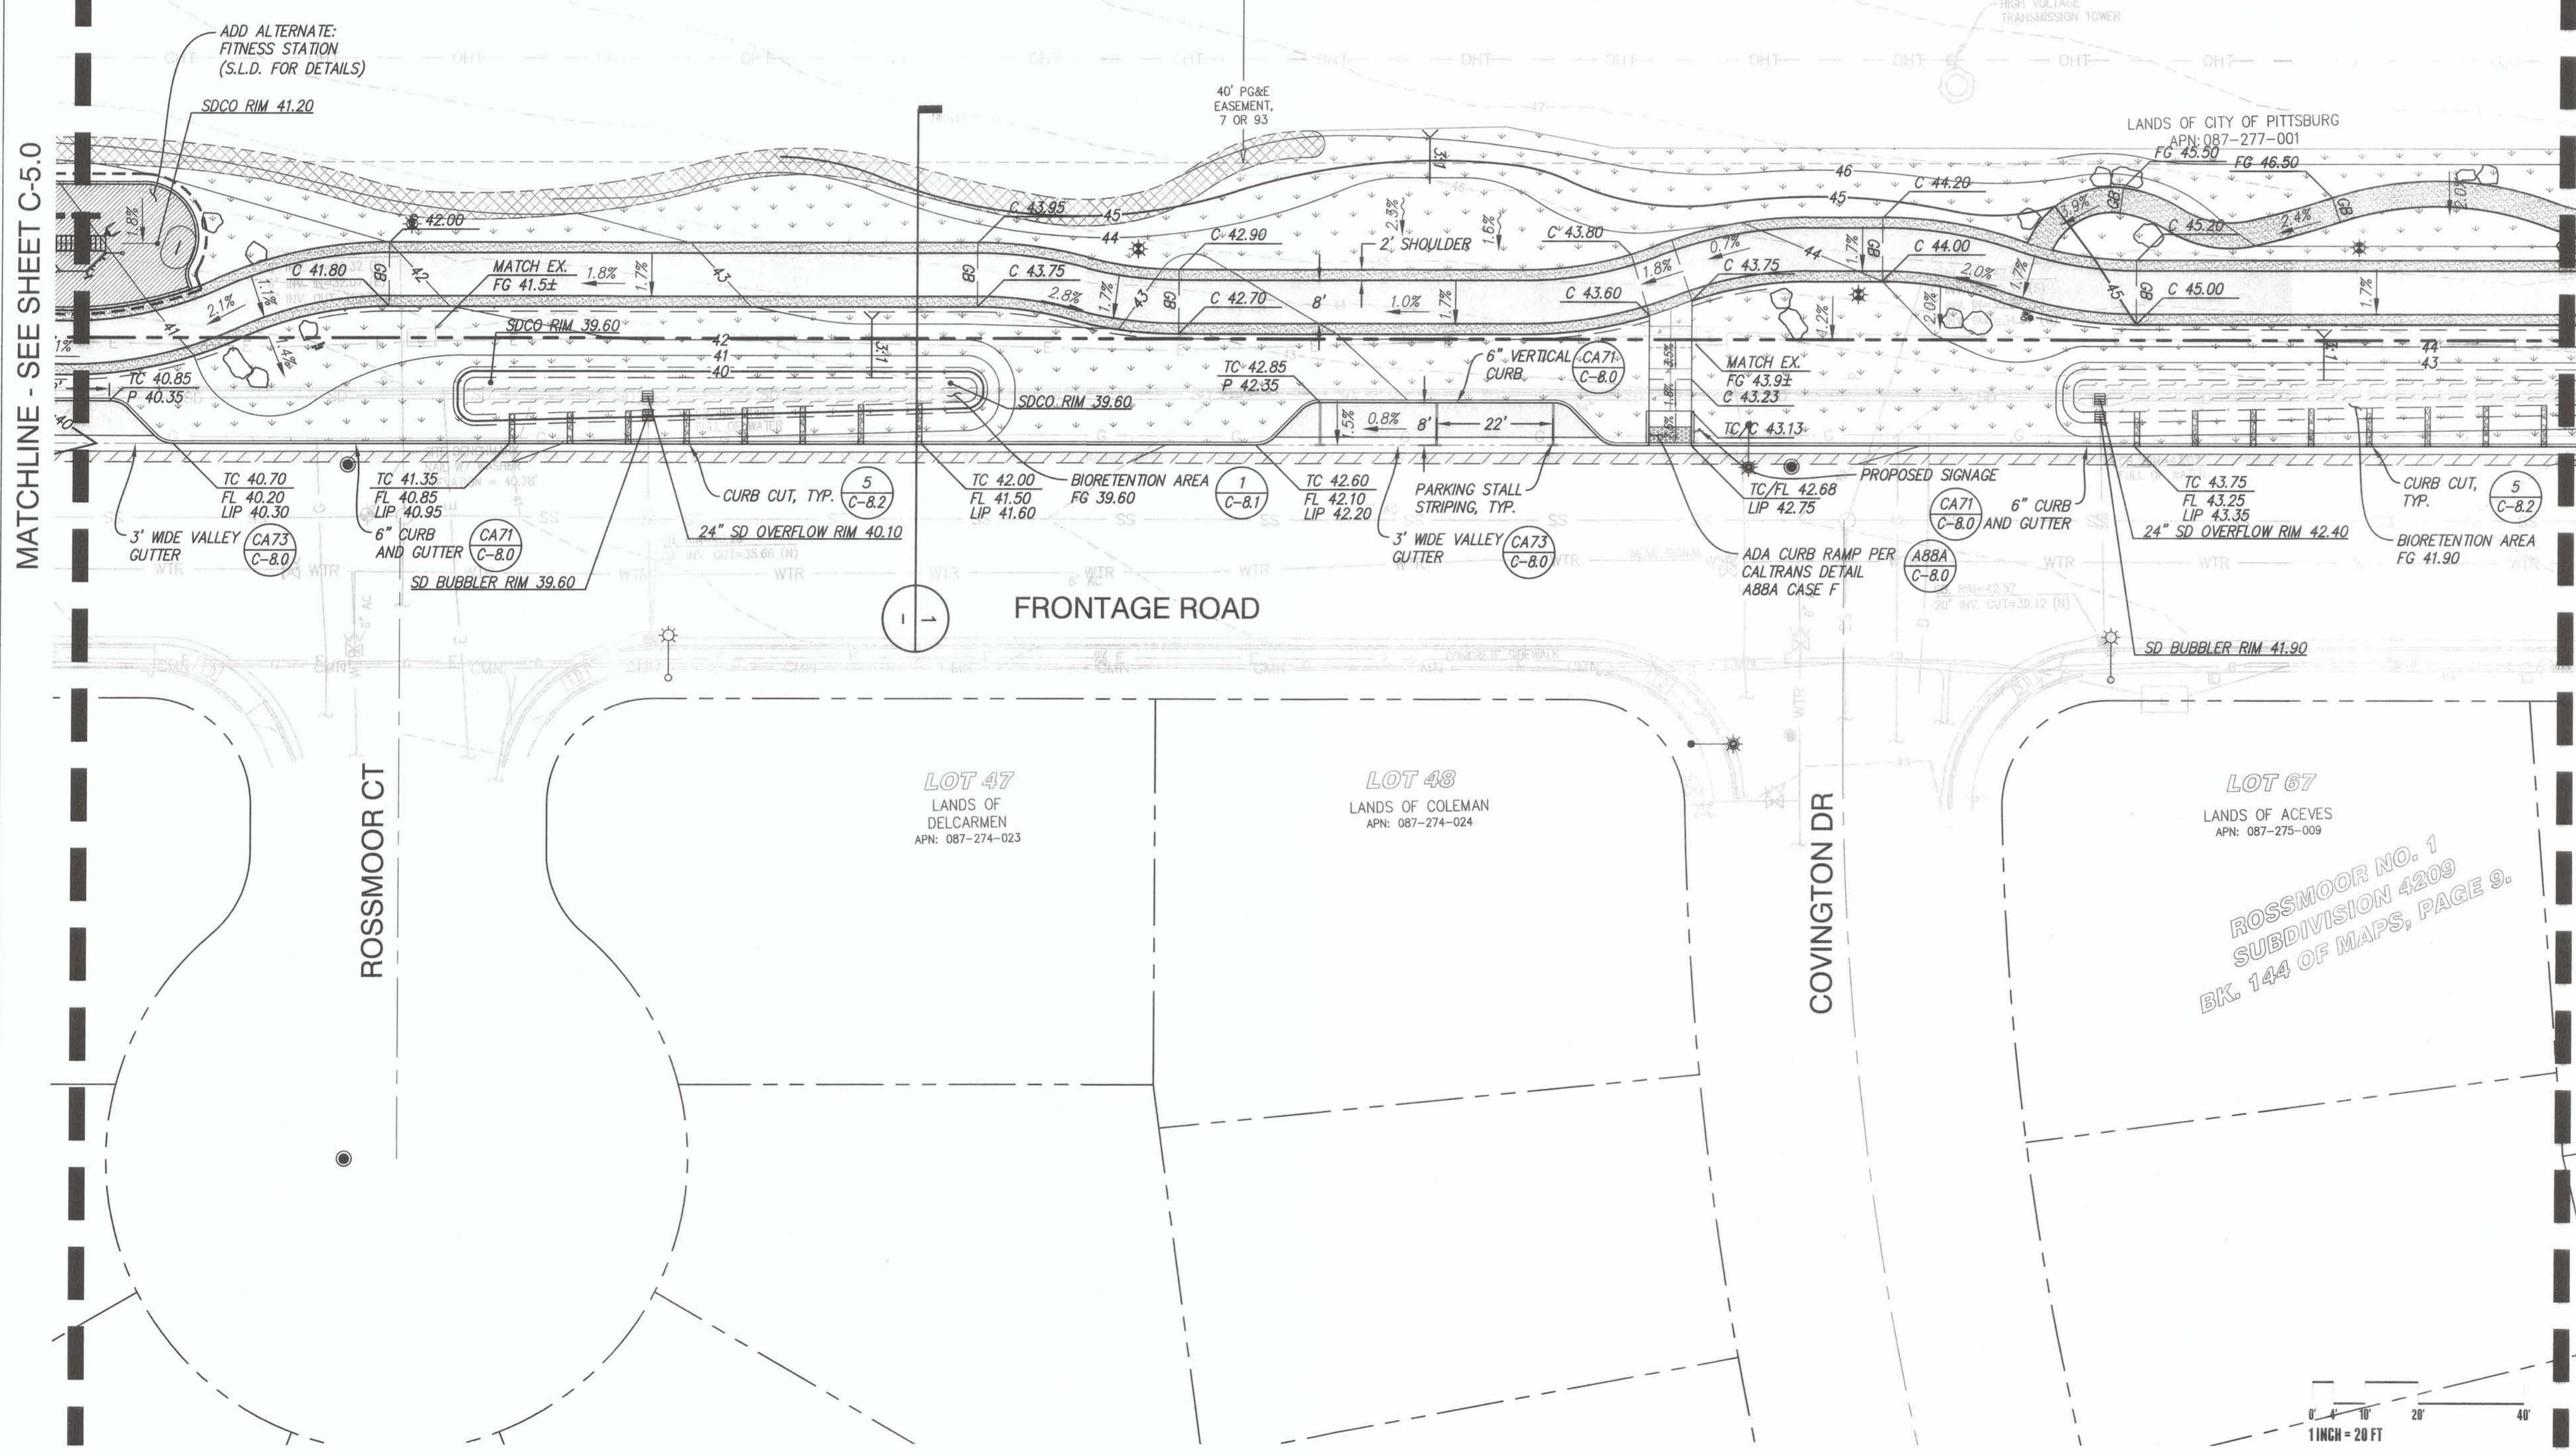

LEGEND

- PROPERTY LINE
- SAWCUT LINE
- DIRECTION OF STEEP SLOPE
- FLOW LINE
- GRADE BREAK
- CONTOURS
- 194
- 195
- AC PAVEMENT (1.2 C-8.2)
- DEEP LIFT (4 C-8.2)
- CONCRETE SIDEWALK (3 C-8.2)
- PLANTING, S.L.D. FOR DETAILS
- BIO-TREATMENT AREA (1 C-8.1)
- DECOMPOSED GRANITE, S.L.D. FOR DETAILS
- RIP-RAP, S.L.D. FOR DETAILS
- MULCH, S.L.D. FOR DETAILS

GRADING AND DRAINAGE NOTES:

1. ADJUST ALL UTILITY STRUCTURE RIMS/LIDS TO PROPOSED GRADE AND REPLACE ANY RIMS/LIDS THAT ARE IN A WALKWAY OR SIDEWALK WITH AN ACCESSIBLE RIM/LID.
2. CROSSWALK STRIPING TO BE INSTALLED BY CITY AFTER PROJECT COMPLETION.



PREPARED UNDER THE DIRECTION OF:
Chad L. Browning
DATE: 9/20/23

ACCEPTED FOR USE:
John Samuelson
City Engineer
DATE: 9/20/23




**FRONTAGE ROAD
LIVING GREEN TRAIL DESIGN
GRADING AND DRAINAGE PLAN**

CONTRACT NAME:
CONTRACT NUMBER:

DATE	REV	DESCRIPTION	BY	DRAWN: CW	CHECKED: SC	REVIEWED: CB	DATE: 09/05/23	SCALE: AS NOTED
SHEET NO. 11 OF 59								
DWG. NO. C-51								

ROSSMOOR NO. 1
SUBDIVISION 4209
BK. 144 OF MAPS, PAGE 9.

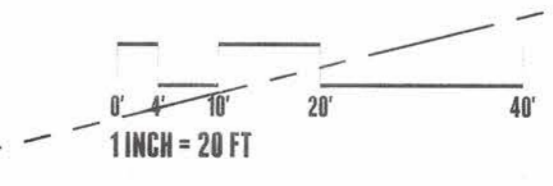

MATCHLINE - SEE SHEET C-5.1

MATCHLINE - SEE SHEET C-5.3





LEGEND

- PROPERTY LINE
- SAWCUT LINE
- DIRECTION OF STEEP SLOPE
- FLOW LINE
- GRADE BREAK
- CONTOURS
- AC PAVEMENT (1,2)
C-8.2
- DEEP LIFT (4)
C-8.2
- CONCRETE SIDEWALK (3)
C-8.2
- PLANTING, S.L.D. FOR DETAILS
- BIO-TREATMENT AREA (1)
C-8.1
- DECOMPOSED GRANITE, S.L.D. FOR DETAILS
- RIP-RAP, S.L.D. FOR DETAILS
- MULCH, S.L.D. FOR DETAILS

GRADING AND DRAINAGE NOTES:

1. ADJUST ALL UTILITY STRUCTURE RIMS/LIDS TO PROPOSED GRADE AND REPLACE ANY RIMS/LIDS THAT ARE IN A WALKWAY OR SIDEWALK WITH AN ACCESSIBLE RIM/LID.
2. CROSSWALK STRIPING TO BE INSTALLED BY CITY AFTER PROJECT COMPLETION.

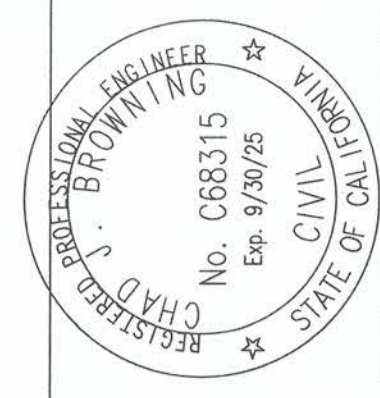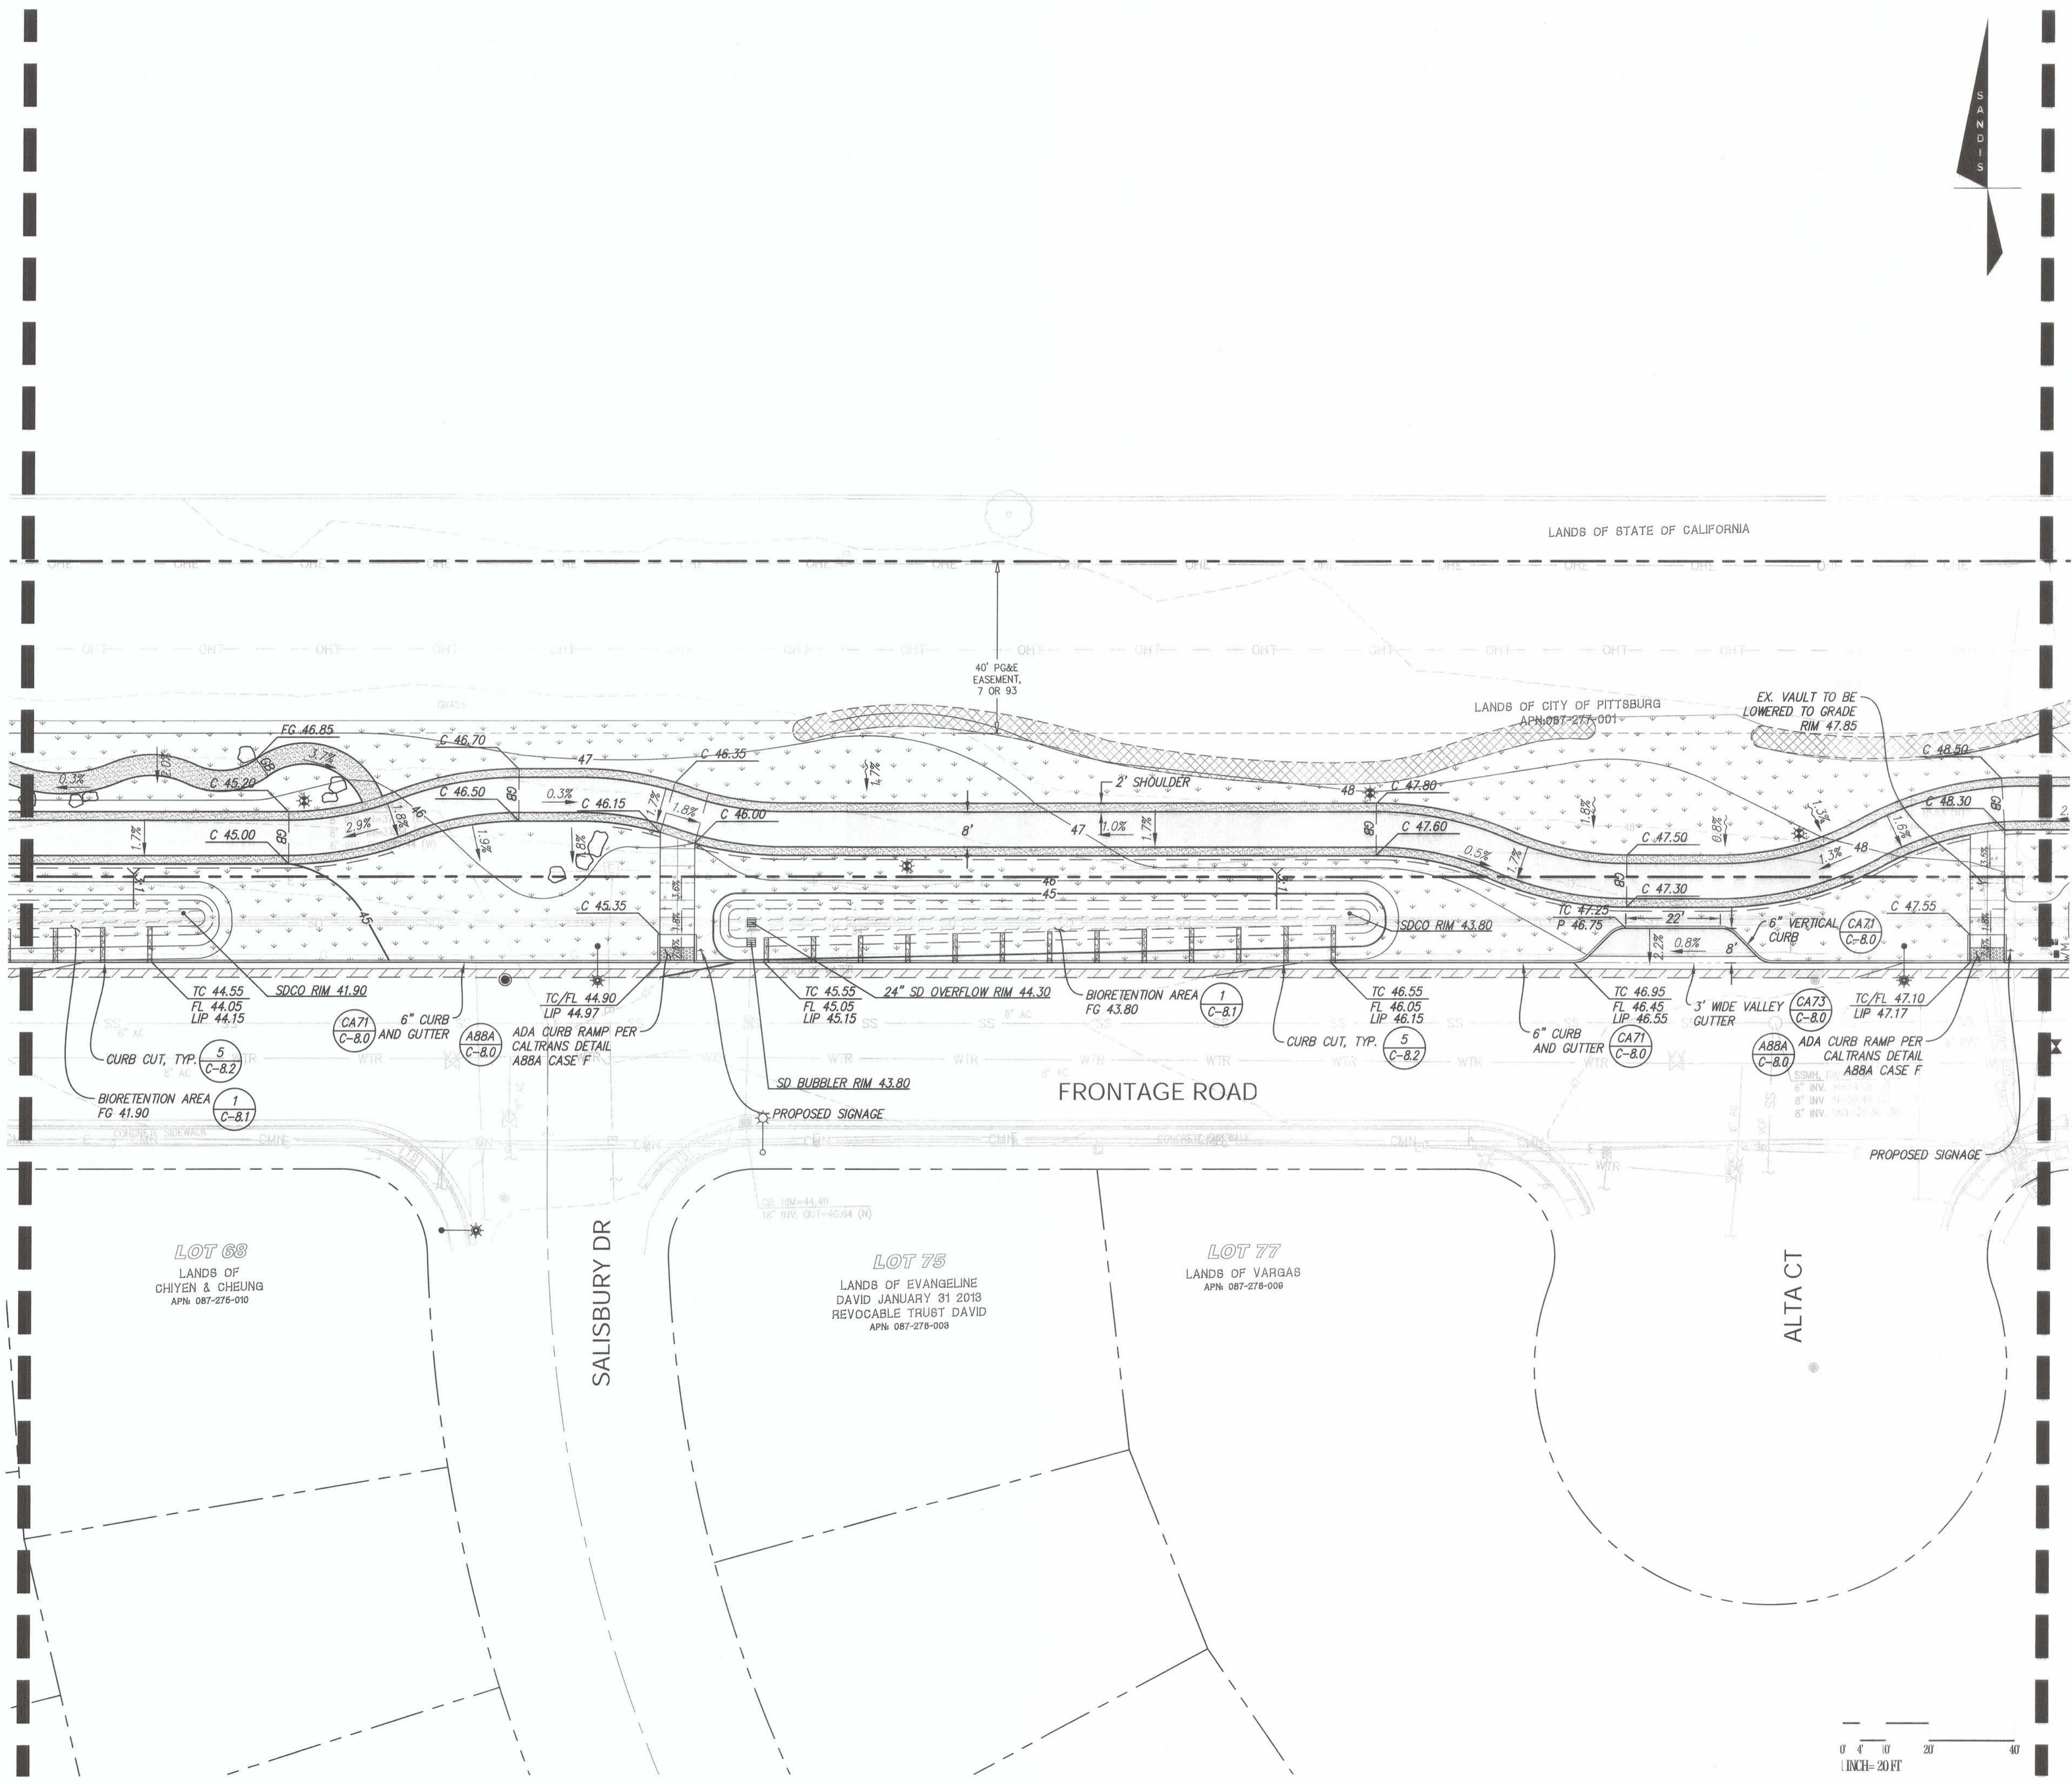

PREPARED UNDER THE DIRECTION OF:
 CHAD J. BROWNING
 R.C.E. NO. 68315
 EXPIRES 9-30-25
 DATE: 9/20/23

ACCEPTED FOR USE:
 JOHN SAMUELSON
 City Engineer
 Date: 9/26/23




**FRONTAGE ROAD
 LIVING GREEN TRAIL DESIGN
 GRADING AND DRAINAGE PLAN**
 CONTRACT NAME:
 CONTRACT NUMBER:

BY	DRAWN: CW
	CHECKED: SC
	REVIEWED: CB
	DATE: 09/05/23
	SCALE: AS NOTED


DATE	REV	DESCRIPTION

SHEET NO.
12 OF 59
 DWG. NO.
C-5.2

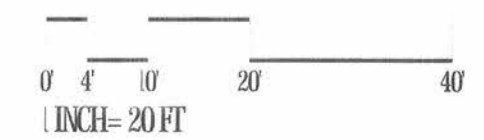

STATE OF CALIFORNIA
FREEWAY ROUTE 4

MATCHLINE - SEE SHEET C-5.2

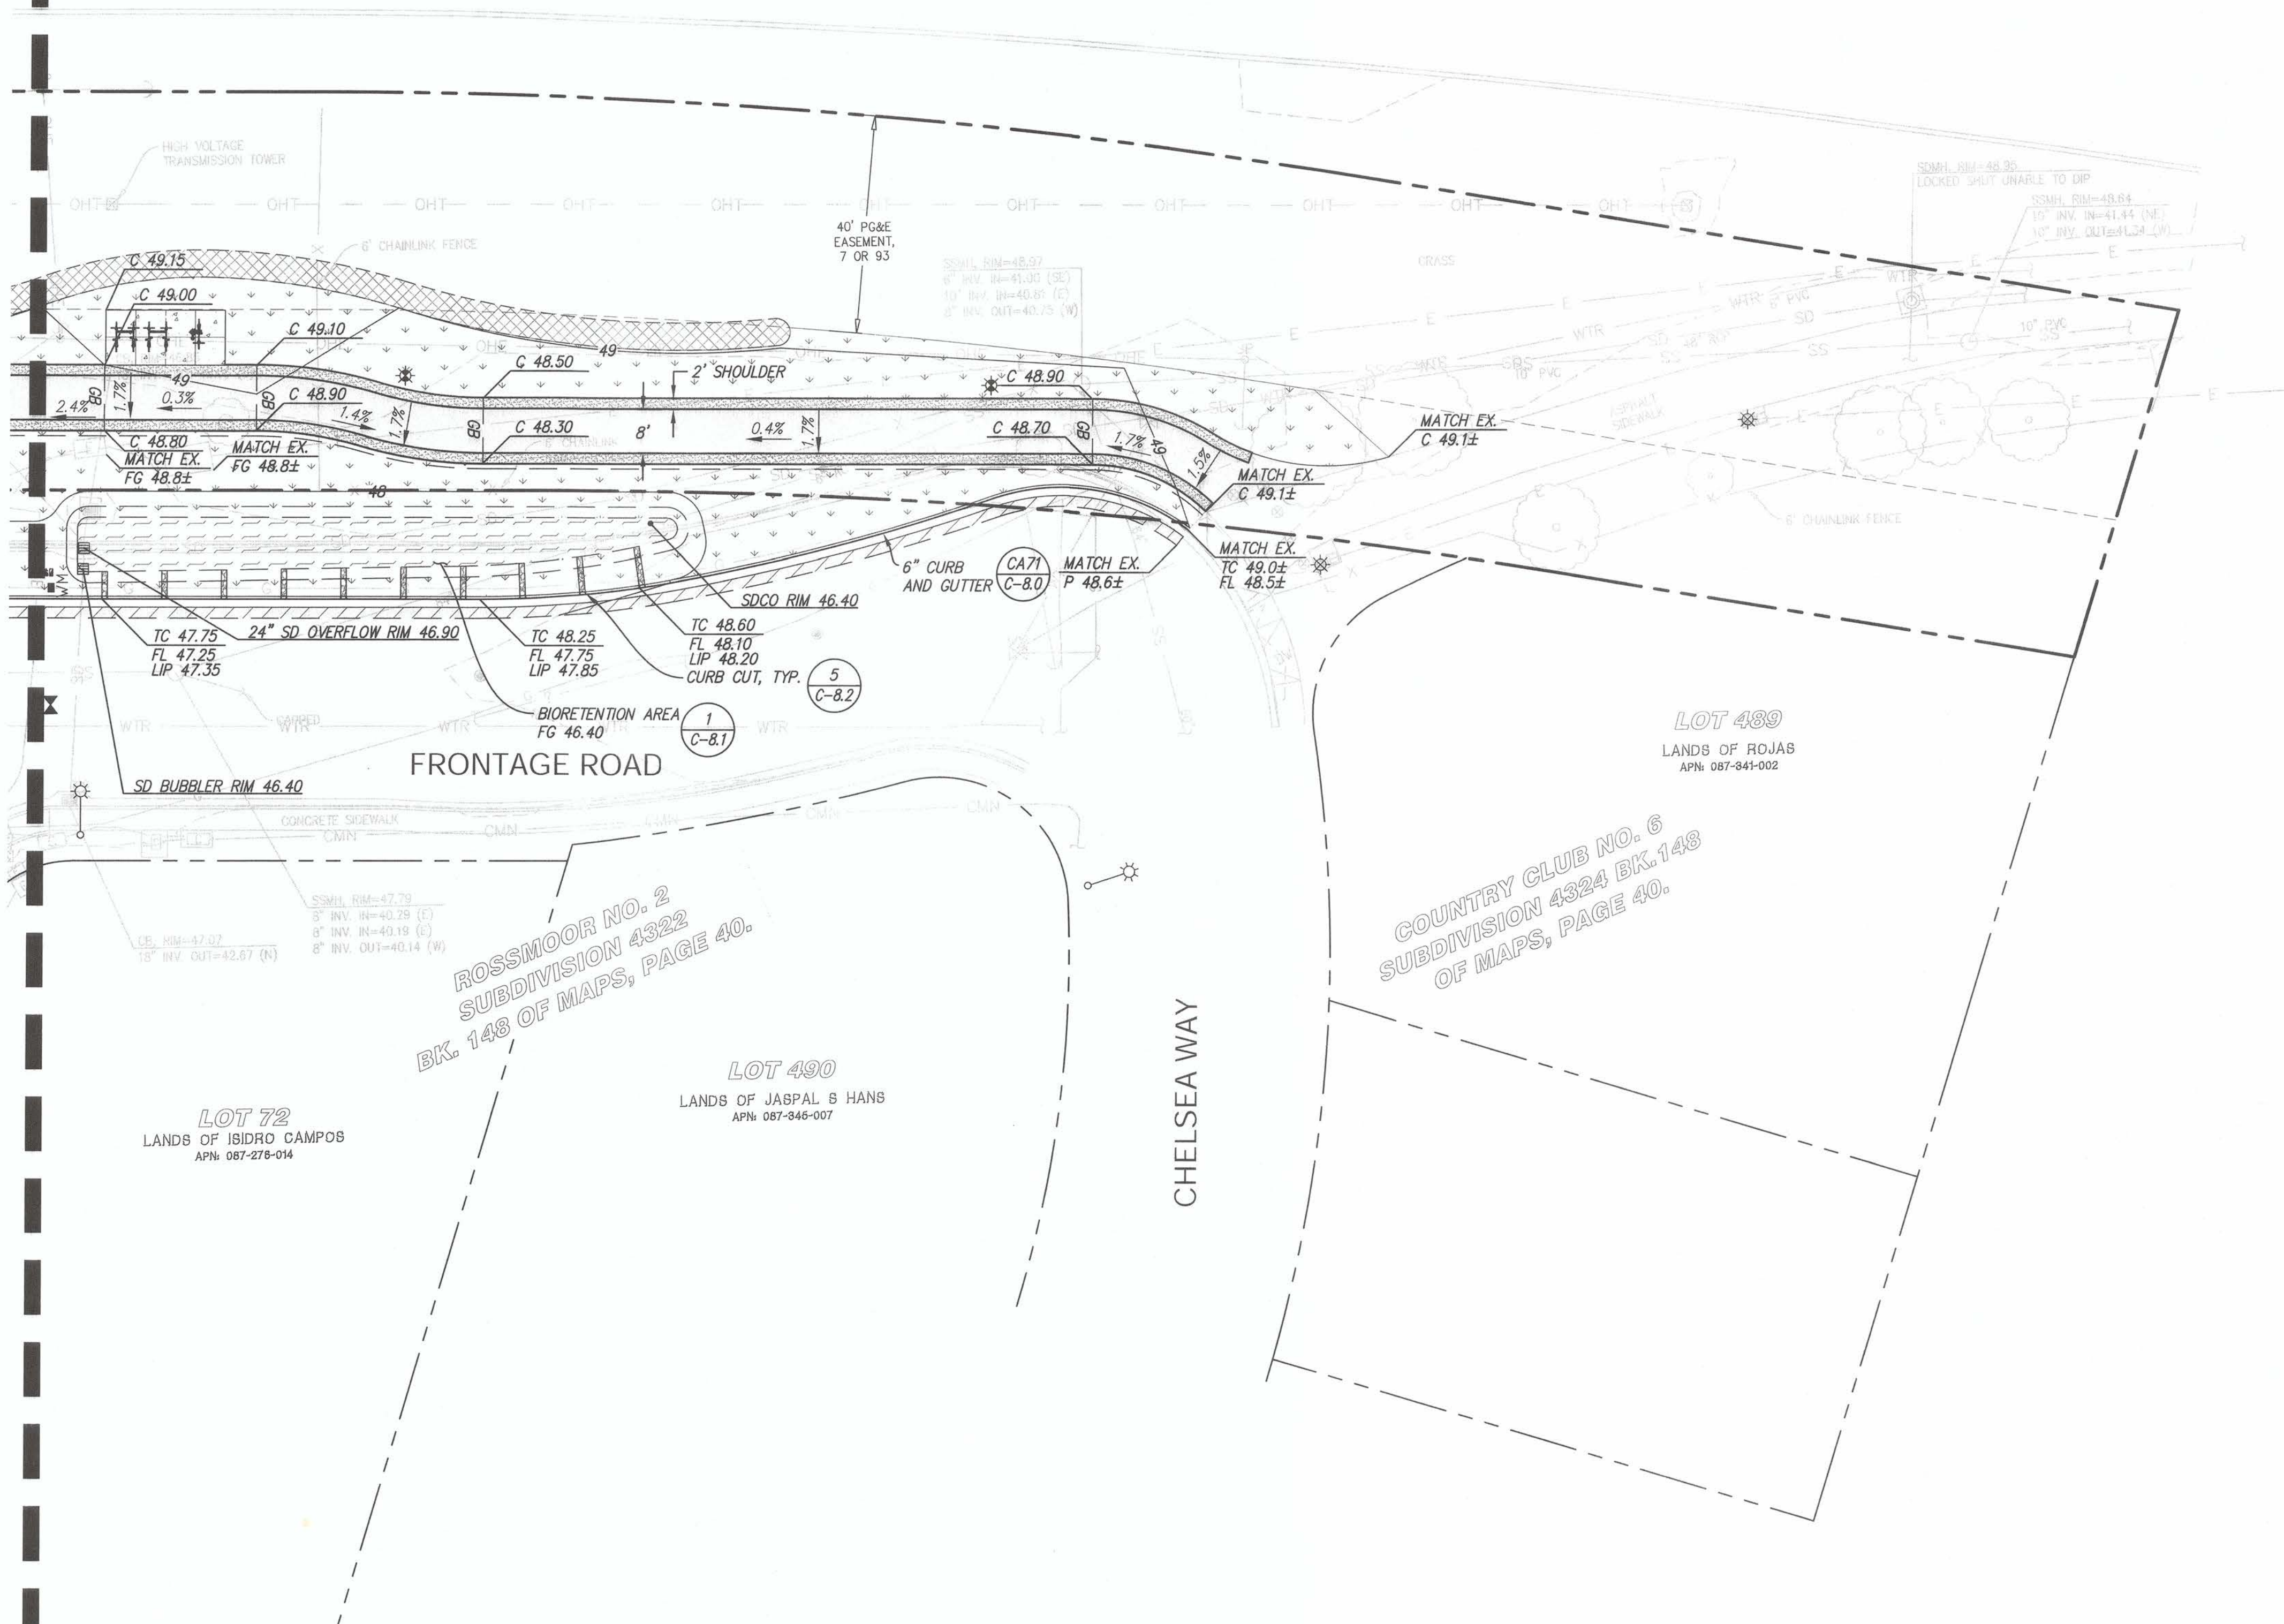

LEGEND

- PROPERTY LINE
- - - SAWCUT LINE
- DIRECTION OF STEEP SLOPE
- FLOW LINE
- - - GRADE BREAK
- CONTOURS
- AC PAVEMENT (1,2 / C-8.2)
- DEEP LIFT (4 / C-8.2)
- CONCRETE SIDEWALK (3 / C-8.2)
- PLANTING, S.L.D. FOR DETAILS
- BIO-TREATMENT AREA (1 / C-8.1)
- DECOMPOSED GRANITE, S.L.D. FOR DETAILS
- RIP-RAP, S.L.D. FOR DETAILS
- MULCH, S.L.D. FOR DETAILS

GRADING AND DRAINAGE NOTES:

1. ADJUST ALL UTILITY STRUCTURE RIMS/LIDS TO PROPOSED GRADE AND REPLACE ANY RIMS/LIDS THAT ARE IN A WALKWAY OR SIDEWALK WITH AN ACCESSIBLE RIM/LID.
2. CROSSWALK STRIPING TO BE INSTALLED BY CITY AFTER PROJECT COMPLETION.



PREPARED UNDER THE DIRECTION OF:
Chad J. Browning
DATE: 9/20/23
CHAD J. BROWNING
No. C68315
Exp. 9/30/25
REGISTERED PROFESSIONAL ENGINEER
CIVIL
STATE OF CALIFORNIA


ACCEPTED FOR USE:
John Samuelson
DATE: 9/26/23
JOHN SAMUELSON
City Engineer




FRONTAGE ROAD
LIVING GREEN TRAIL DESIGN
GRADING AND DRAINAGE PLAN
CONTRACT NAME:
CONTRACT NUMBER:

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DRAWN: CW		
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DATE: 09/05/23		
SCALE: AS NOTED		

SHEET NO.	13 OF 59
DWG. NO.	C-53

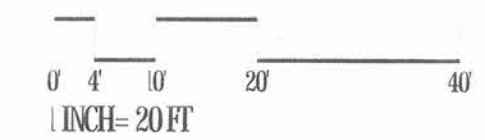

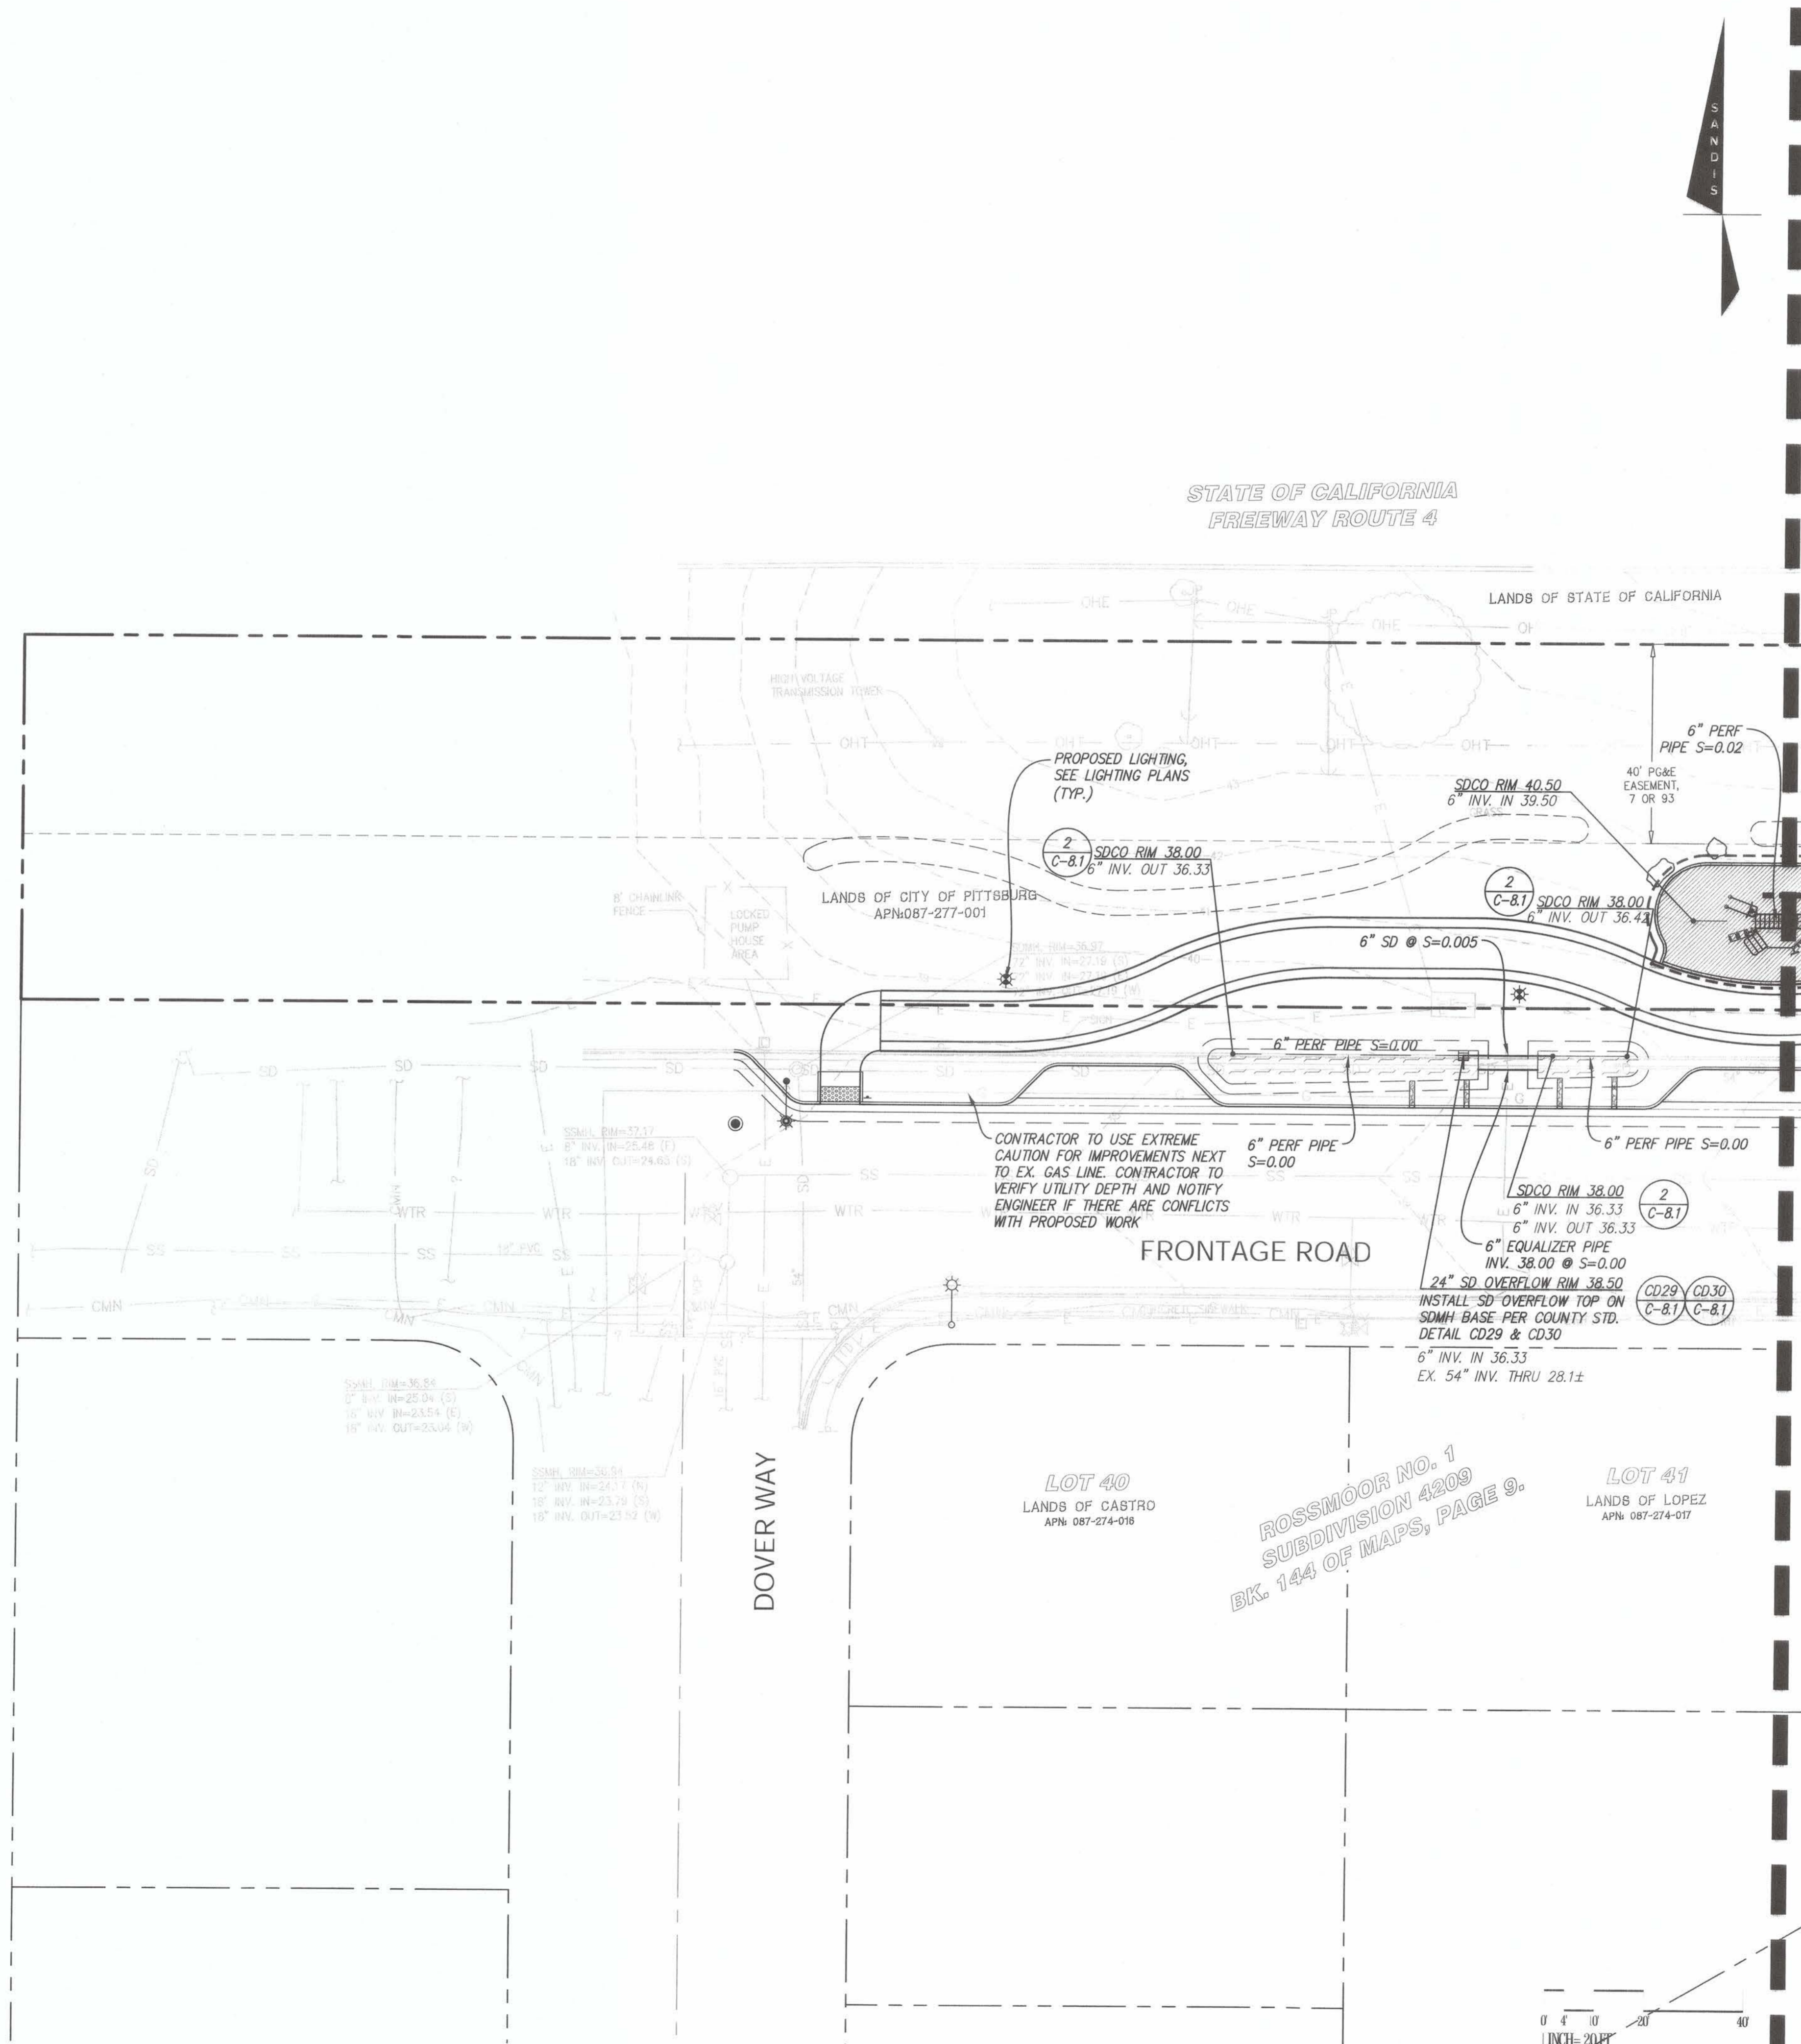

MATCHLINE - SEE SHEET C-6.1

LEGEND



STORM DRAIN NOTES

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- REFER TO CITY SANITARY SEWER DETAILS/NOTES S-1 AND S-2 ON SHEET C-8.3.

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PREPARED UNDER THE DIRECTION OF:
Chad J. Browning
DATE: 9/20/23

CHAD J. BROWNING
R.C.E. NO. 68315
EXPIRES 9-30-25

ACCEPTED FOR USE:
John Samuelson
City Engineer
Date: 9/26/23



**FRONTAGE ROAD
LIVING GREEN TRAIL DESIGN
UTILITY PLAN**


CONTRACT NAME:
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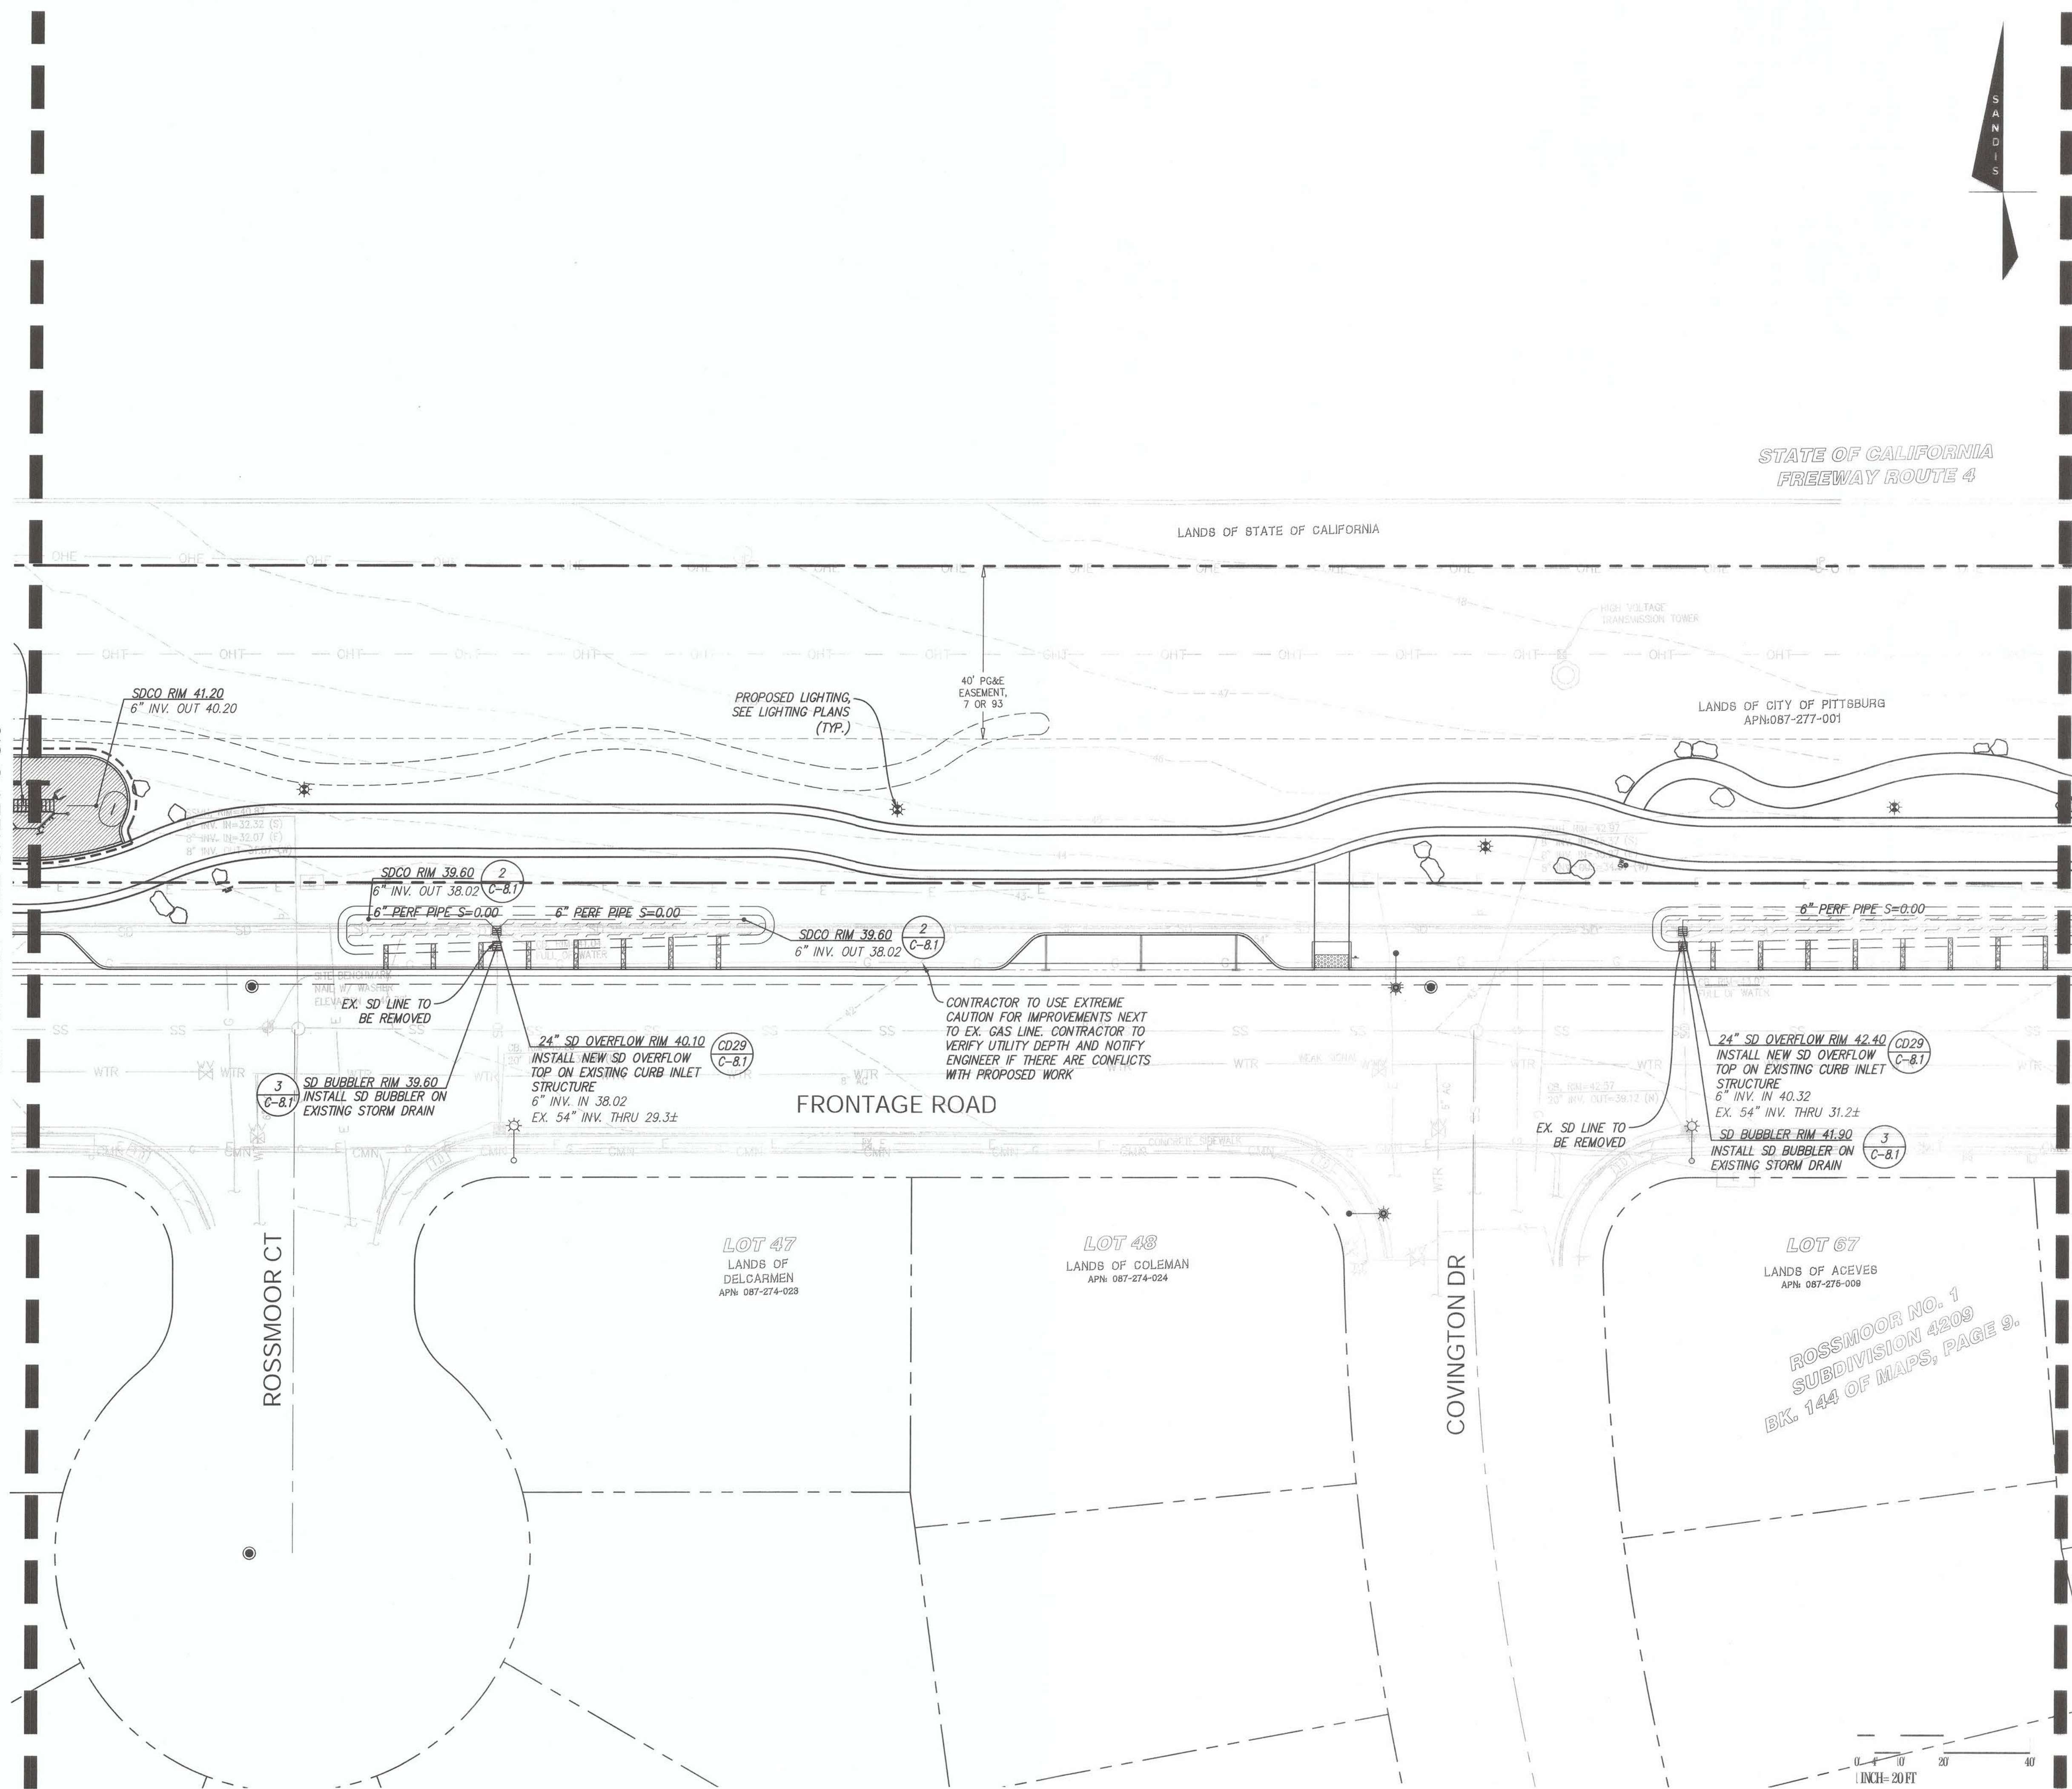
SHEET NO.
14 OF 59

DWG. NO.
C-6.0



MATCHLINE - SEE SHEET C-6.0

MATCHLINE - SEE SHEET C-6.2

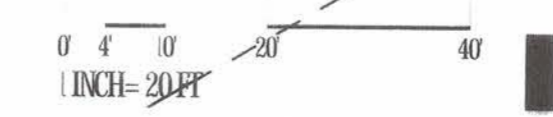

LEGEND



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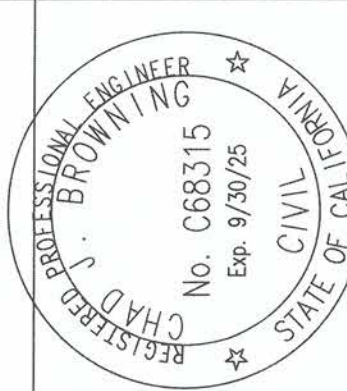
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PREPARED UNDER THE DIRECTION OF:
 Chad J. Browning
 R.C.E. No. 68315
 DATE: 9/20/23
 EXPIRES: 9-30-25

ACCEPTED FOR USE:
 JOHN SAMUELSON
 City Engineer
 Date: 9/22/23




FRONTAGE ROAD
 LIVING GREEN TRAIL DESIGN
 UTILITY PLAN
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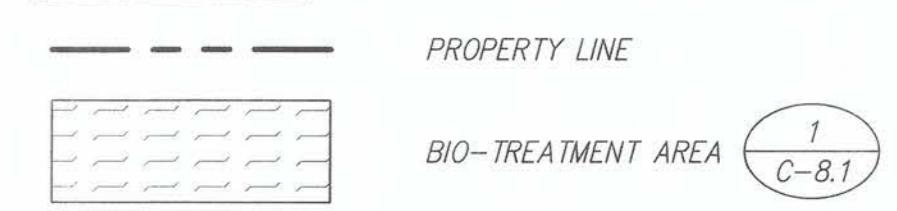
DATE	REV	DESCRIPTION

SHEET NO.
15 OF 59

DWG. NO.
C-6.1



LEGEND

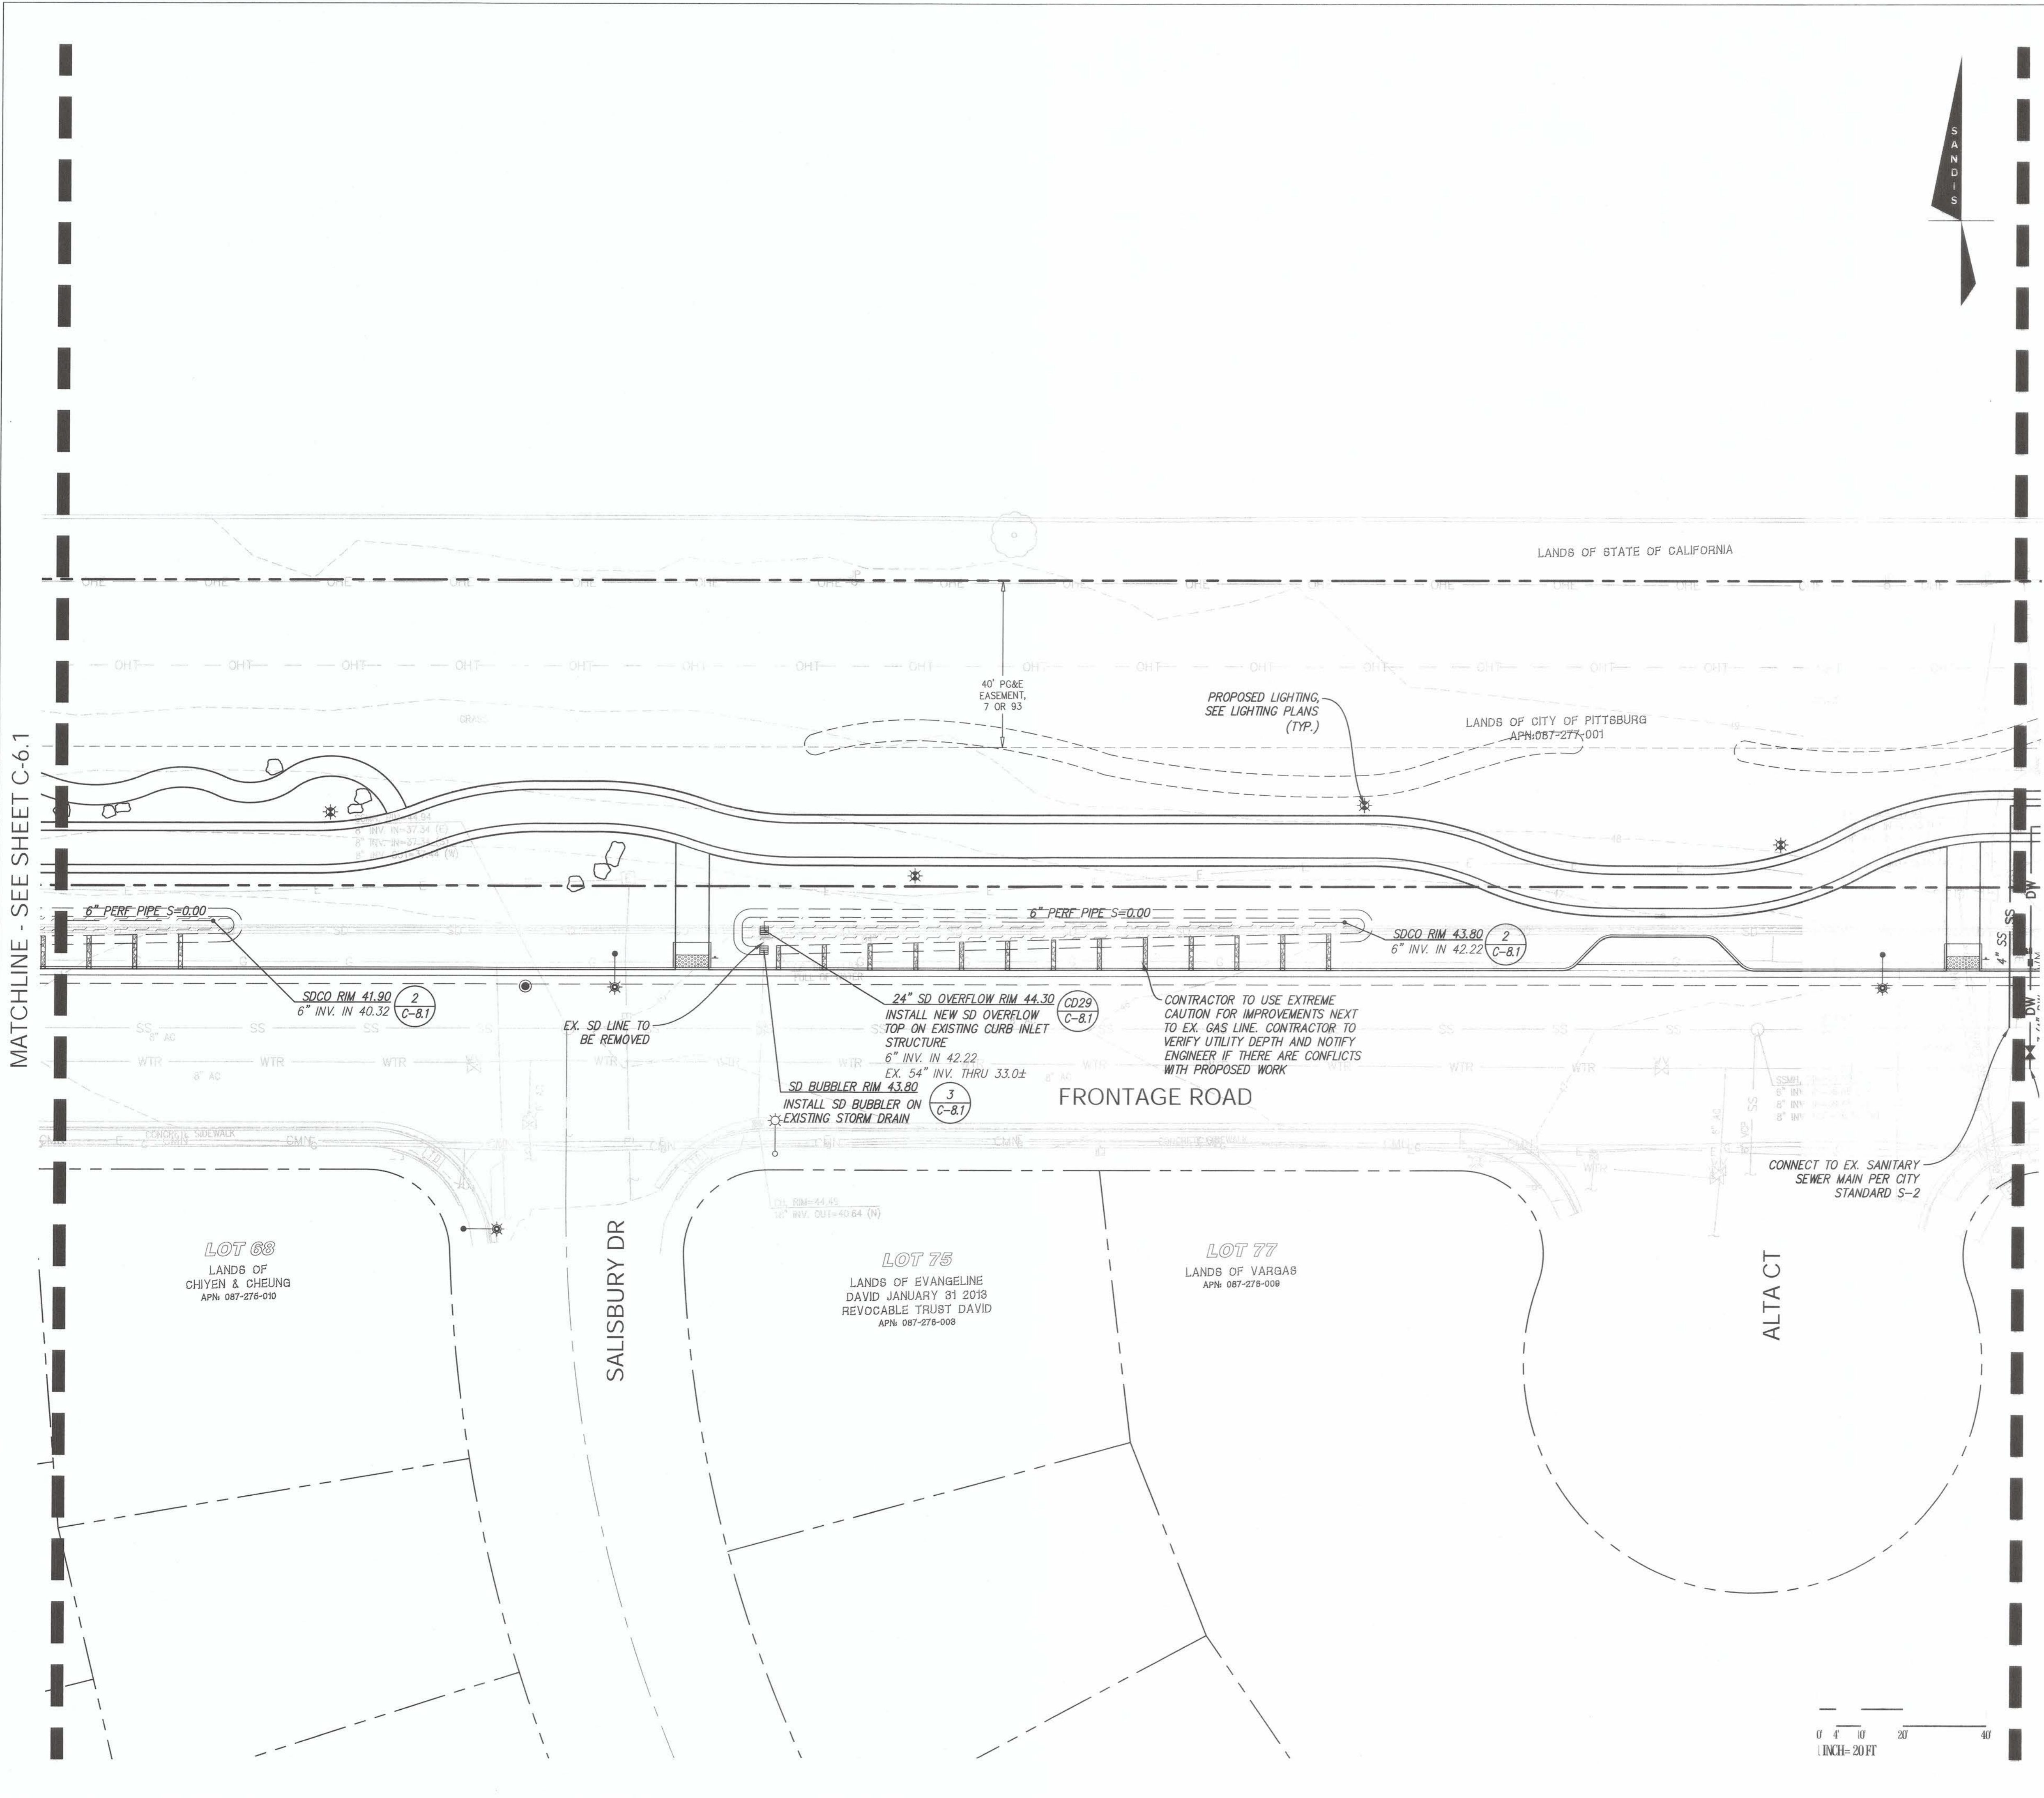

STORM DRAIN NOTES

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PREPARED UNDER THE DIRECTION OF:
 CHAD J. BROWNING
 R.C.E. NO. 68315
 EXPIRES 9-30-25

ACCEPTED FOR USE:
 JOHN SAMUELSON
 City Engineer
 Date: 9/24/23



**FRONTAGE ROAD
 LIVING GREEN TRAIL DESIGN
 UTILITY PLAN**
 CONTRACT NAME:
 CONTRACT NUMBER:

BY	DRAWN: CW	CHECKED: SC	REVIEWED: CB	DATE: 09/05/23	SCALE: AS NOTED
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DATE	REV	DESCRIPTION

SHEET NO.
 16 OF 59
 DWG. NO.
C-6.2

STATE OF CALIFORNIA
FREEWAY ROUTE 4

LEGEND



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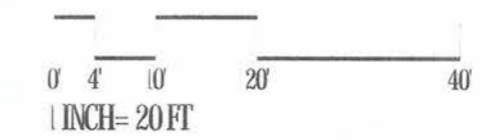
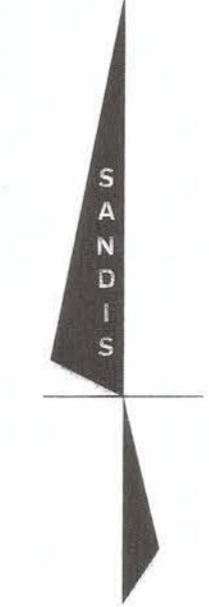
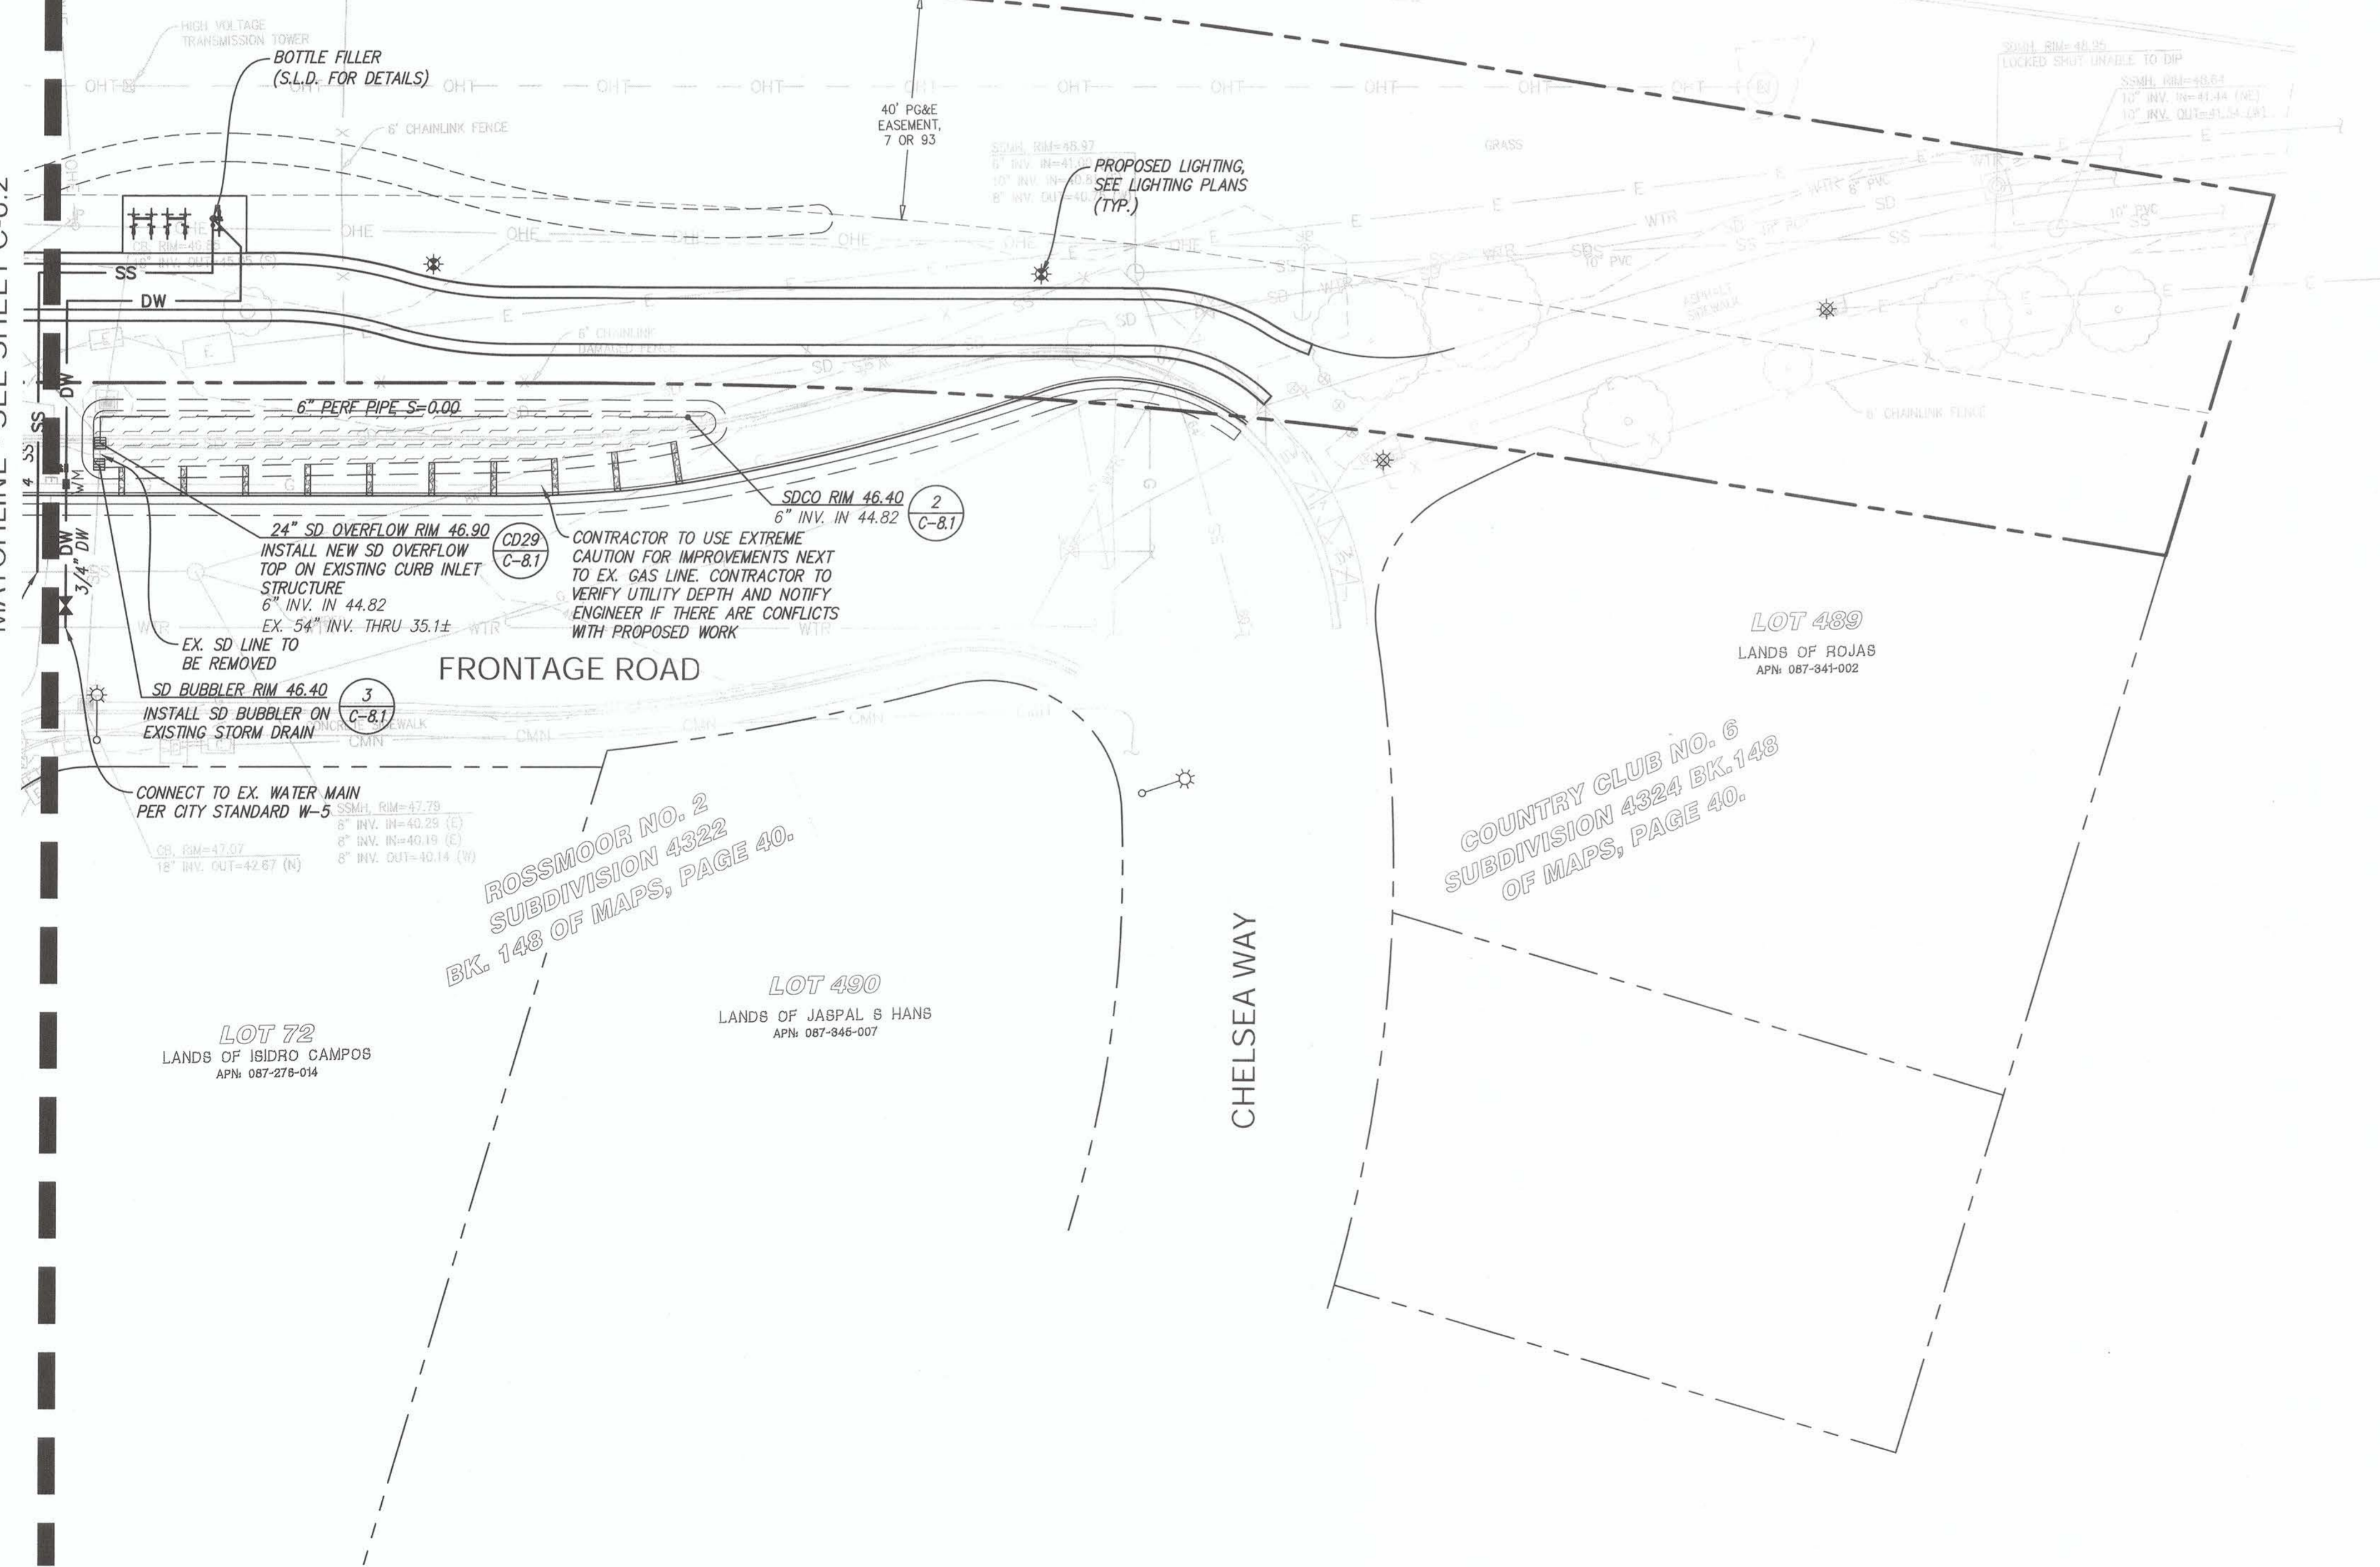
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MATCHLINE - SEE SHEET C-6.2



PREPARED UNDER THE DIRECTION OF:
Chad J. Browning
DATE: 9/20/23
CHAD J. BROWNING
CIVIL ENGINEER
EXPIRES 9-30-25

ACCEPTED FOR USE:
John Samuelson
JOHN SAMUELSON
City Engineer
Date: 9/25/23



FRONTAGE ROAD
LIVING GREEN TRAIL DESIGN
UTILITY PLAN
CONTRACT NAME:
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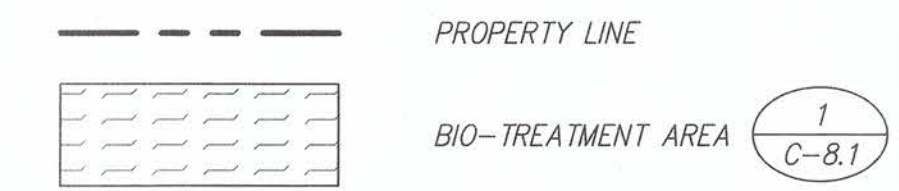
SHEET NO.
17 OF 59

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C-6.3

STATE OF CALIFORNIA
FREEWAY ROUTE 4



LEGEND



STORM DRAIN NOTES

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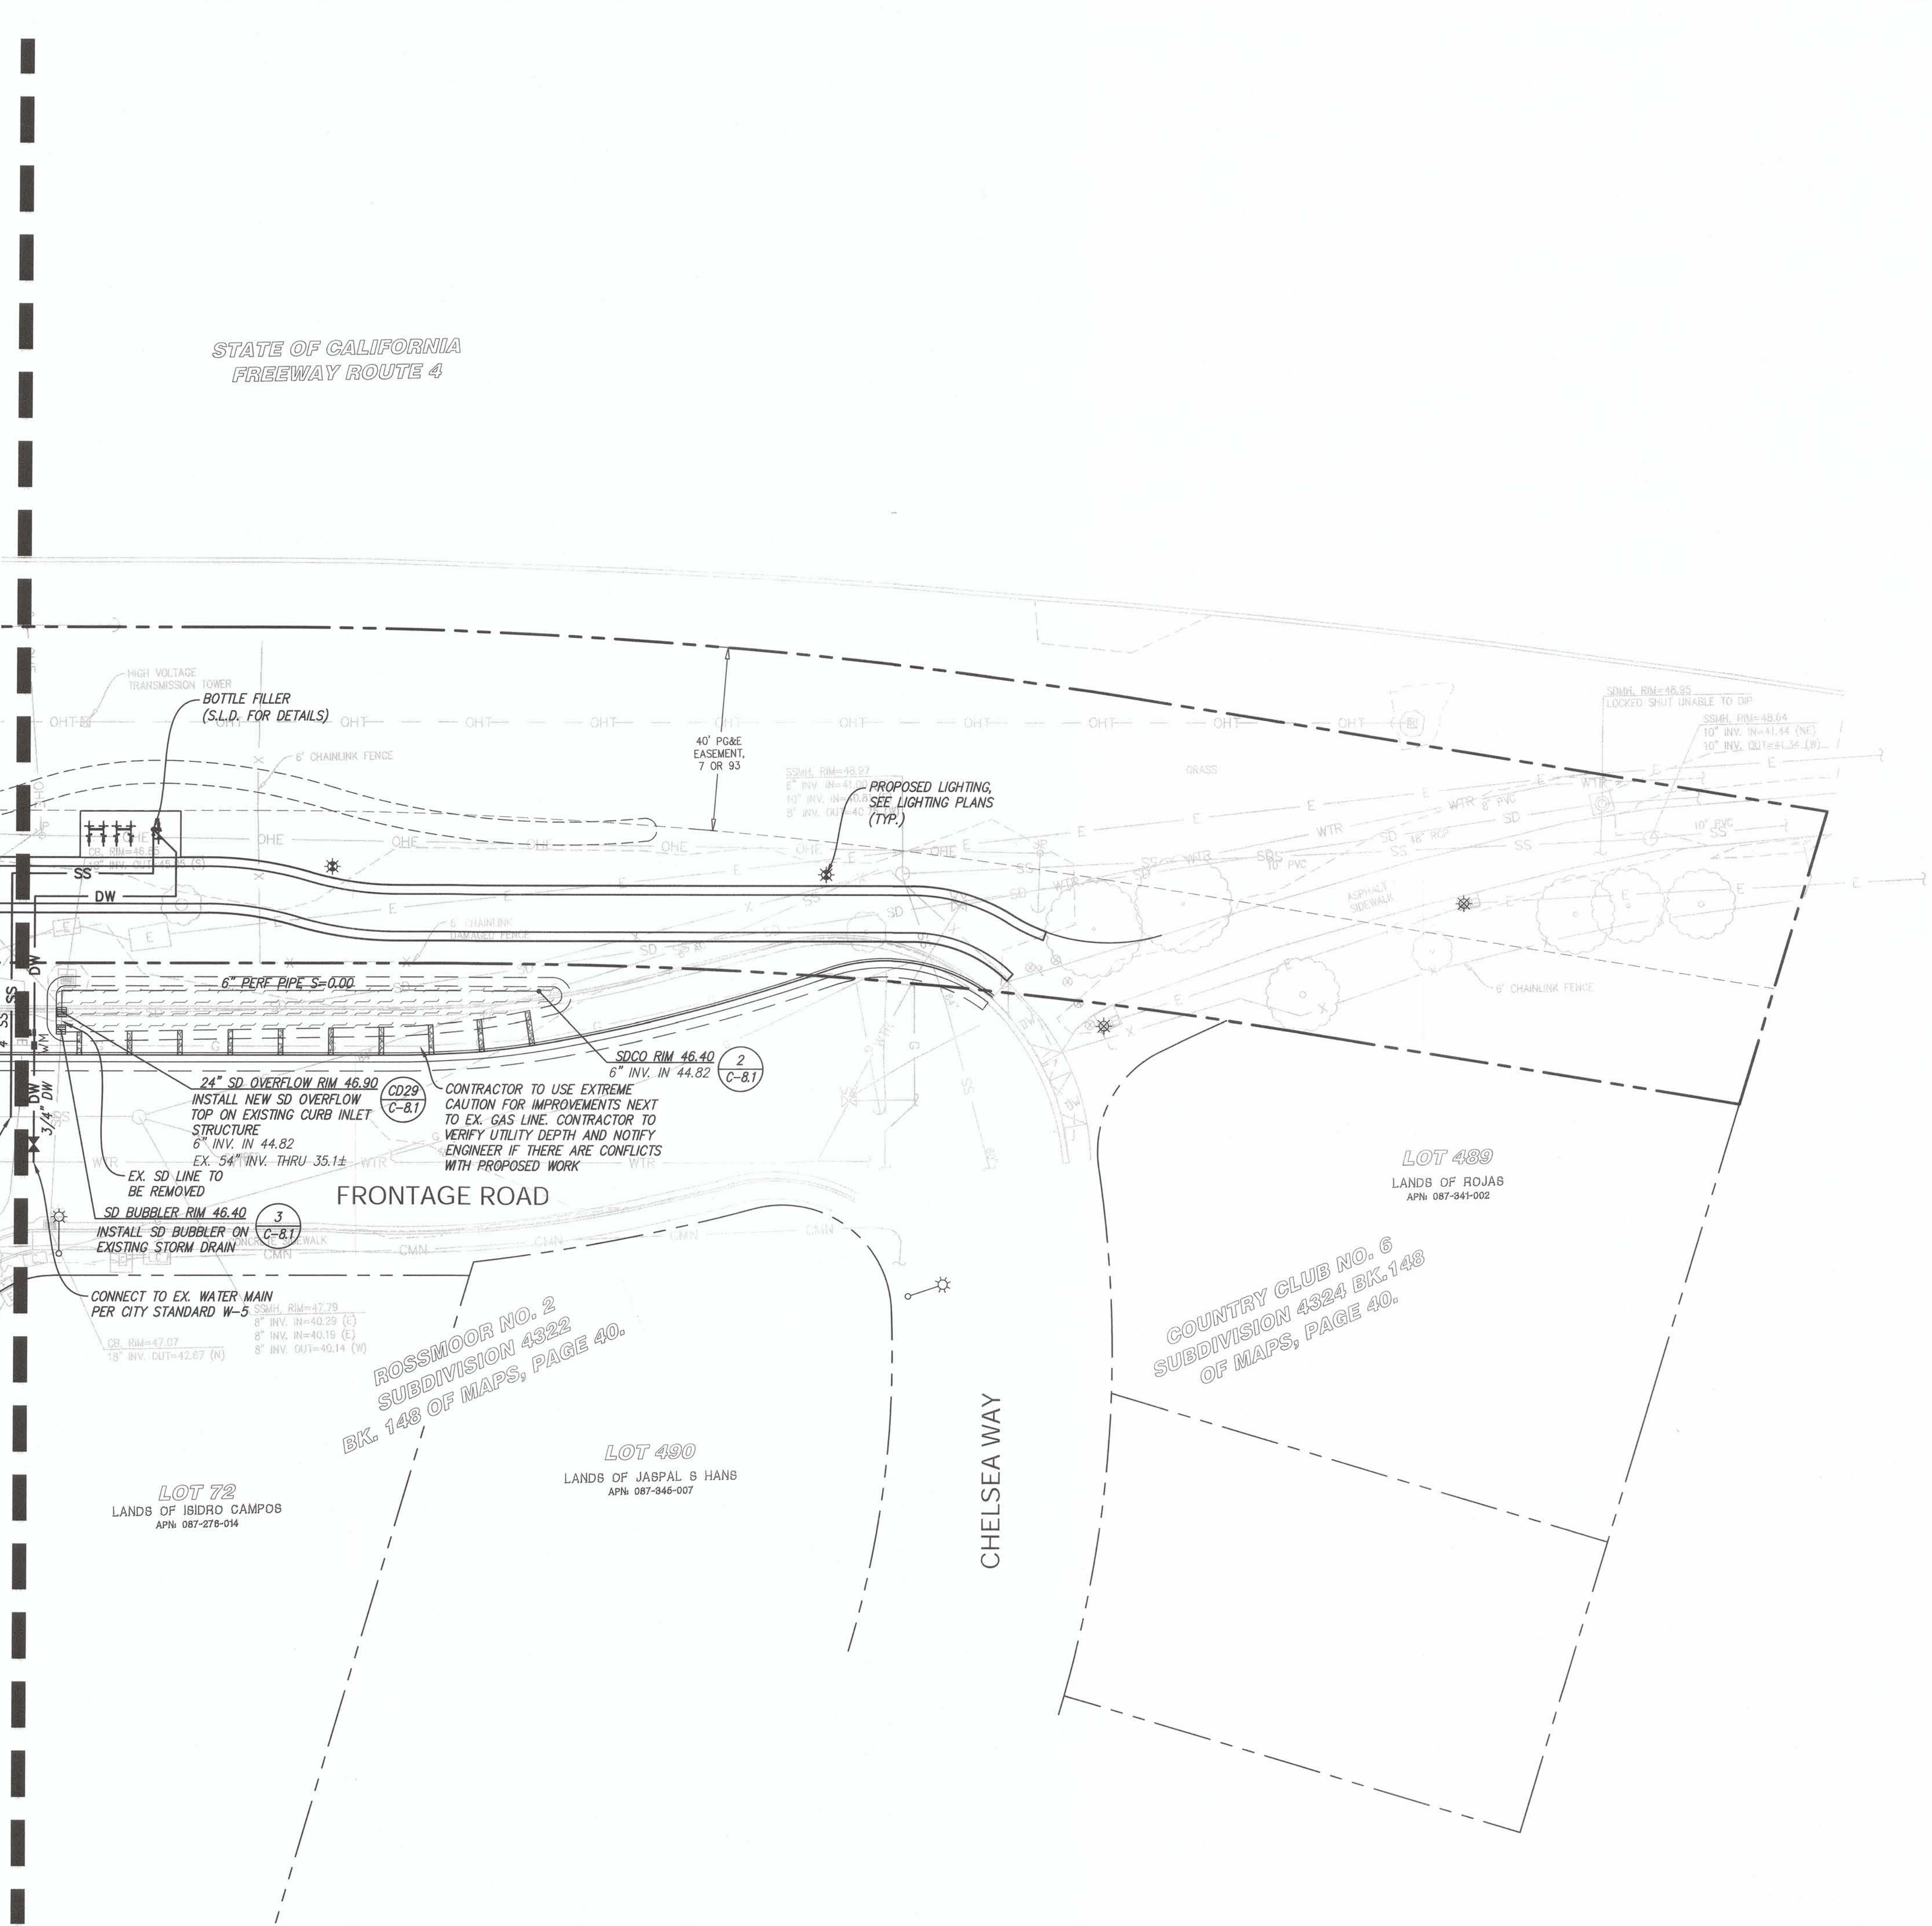
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MATCHLINE - SEE SHEET C-6.2





ROSSMOOR NO. 2
SUBDIVISION 4322
BK. 148 OF MAPS, PAGE 40.

COUNTRY CLUB NO. 6
SUBDIVISION 4324 BK. 148
OF MAPS, PAGE 40.

LOT 72
LANDS OF ISIDRO CAMPOS
APN 087-276-014

LOT 490
LANDS OF JABPAL S HANG
APN 087-846-007

LOT 489
LANDS OF ROJAS
APN 087-841-002

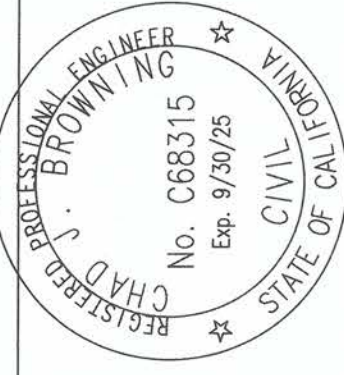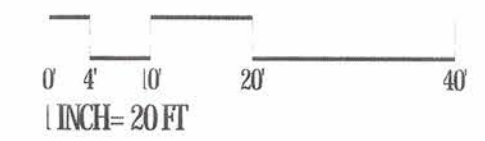

PREPARED UNDER THE DIRECTION OF:
Chad L. Browning
CHAD L. BROWNING
R.C.E. NO. 68315
EXPIRES 9-30-25

ACCEPTED FOR USE:
John Samuelson
JOHN SAMUELSON
City Engineer
Date: 9/18/23










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DRAWN: CW	CHECKED: SC	REVIEWED: CB	DATE: 09/05/23	SCALE: AS NOTED
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SHEET NO.
17 OF 59
DWG. NO.
C-6.3

STORMWATER MANAGEMENT PLAN LEGEND


-  PROPOSED PERVIOUS AREA
-  PROPOSED IMPERVIOUS AREA
-  EXISTING IMPERVIOUS AREA DIRECTED TO STORMWATER TREATMENT
-  BIO-RETENTION AREA
-  DRAINAGE AREA BOUNDARY
-  FLOW LINE
-  FLOW DIRECTION

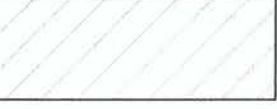STORMWATER MANAGEMENT NOTES:

1. THIS PLAN PRESENTS METHODS AND CALCULATIONS FOR COMPLYING WITH THE REQUIREMENTS OF PROVISION C.3 OF THE MUNICIPAL REGIONAL STORMWATER PERMIT IN ACCORDANCE WITH THE CONTRA COSTA COUNTY PROGRAM AND THE C.3 REQUIREMENTS.
2. THE FOLLOWING TREATMENT MEASURES ARE PROPOSED TO REGULATE THE QUALITY OF STORM WATER LEAVING THE SITE.
 - 2.1. SELF-TREATING AREA - RUNOFF IN THIS AREA ORIGINATES IN AND FLOWS THROUGH PLANTING PRIOR TO EXITING THE PROJECT SITE, NO TREATMENT IS REQUIRED
 - 2.2. BIO-RETENTION AREA - RUNOFF IN THIS AREA IS DIRECTED TO A BIO-RETENTION PLANTER/AREA FOR FILTRATION, INFILTRATION AND EVAPOTRANSPIRATION PRIOR TO EXISTING THE SITE. PLANTING AND SOIL REQUIREMENTS APPLY, SEE DETAIL.

Table A: Flow-Based Treatment Measure Sizing

Drainage Area	TOTAL AREA		IMPERVIOUS AREA		EX. IMPERVIOUS AREA		PERVIOUS AREA		Percent Impervious	Runoff Coefficient, c	Intensity, i (Uniform Intensity)	Q (cfs)	Treatment Area Required	Treatment Area provided
	sq. ft.	Ac.	sq. ft.	Ac.	sq. ft.	Ac.	sq. ft.	Ac.						
1	10,234	0.23	3,072	0.07	8,003	0.18	7,162	0.16	30.0%	0.480	0.2	0.02	123	443
2	17,822	0.41	5,592	0.13	8,408	0.19	12,230	0.28	31.4%	0.488	0.2	0.04	224	560
3	15,931	0.37	4,424	0.10	12,601	0.29	11,507	0.26	27.8%	0.467	0.2	0.03	177	681
4	17,313	0.40	5,455	0.13	14,070	0.32	11,858	0.27	31.5%	0.489	0.2	0.04	218	781
5	11,745	0.27	3,992	0.09	19,733	0.45	7,753	0.18	34.0%	0.504	0.2	0.03	160	949

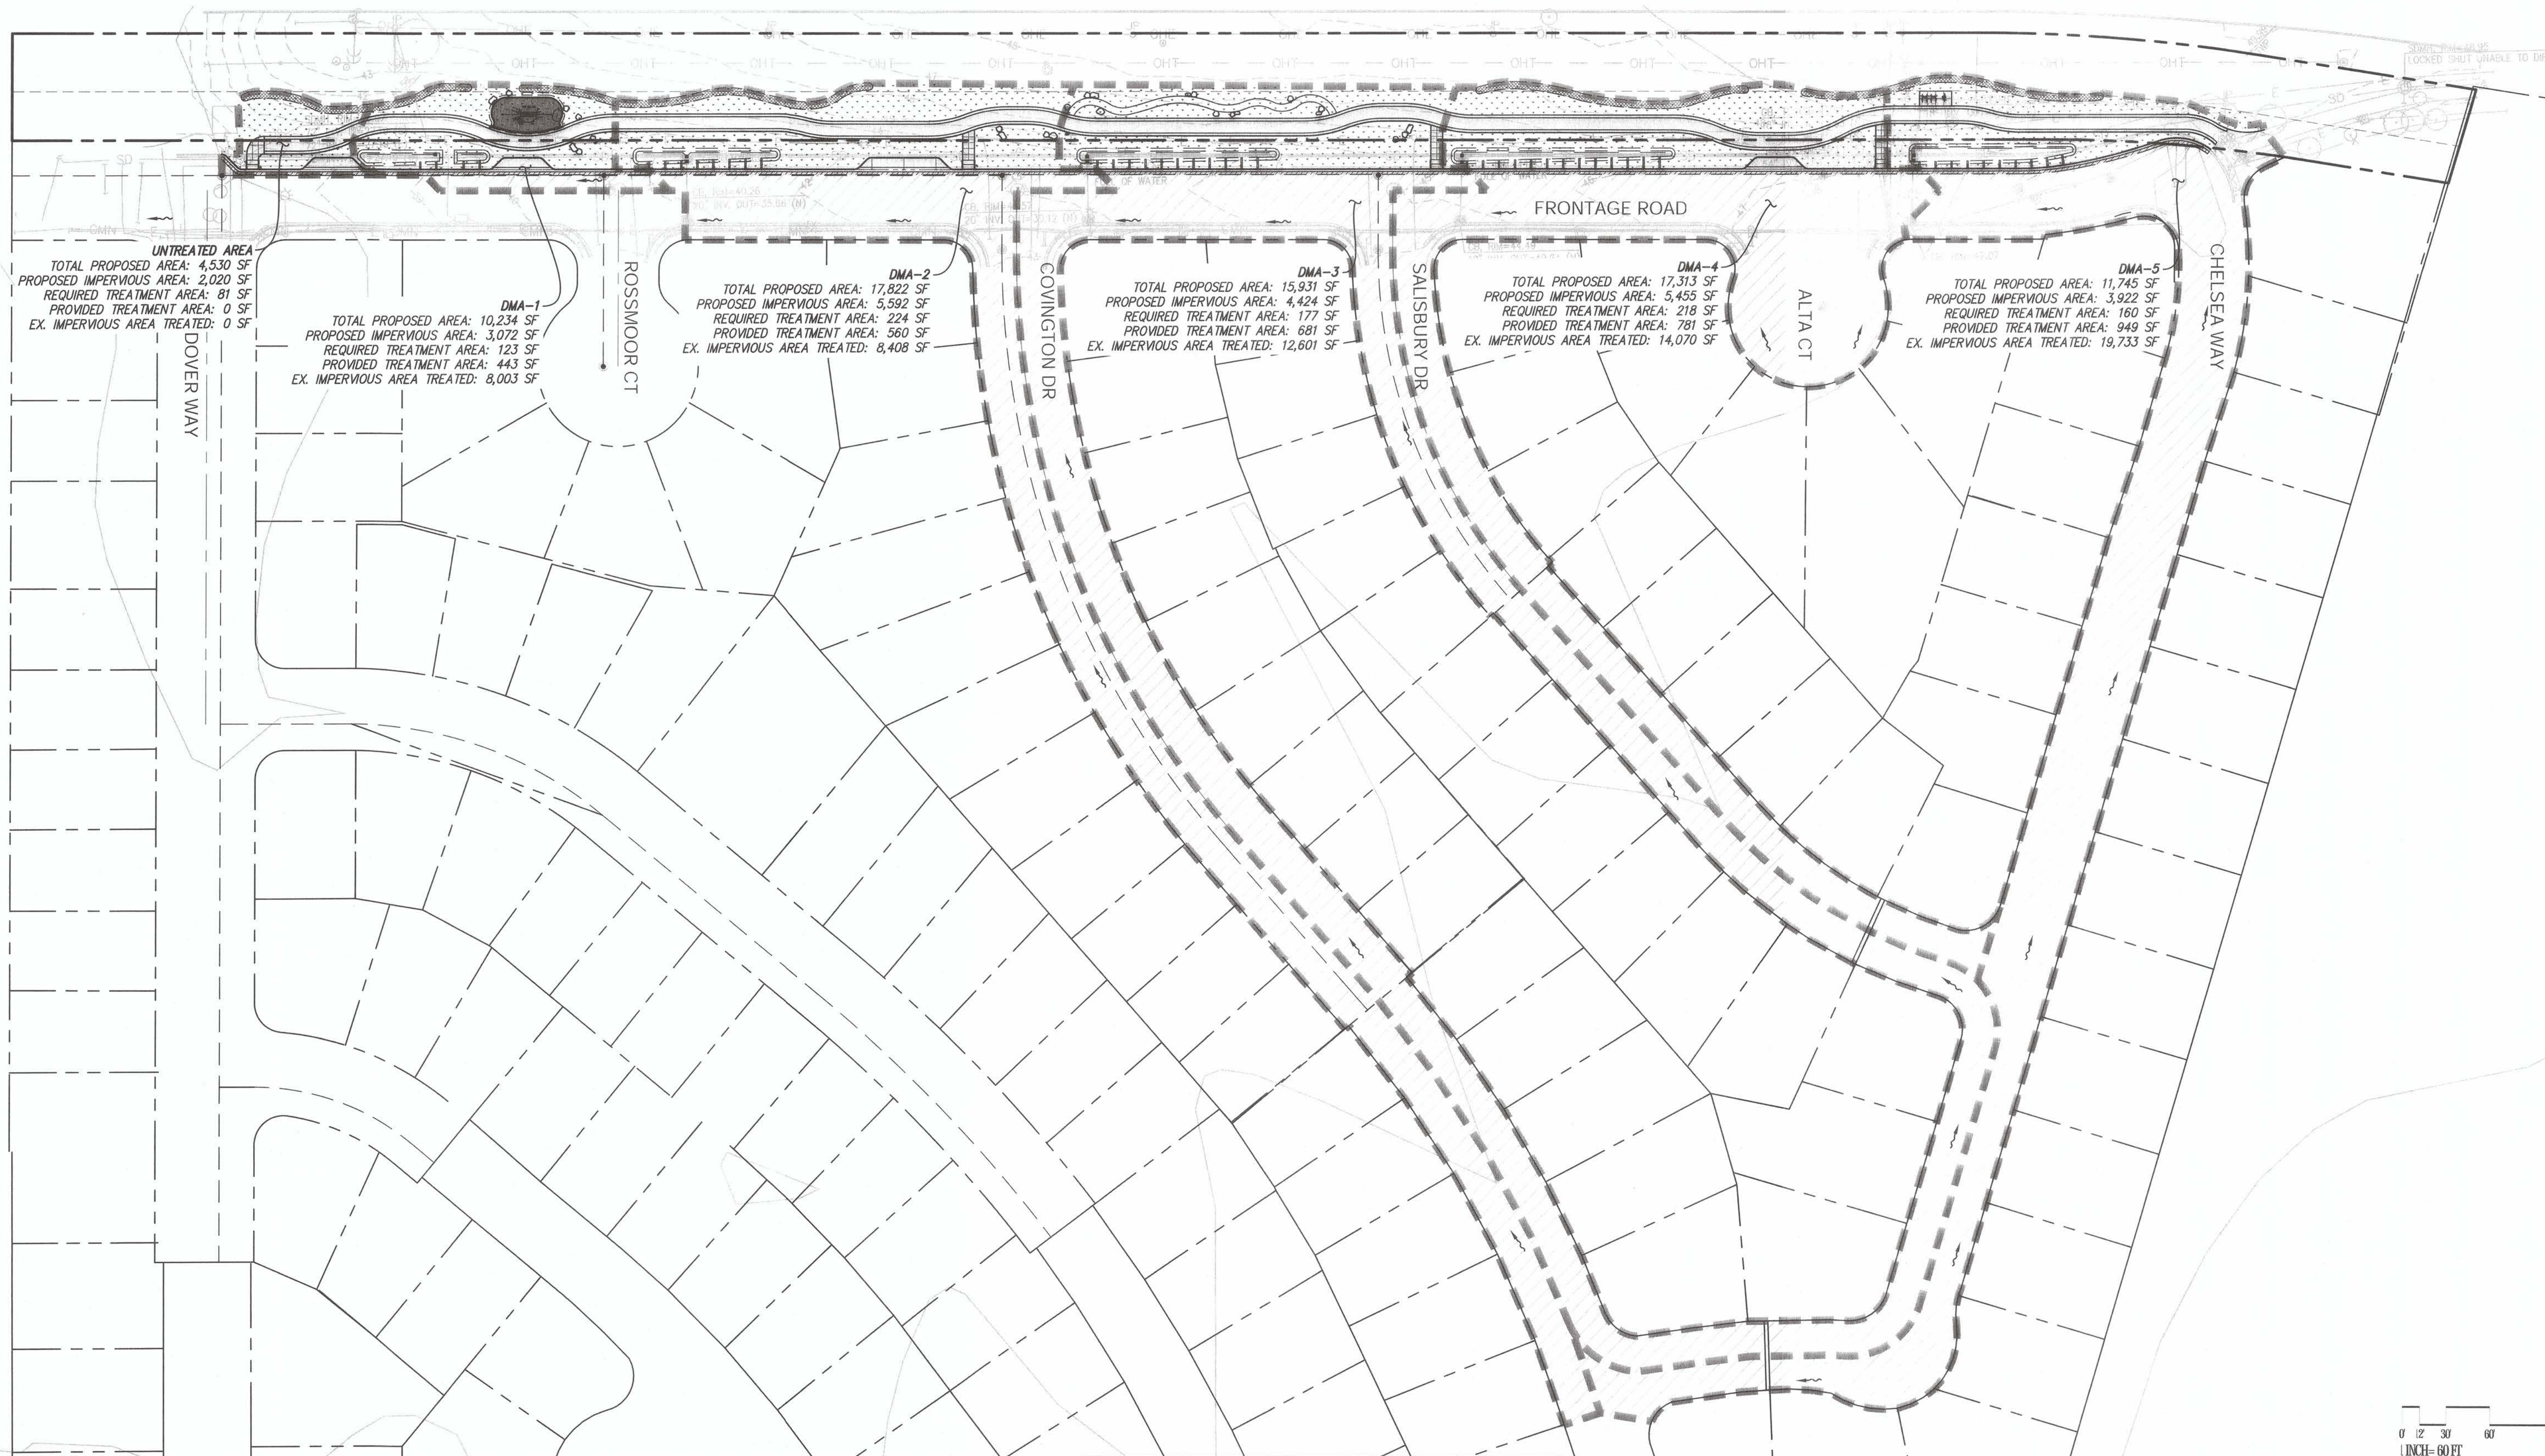

UNTREATED AREA
TOTAL PROPOSED AREA: 4,530 SF
PROPOSED IMPERVIOUS AREA: 2,020 SF
REQUIRED TREATMENT AREA: 81 SF
PROVIDED TREATMENT AREA: 0 SF
EX. IMPERVIOUS AREA TREATED: 0 SF


DMA-1
TOTAL PROPOSED AREA: 10,234 SF
PROPOSED IMPERVIOUS AREA: 3,072 SF
REQUIRED TREATMENT AREA: 123 SF
PROVIDED TREATMENT AREA: 443 SF
EX. IMPERVIOUS AREA TREATED: 8,003 SF

DMA-2
TOTAL PROPOSED AREA: 17,822 SF
PROPOSED IMPERVIOUS AREA: 5,592 SF
REQUIRED TREATMENT AREA: 224 SF
PROVIDED TREATMENT AREA: 560 SF
EX. IMPERVIOUS AREA TREATED: 8,408 SF

DMA-3
TOTAL PROPOSED AREA: 15,931 SF
PROPOSED IMPERVIOUS AREA: 4,424 SF
REQUIRED TREATMENT AREA: 177 SF
PROVIDED TREATMENT AREA: 681 SF
EX. IMPERVIOUS AREA TREATED: 12,601 SF

DMA-4
TOTAL PROPOSED AREA: 17,313 SF
PROPOSED IMPERVIOUS AREA: 5,455 SF
REQUIRED TREATMENT AREA: 218 SF
PROVIDED TREATMENT AREA: 781 SF
EX. IMPERVIOUS AREA TREATED: 14,070 SF

DMA-5
TOTAL PROPOSED AREA: 11,745 SF
PROPOSED IMPERVIOUS AREA: 3,992 SF
REQUIRED TREATMENT AREA: 160 SF
PROVIDED TREATMENT AREA: 949 SF
EX. IMPERVIOUS AREA TREATED: 19,733 SF

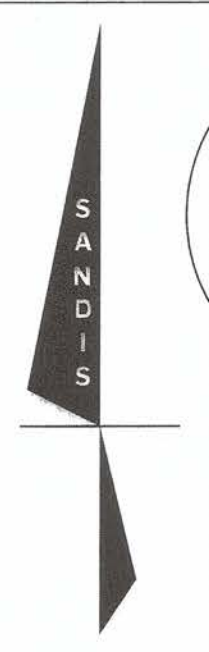

PREPARED UNDER THE DIRECTION OF:
Chad J. Browning
DATE: 9/20/23
CHAD J. BROWNING
R.C.E. NO. 68315
EXPIRES 9-30-25

ACCEPTED FOR USE:
John Samuelson
DATE: 9/16/23
JOHN SAMUELSON
City Engineer









FRONTAGE ROAD
LIVING GREEN TRAIL DESIGN
STORMWATER MANAGEMENT PLAN
CONTRACT NAME:
CONTRACT NUMBER:

BY	DRAWN: CW
	CHECKED: SC
	REVIEWED: CB
	DATE: 09/05/23
	SCALE: AS NOTED

DATE	REV	DESCRIPTION

SHEET NO.
18 OF 59
DWG. NO.
C-7.0

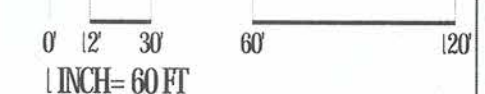

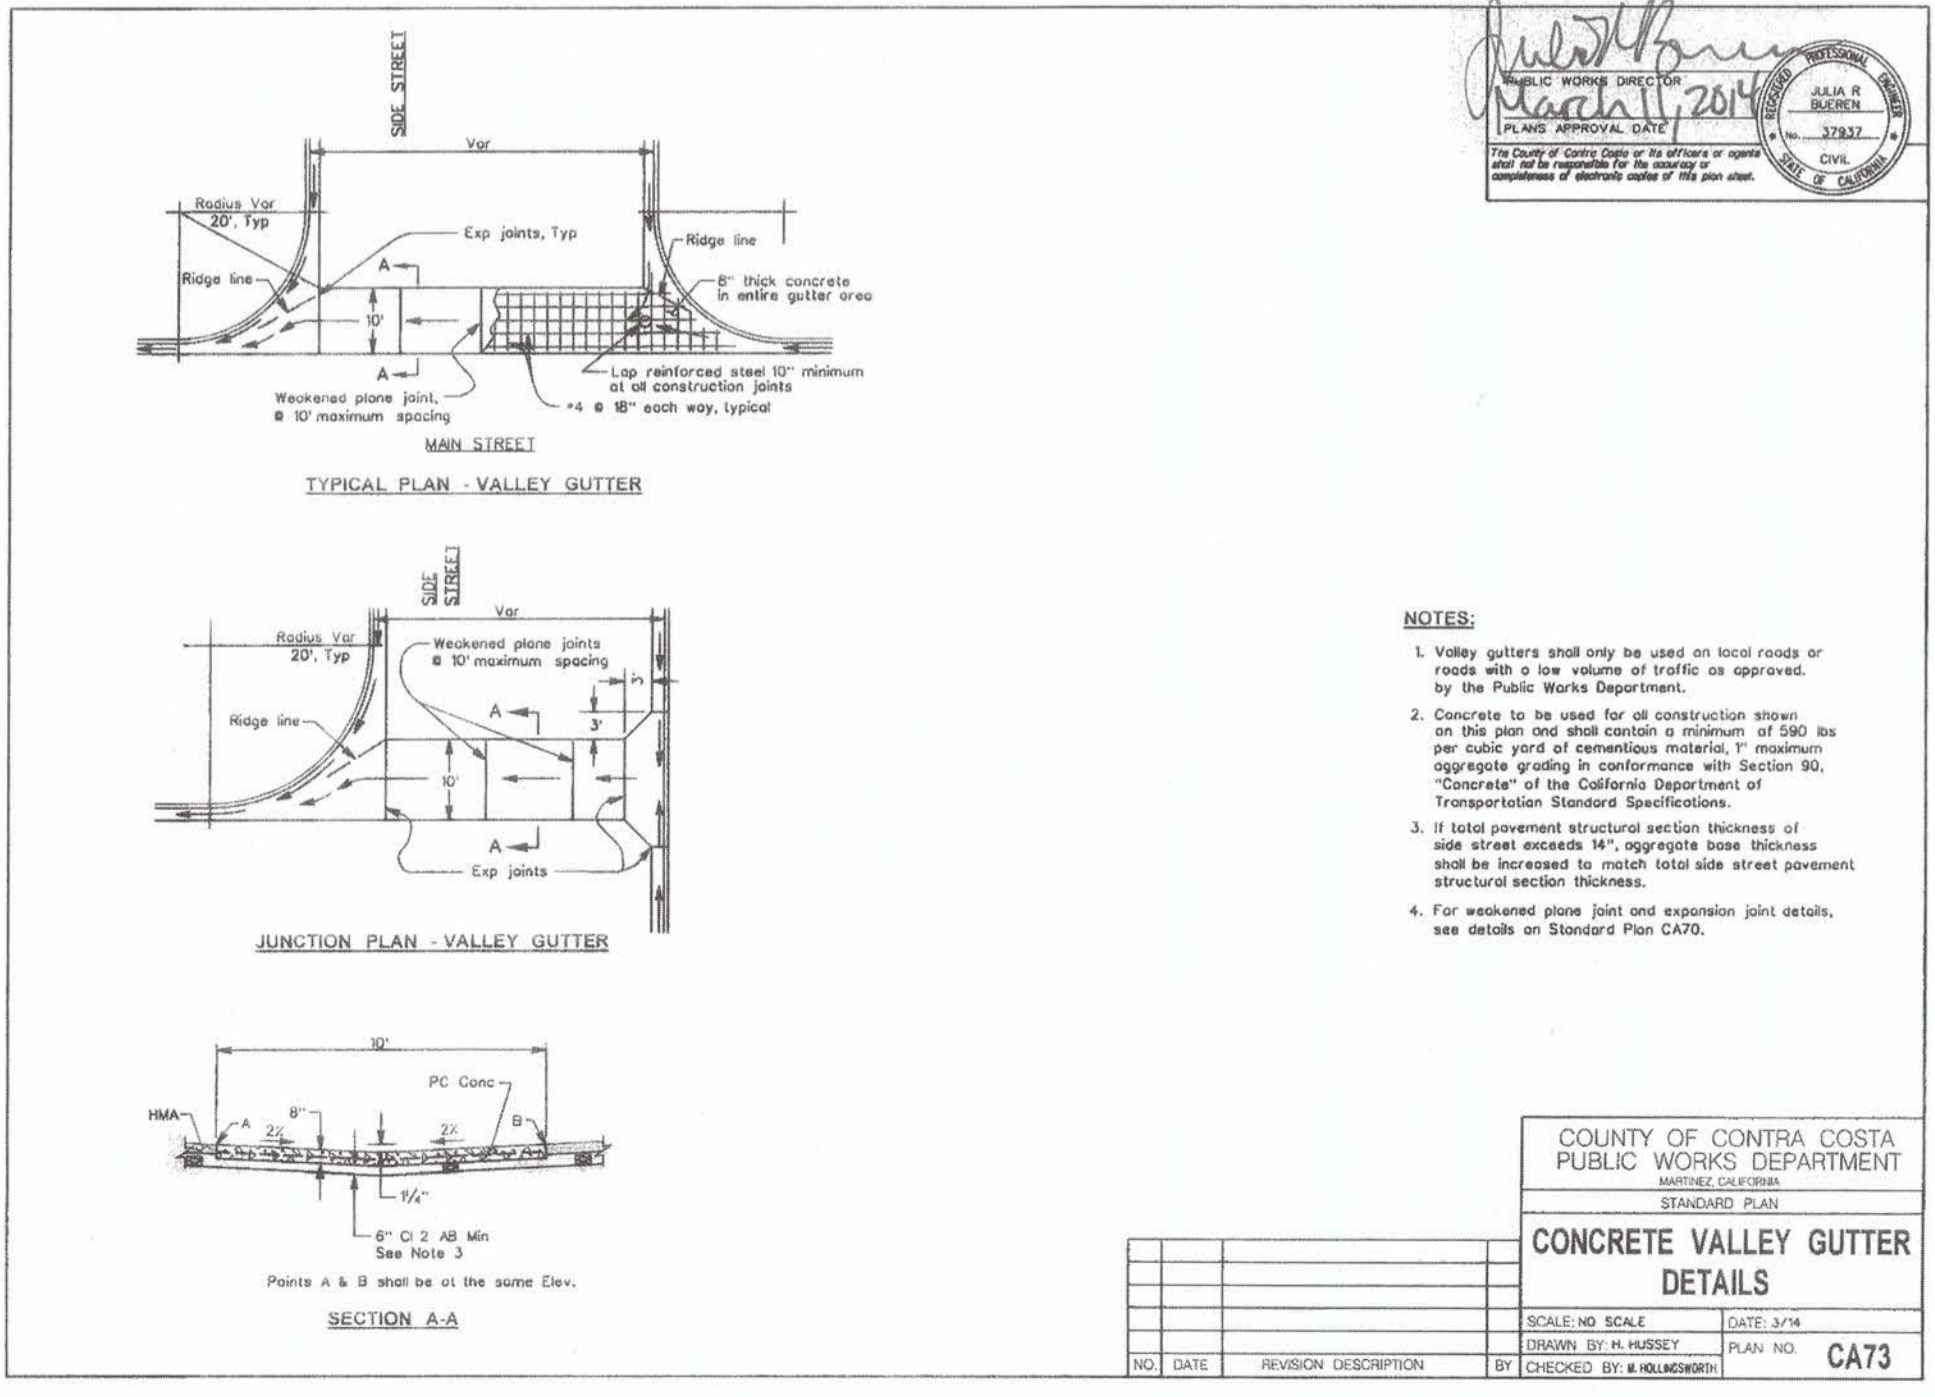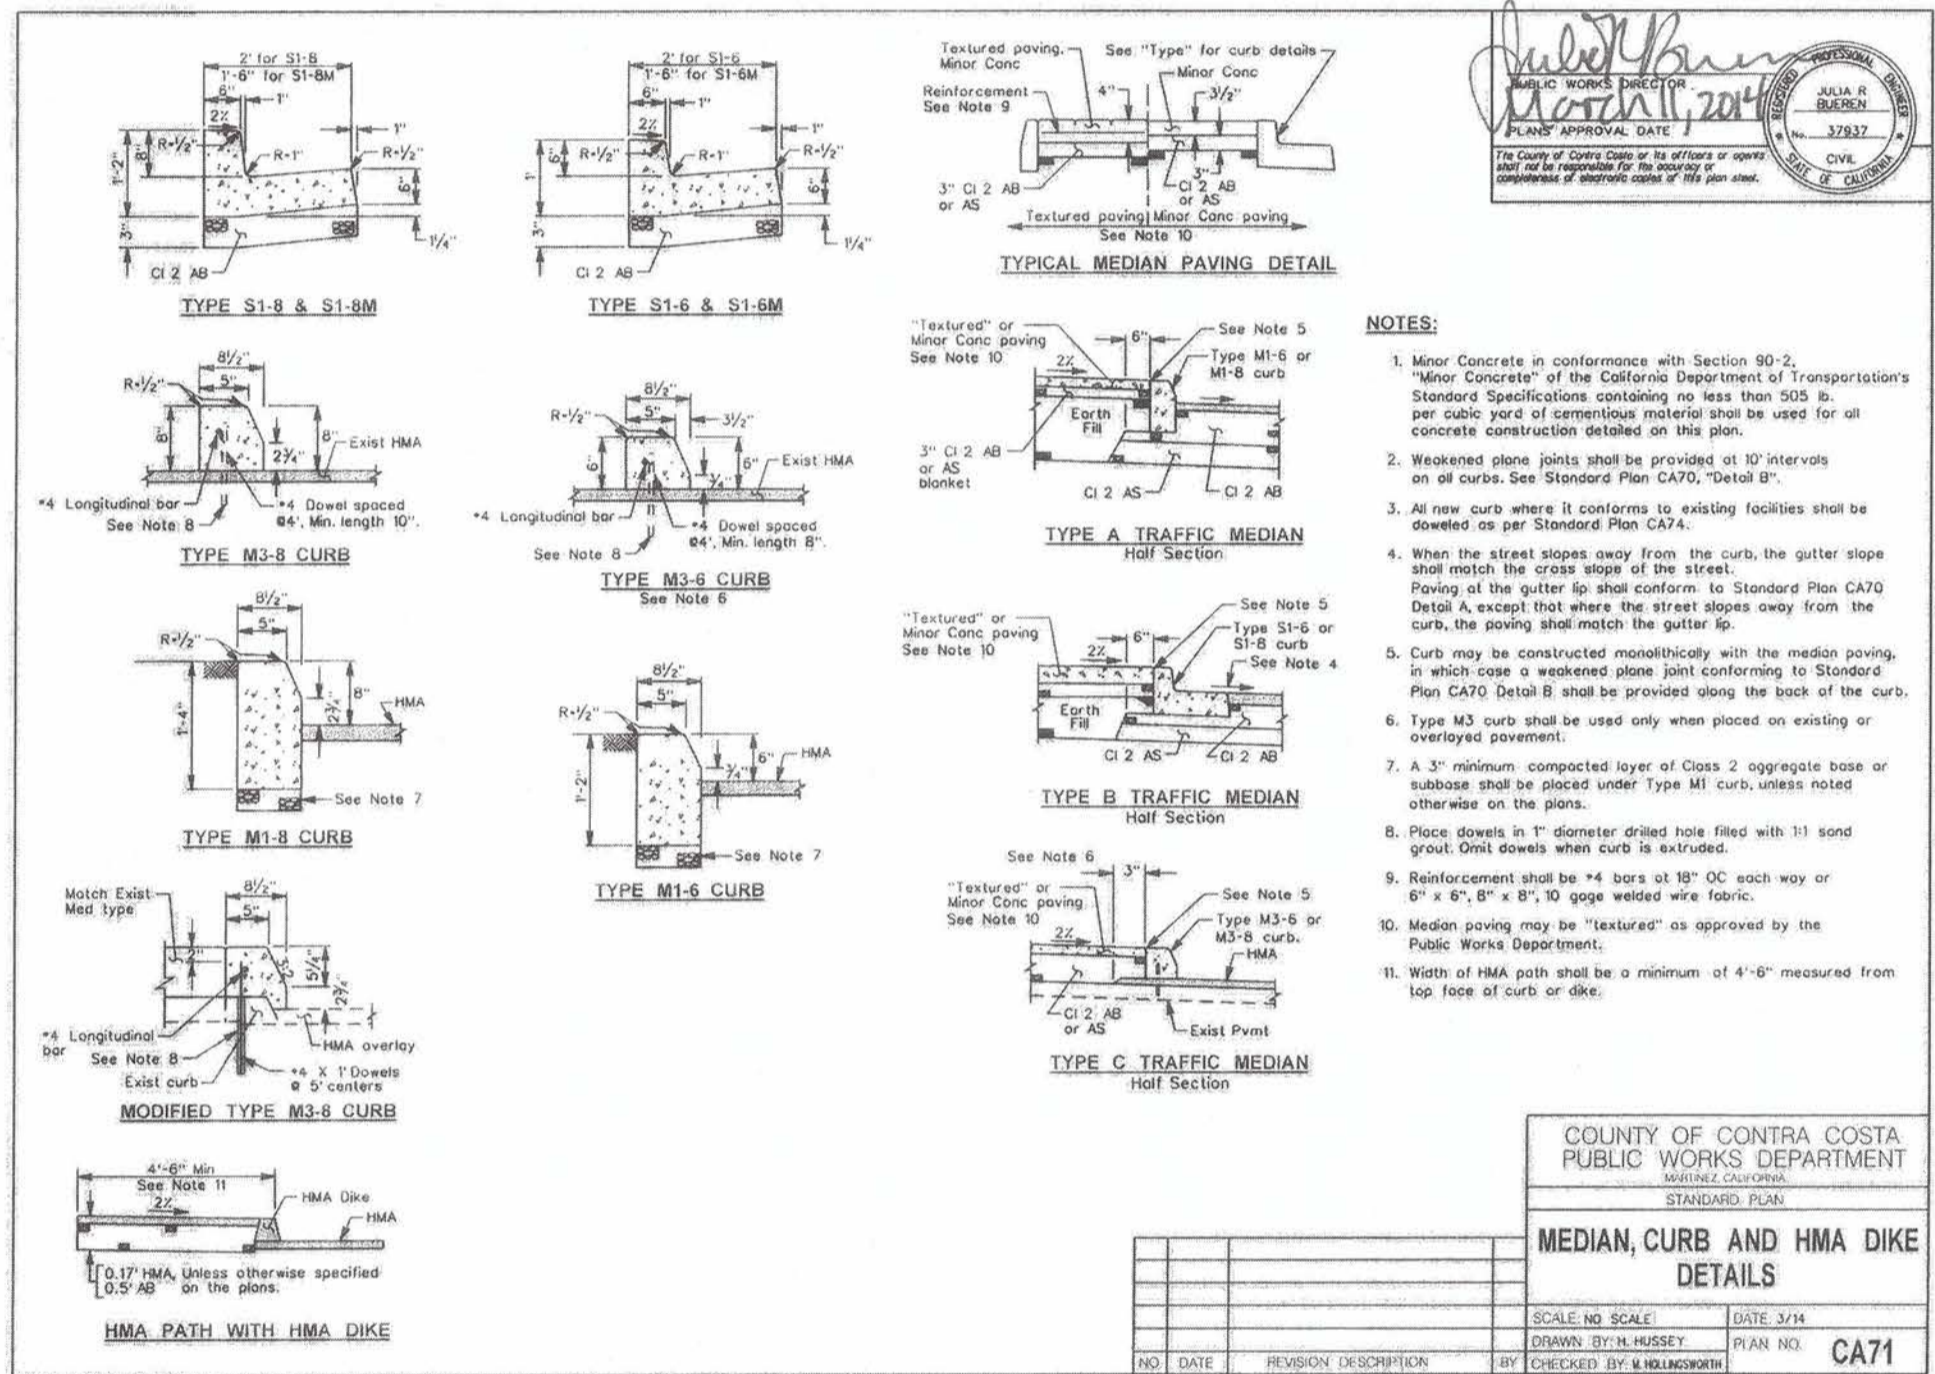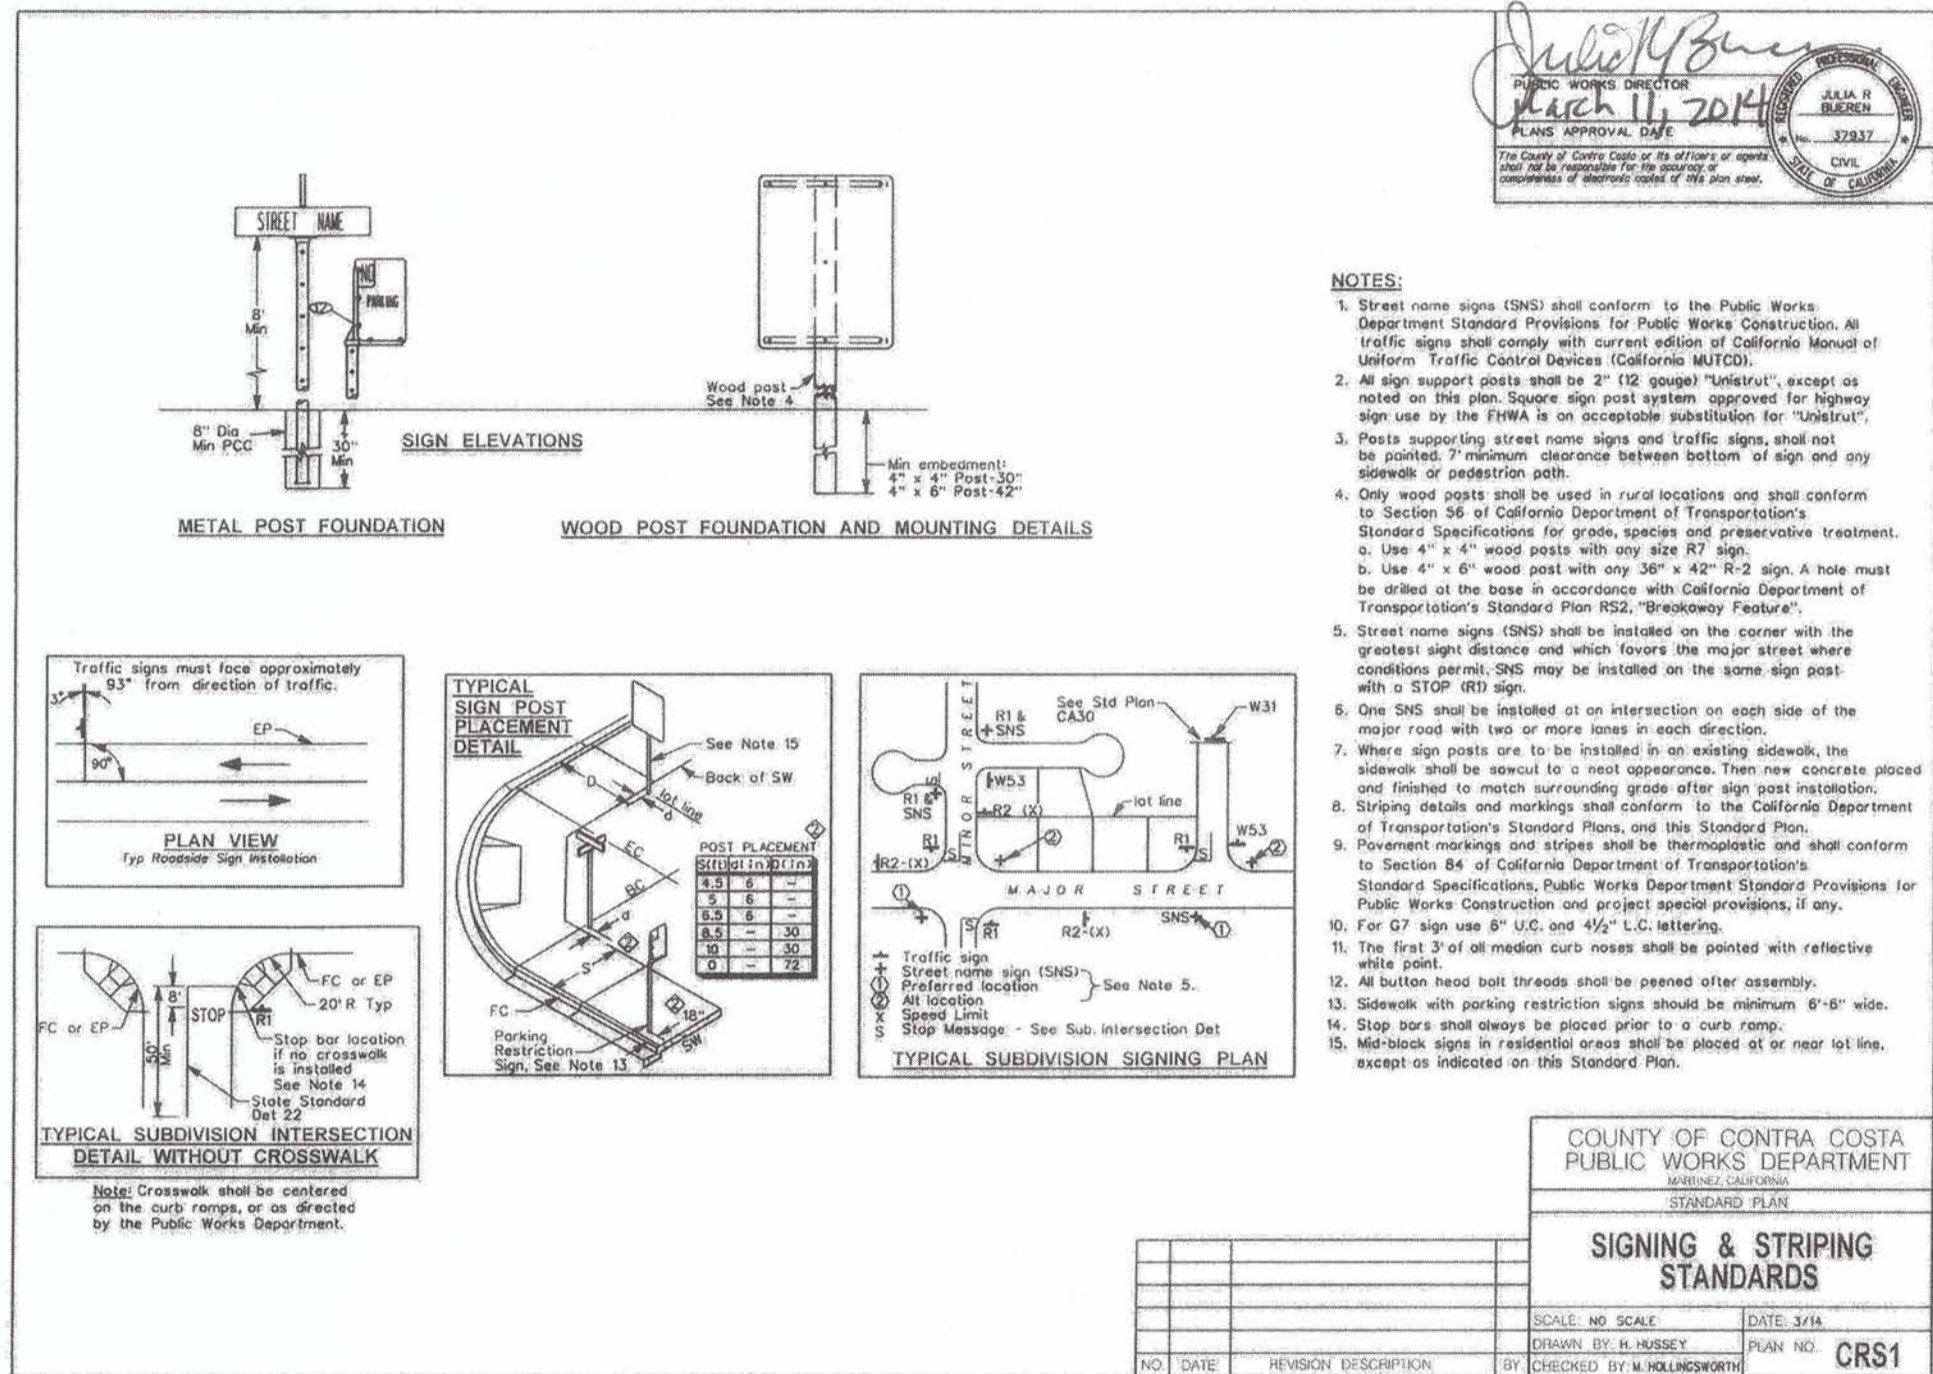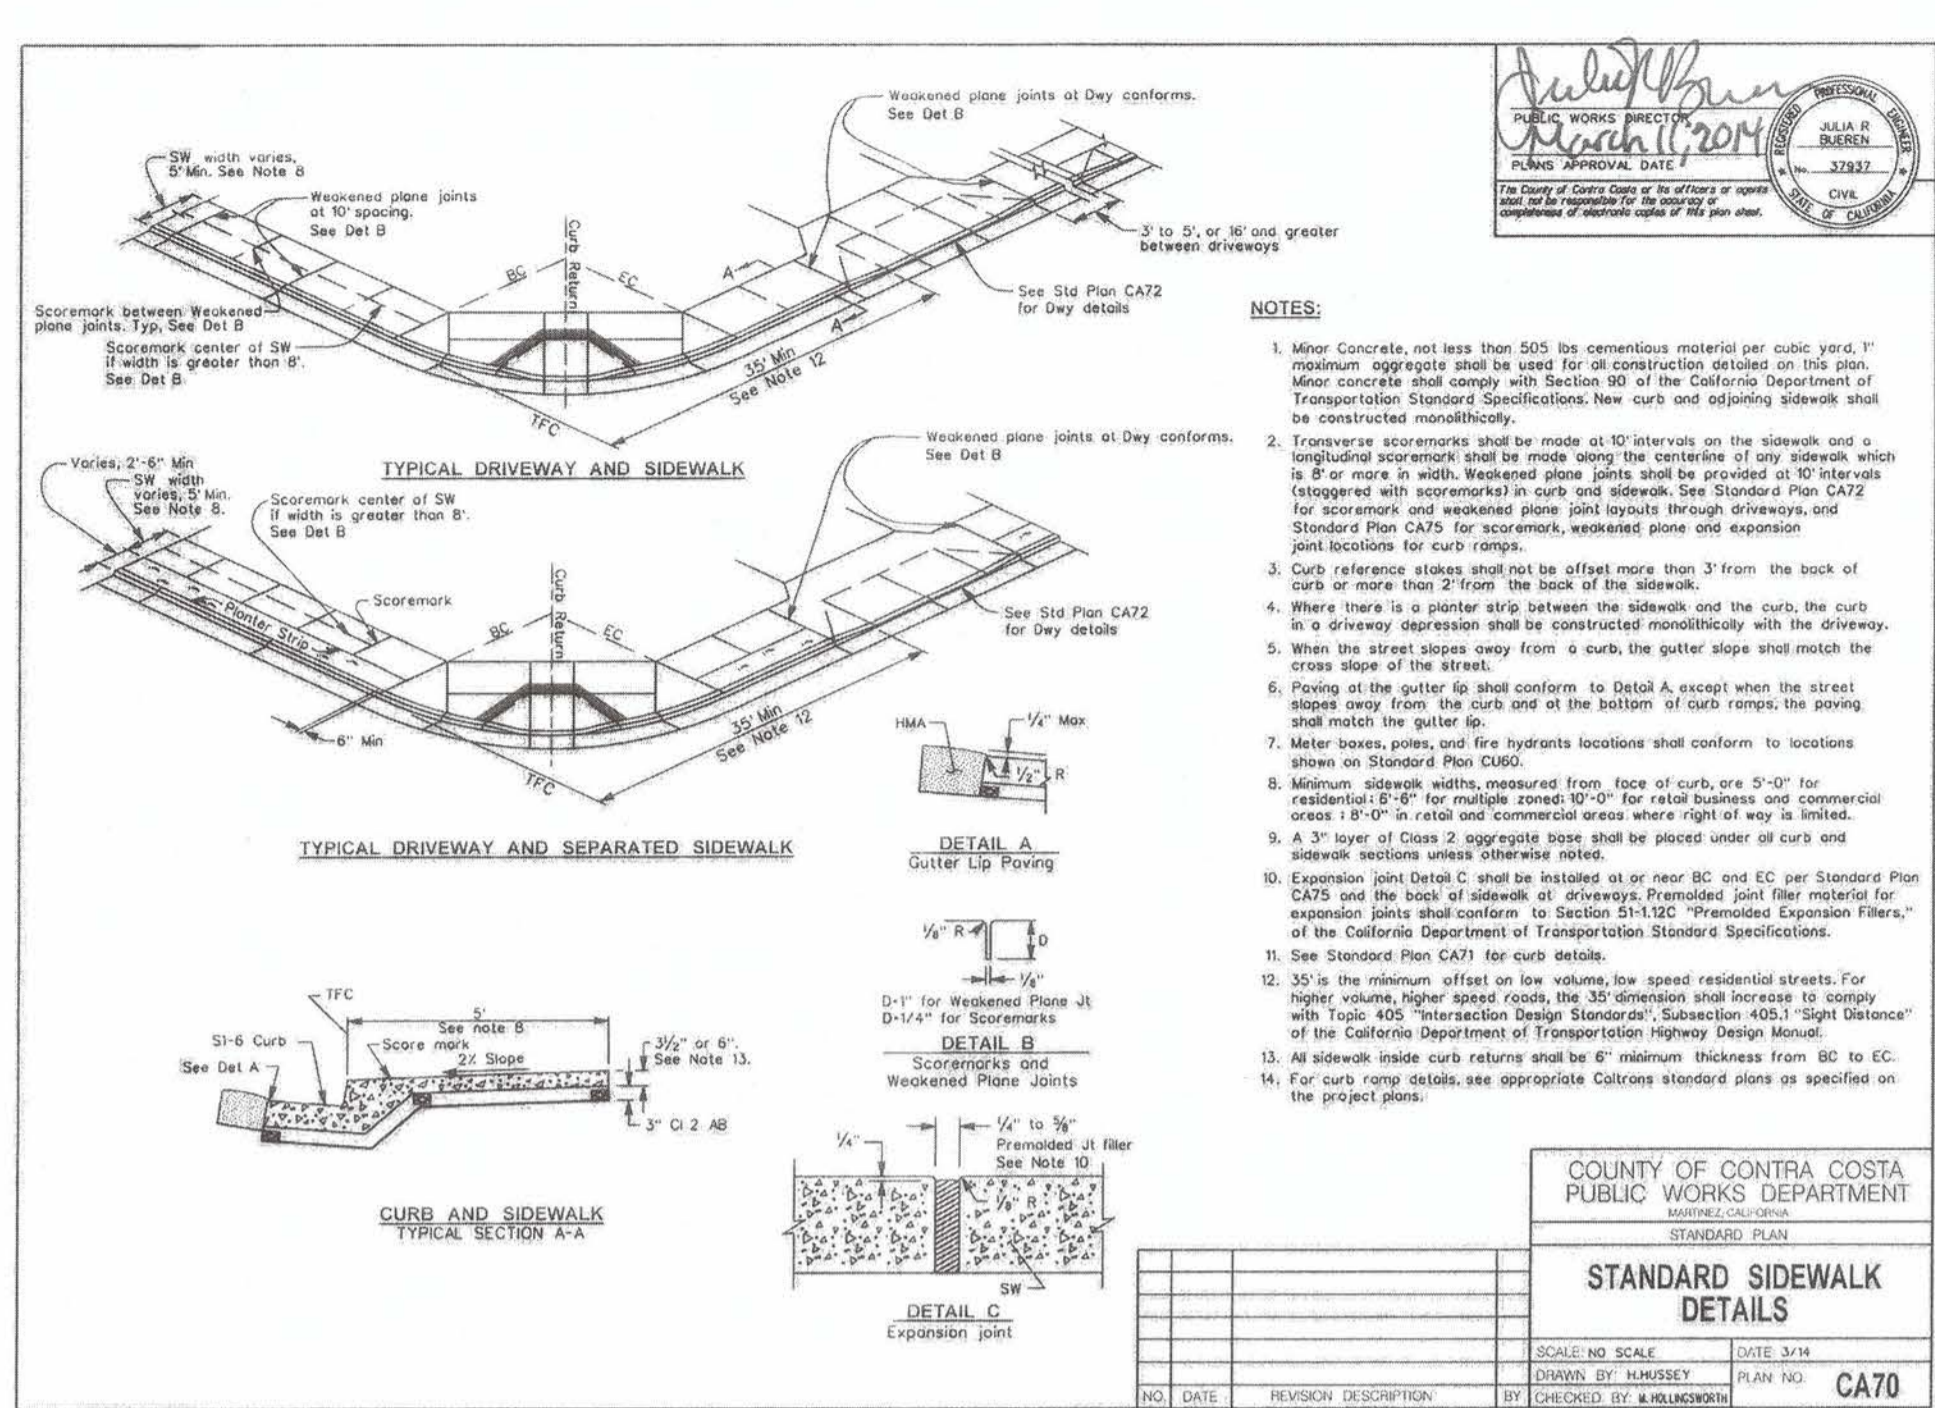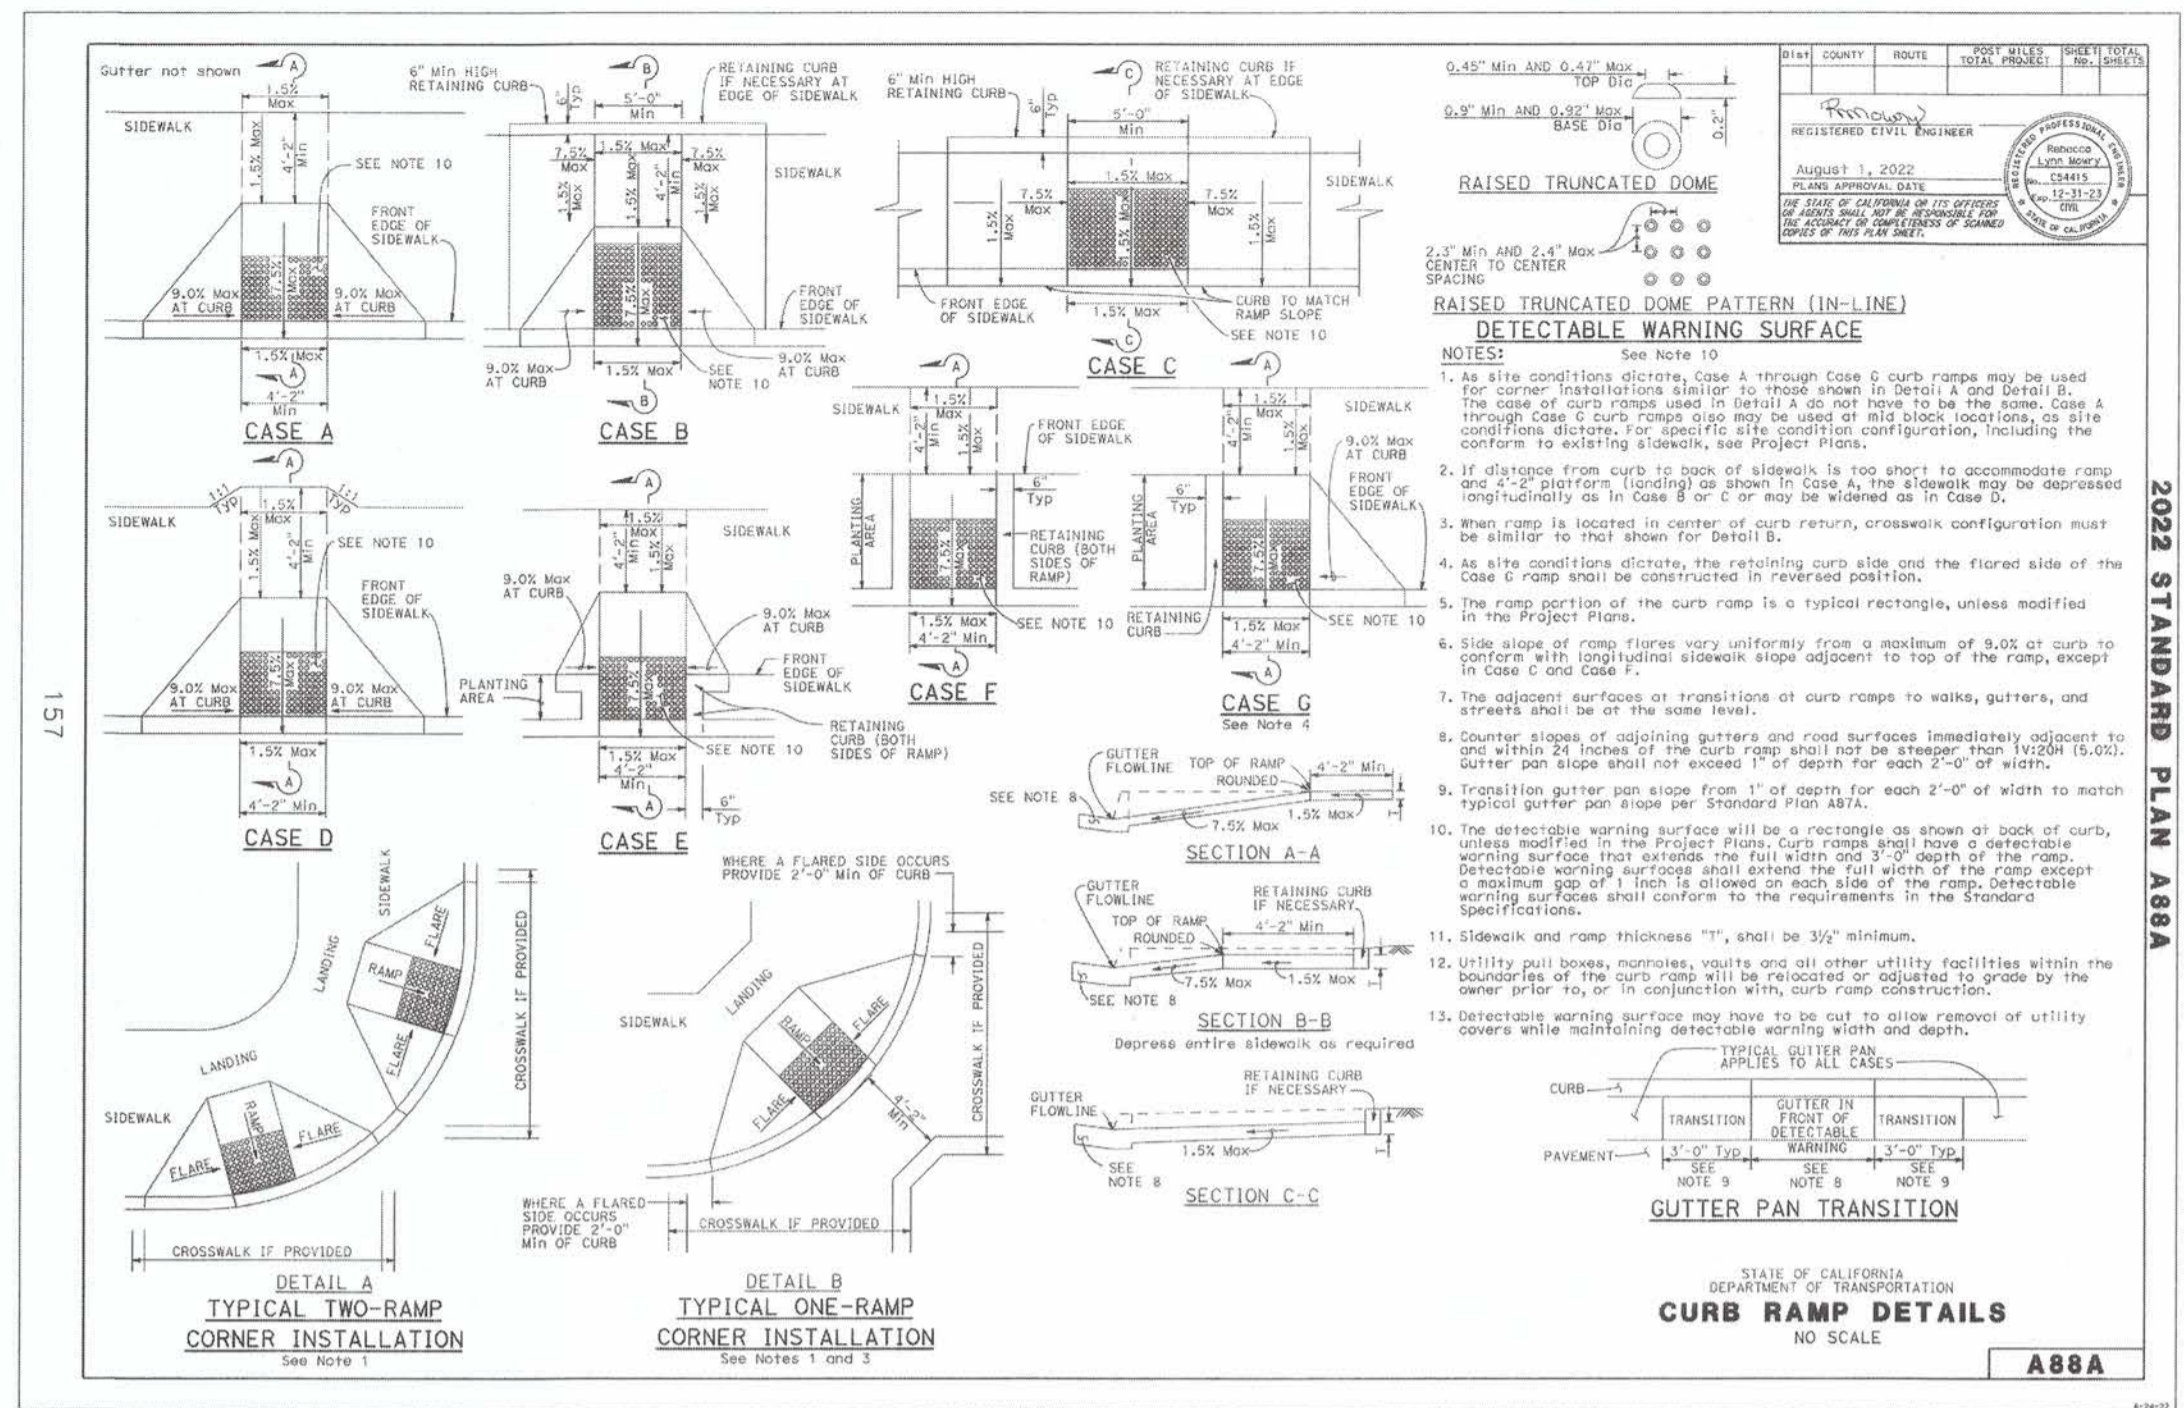

REGISTERED PROFESSIONAL ENGINEER
CHAD J. BROWNING
No. C68310
Exp. 9/30/25
CIVIL ENGINEER
STATE OF CALIFORNIA

PREPARED UNDER THE DIRECTION OF:
John Samuelson
City Engineer
DATE: 9/20/23
EXPIRES 9-30-25

ACCEPTED FOR USE:
John Samuelson
City Engineer
Date: 9/25/23

City of Pittsburg







FRONTAGE ROAD LIVING GREEN TRAIL DESIGN CONSTRUCTION DETAILS

CONTRACT NAME:
CONTRACT NUMBER:

BY: DRAWN: CW
CHECKED: SC
REVIEWED: CB
DATE: 09/05/23
SCALE: AS NOTED

DATE	REV	DESCRIPTION

SHEET NO. 19 OF 59
DWG. NO. C-80

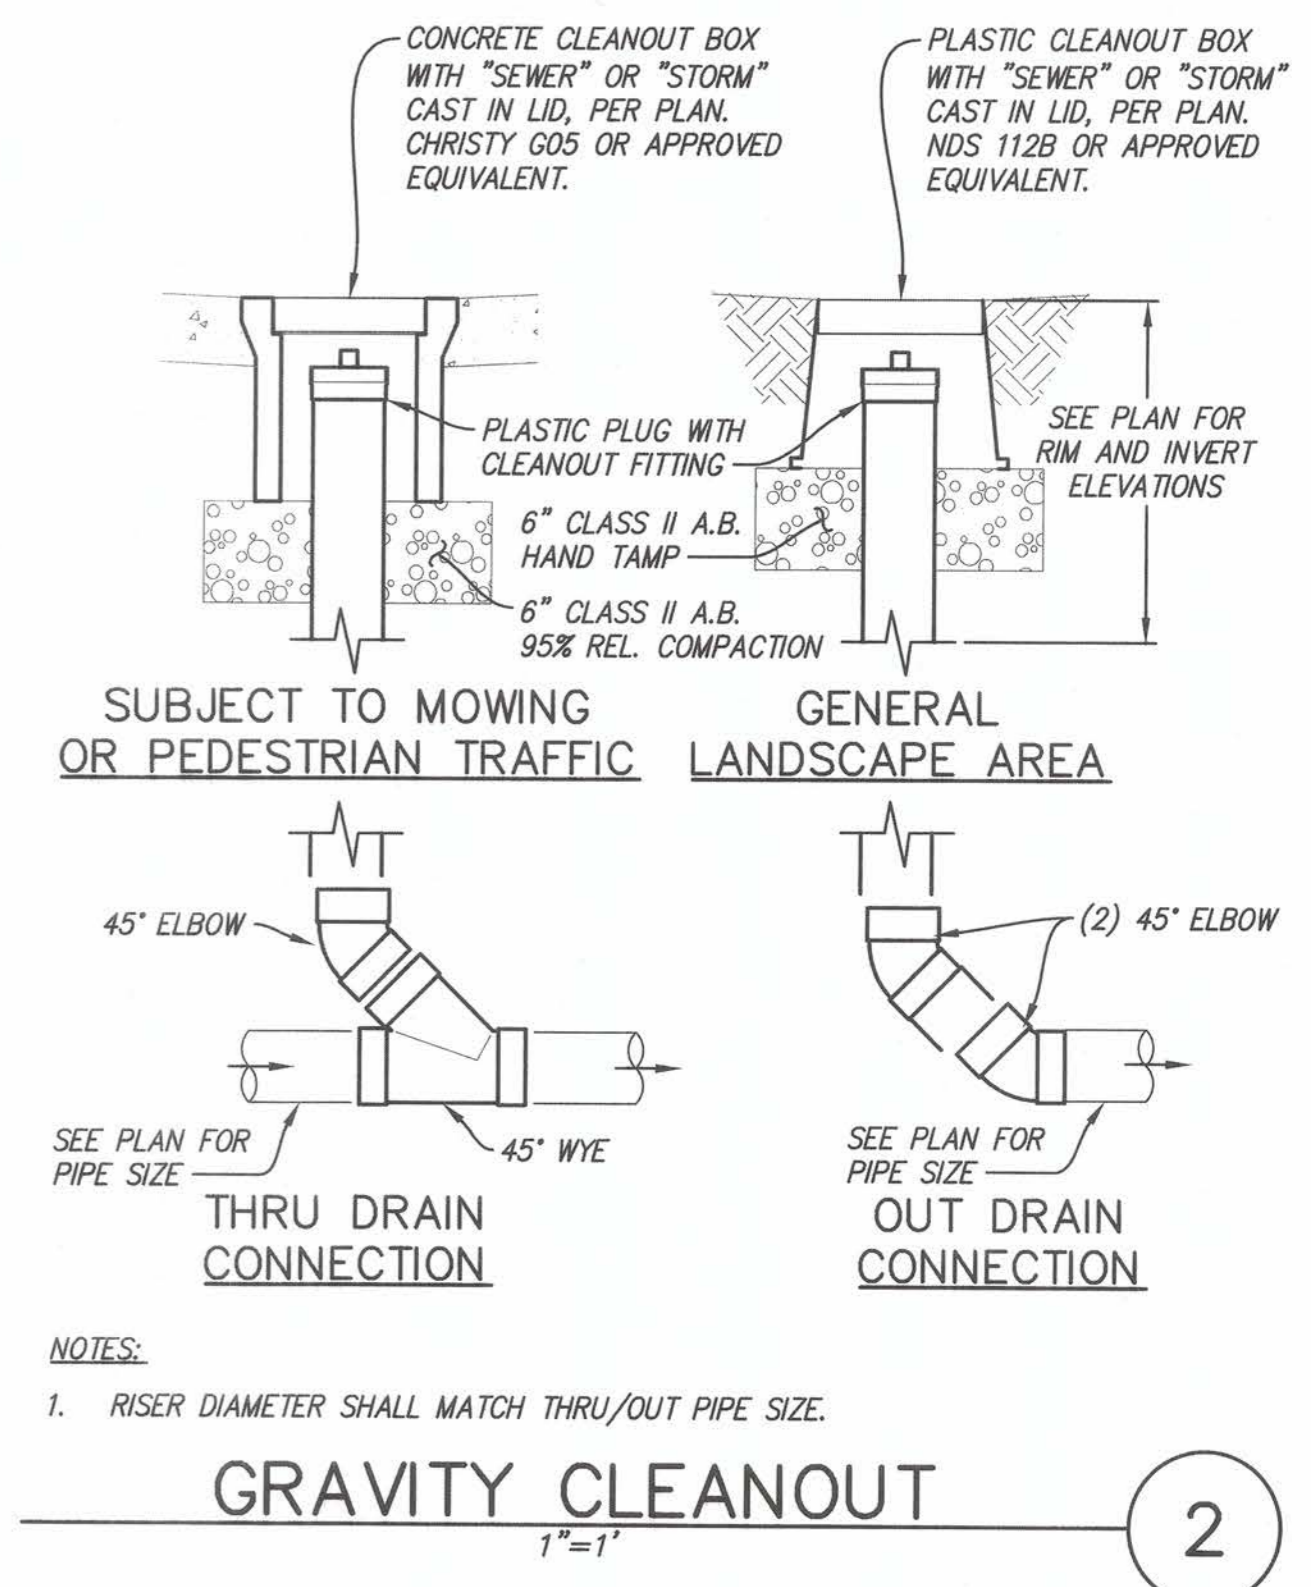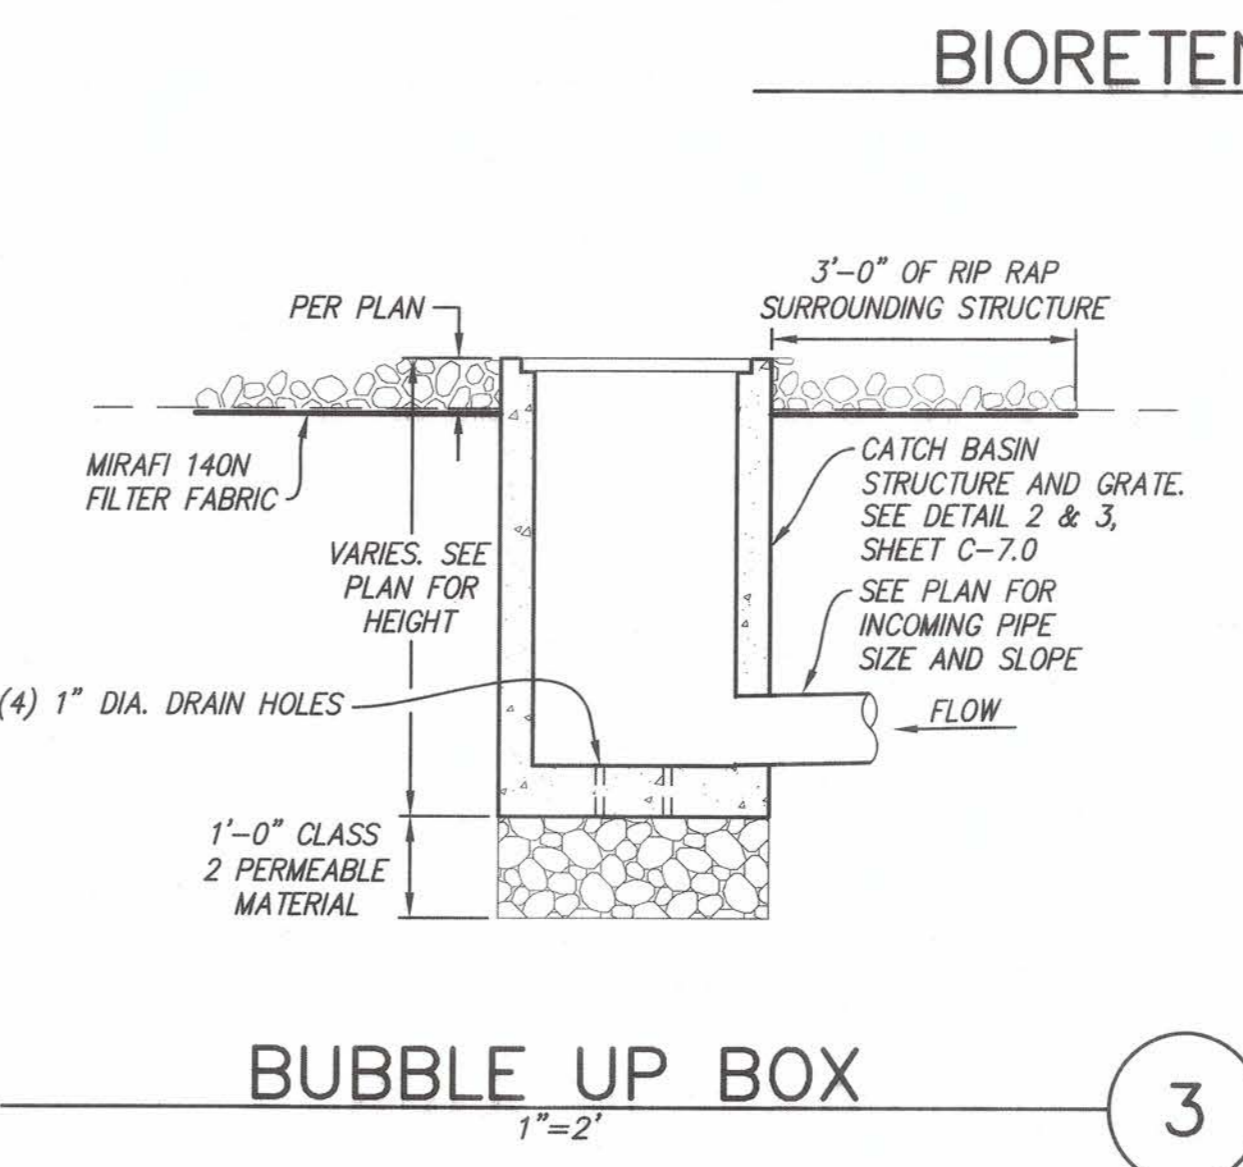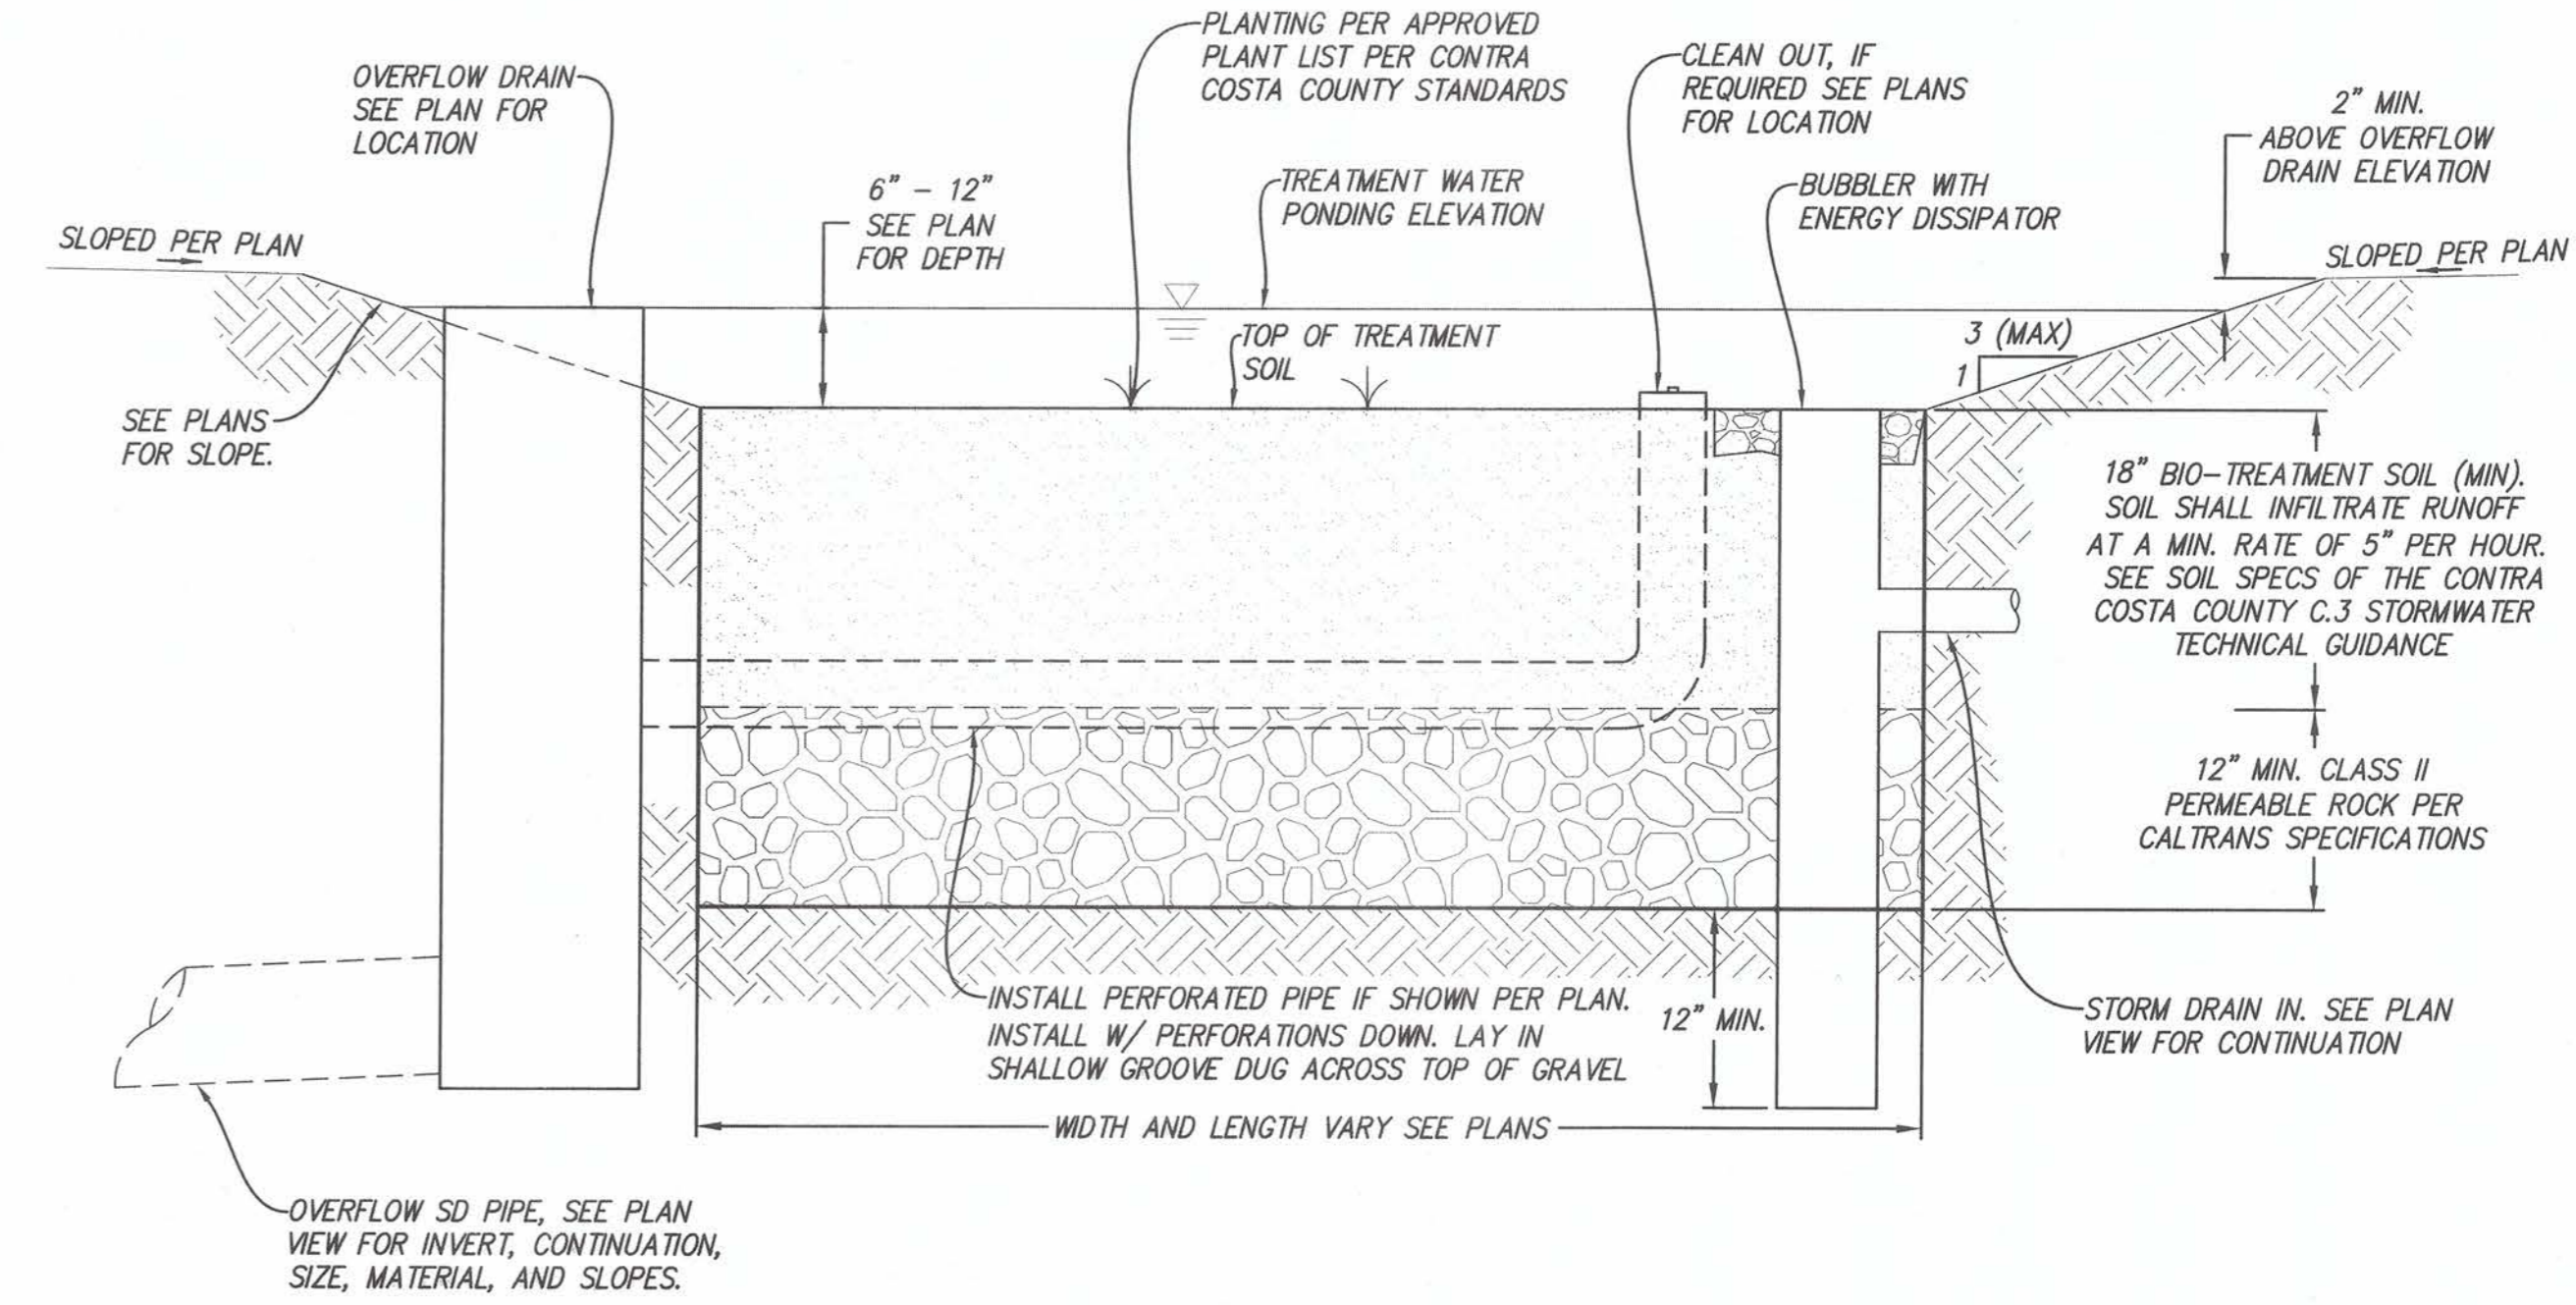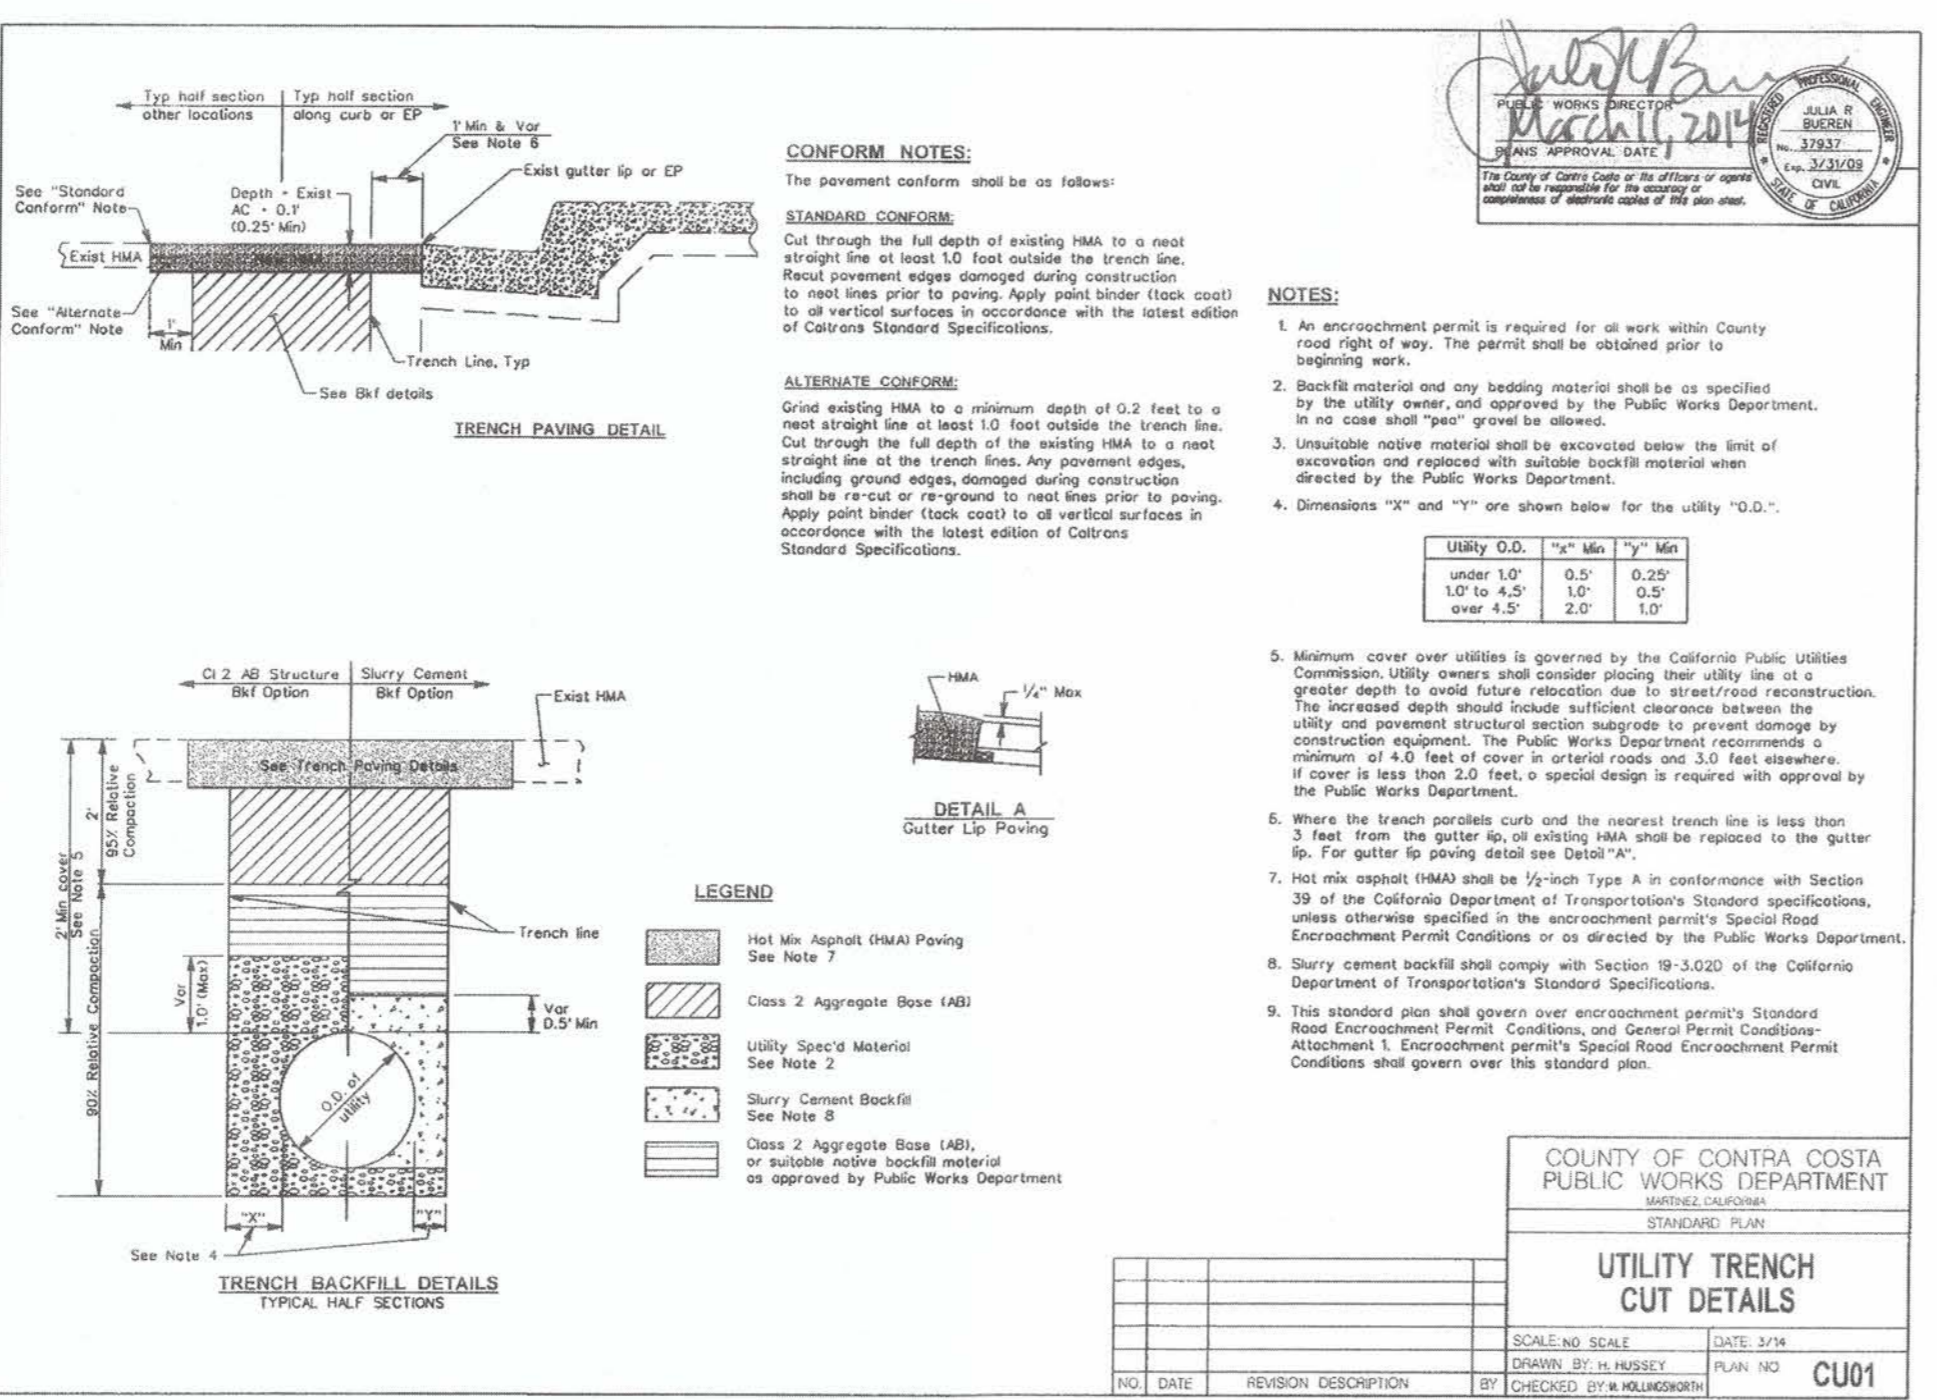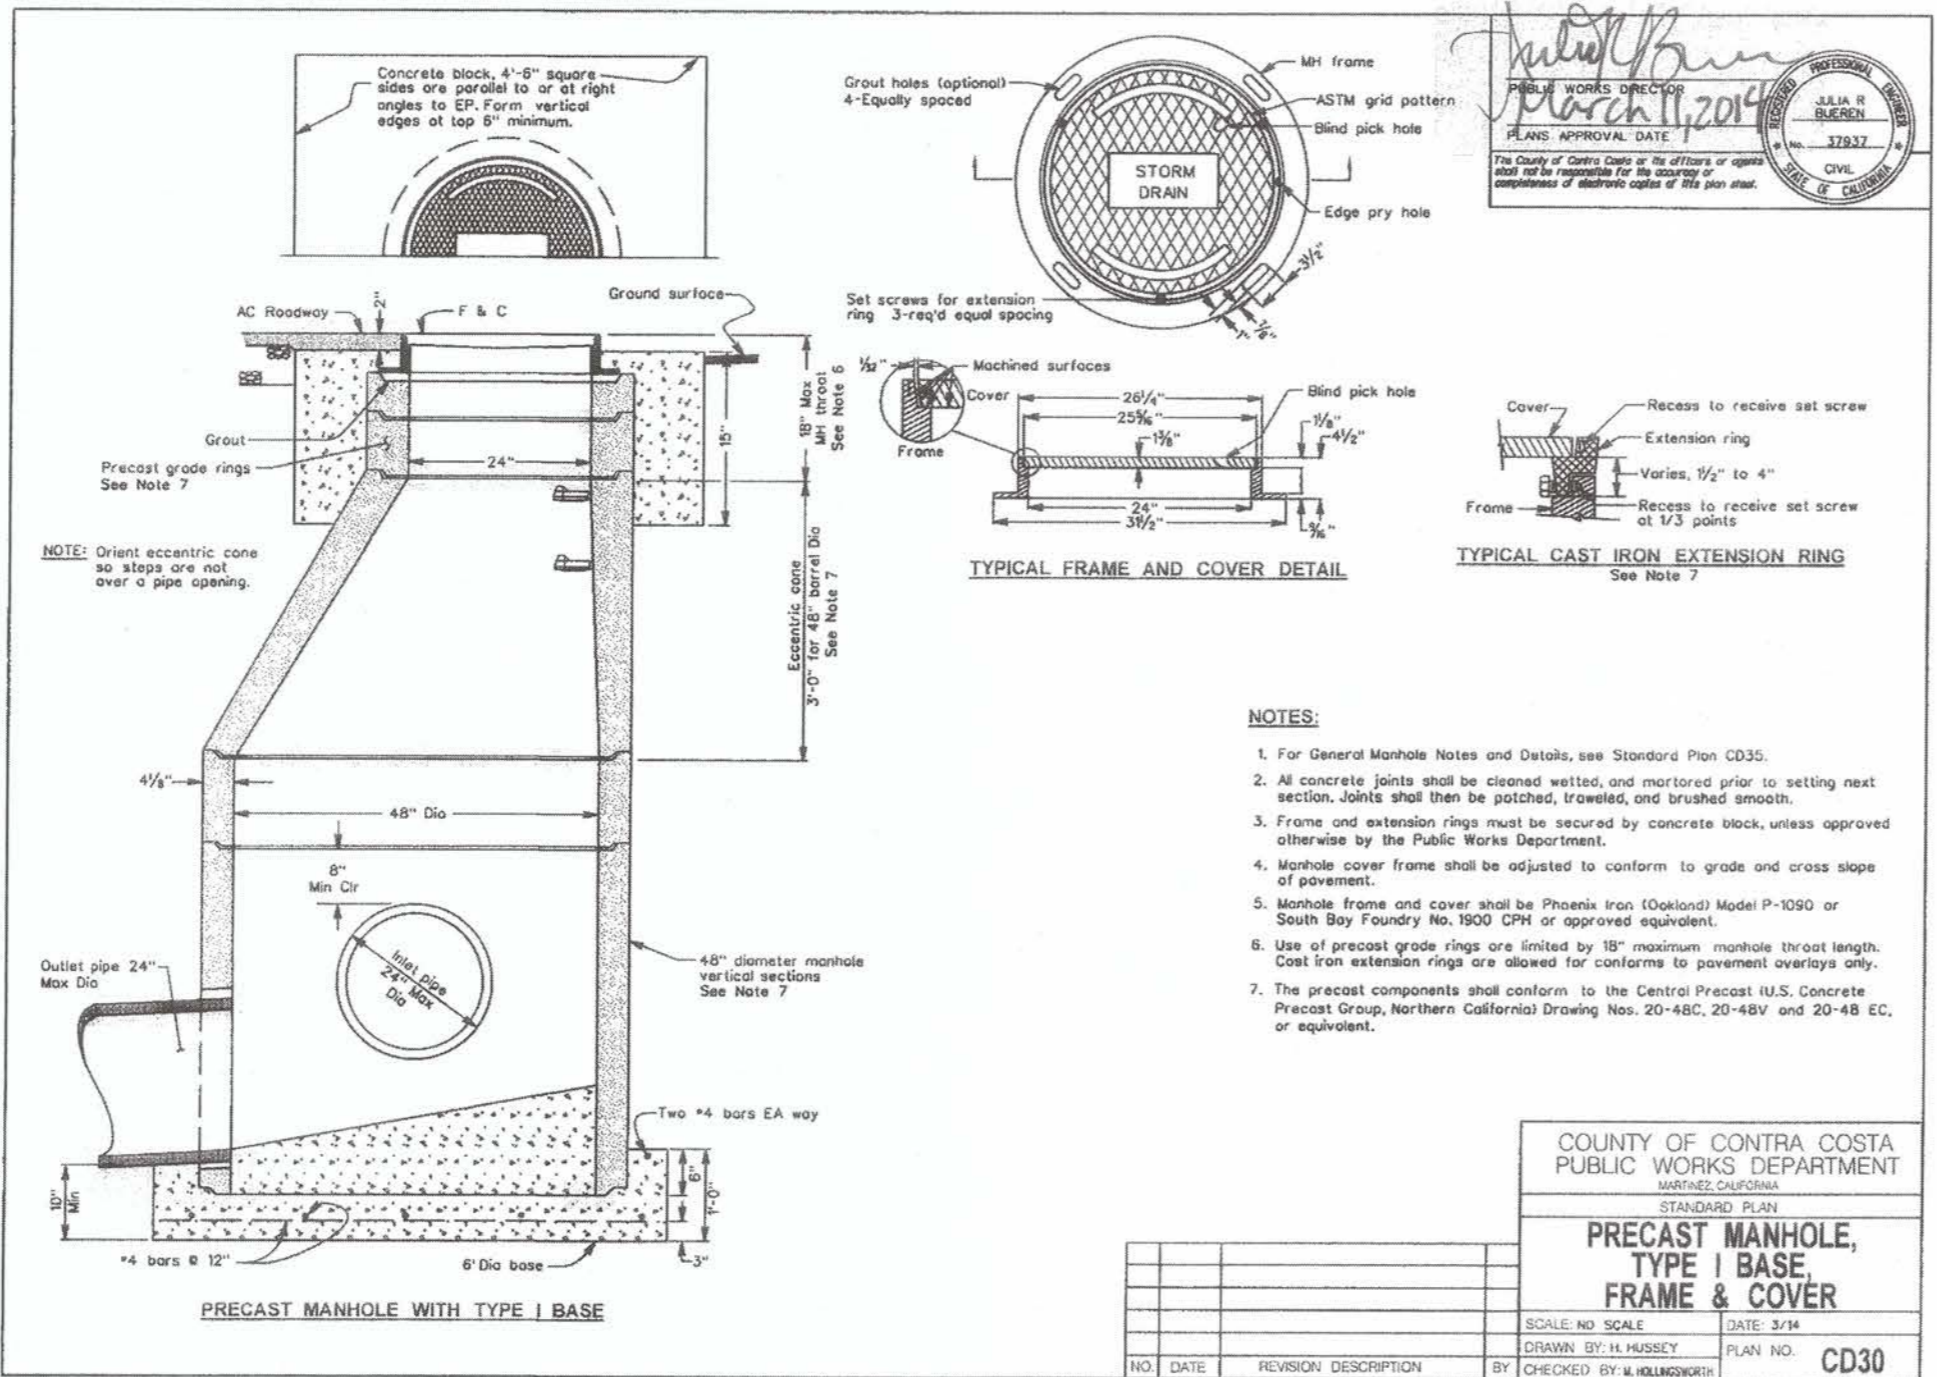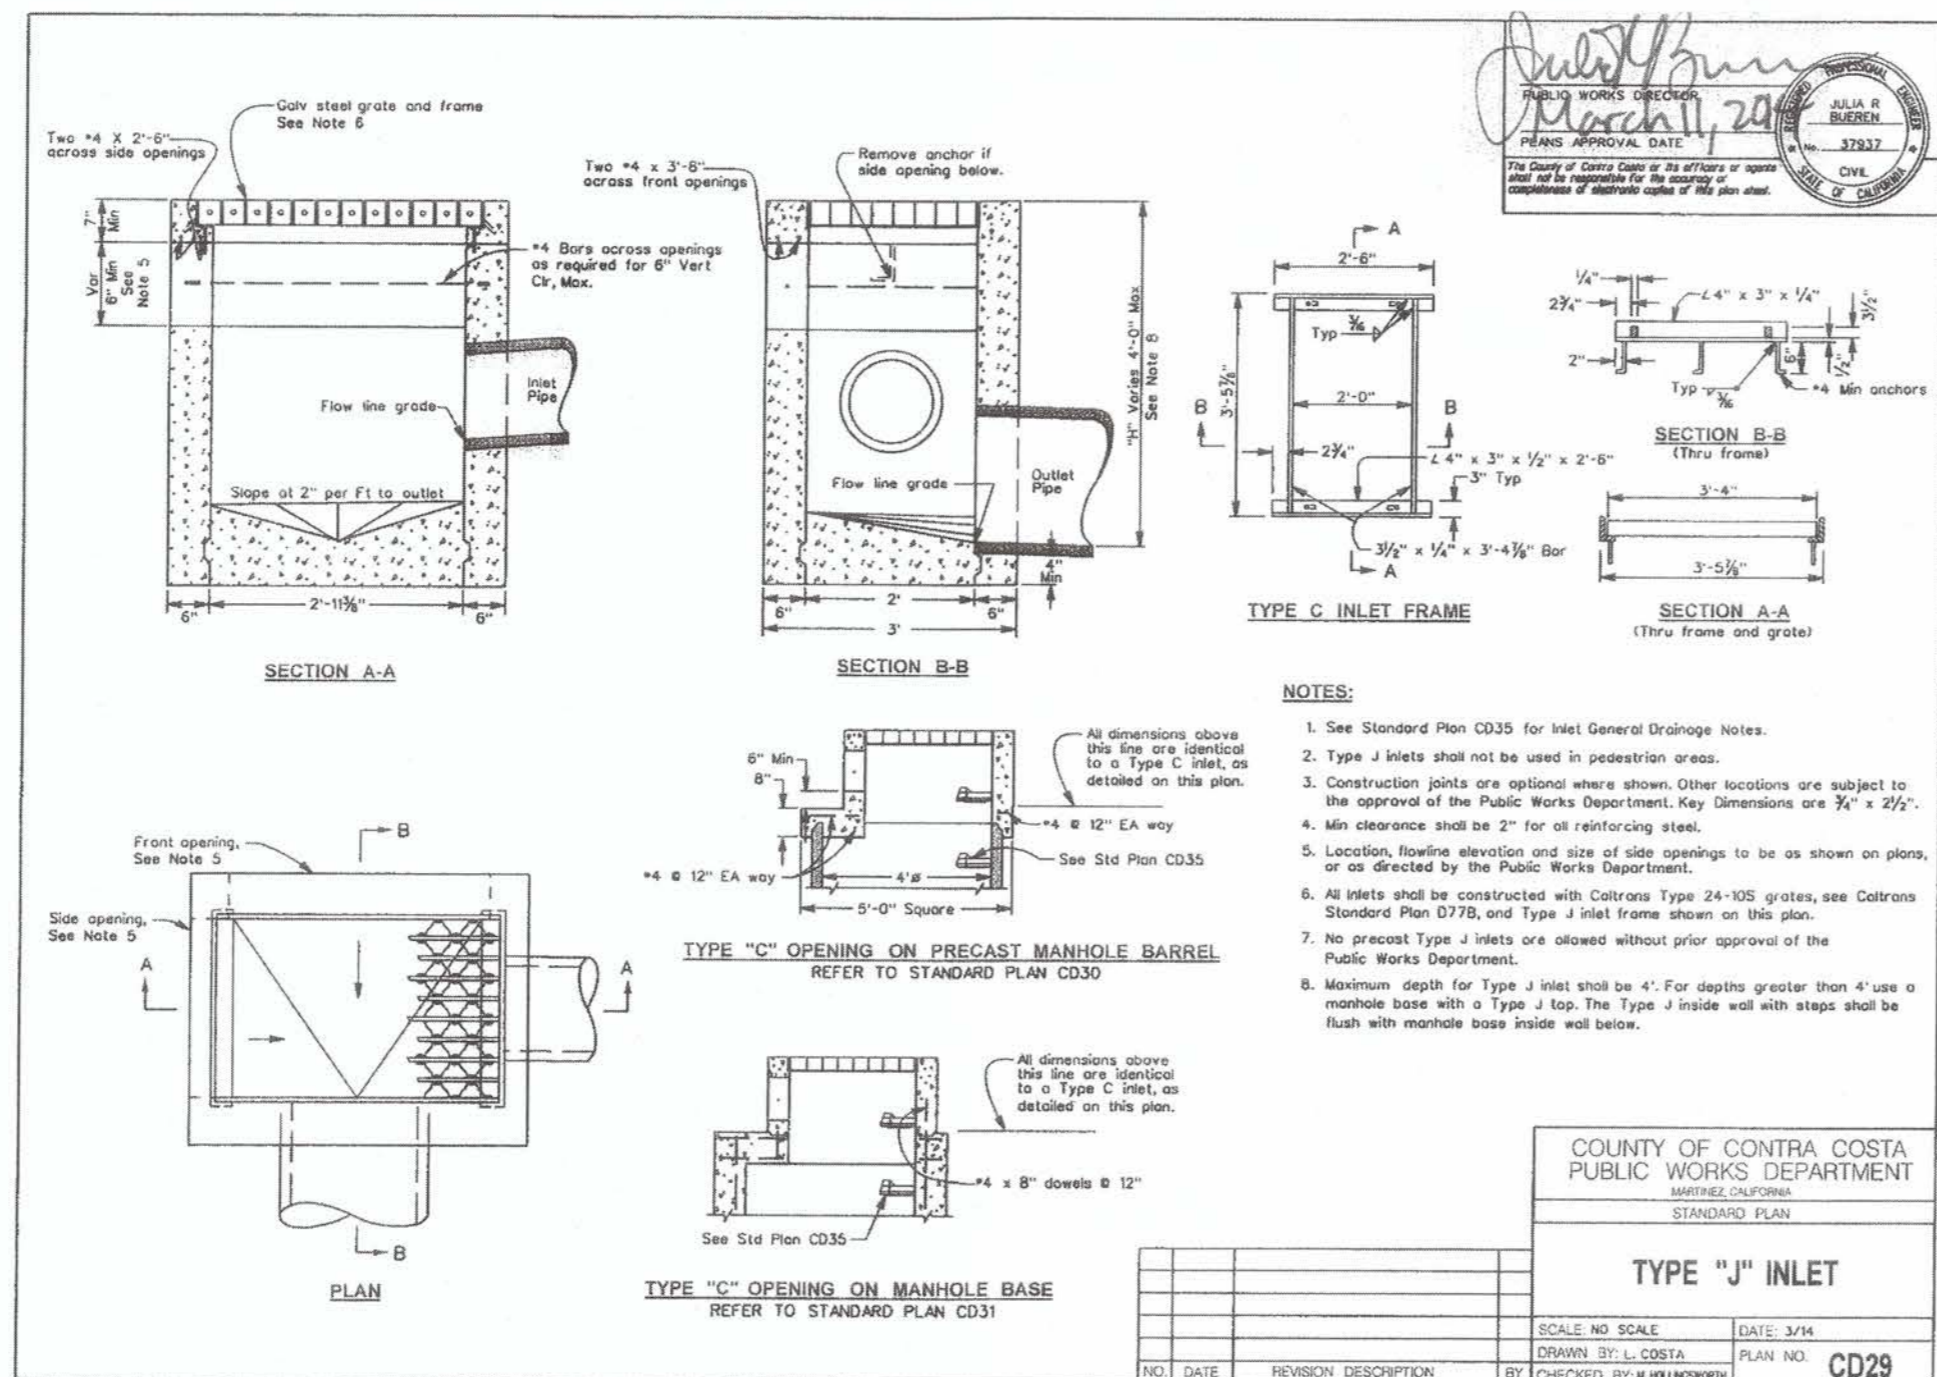

PROFESSIONAL ENGINEER
 CHAD J. BROWNING
 No. 066315
 Exp. 9/30/25
 CIVIL
 STATE OF CALIFORNIA

PREPARED UNDER THE DIRECTION OF:
 JOHN SAMUELSON
 City Engineer
 Date: 9/26/23

ACCEPTED FOR USE:
 City of Pittsburg


FRONTAGE ROAD
 LIVING GREEN TRAIL DESIGN
 CONSTRUCTION DETAILS

CONTRACT NAME:
 CONTRACT NUMBER:


DATE	REV	DESCRIPTION

DRAWN: CW
 CHECKED: SC
 REVIEWED: CB
 DATE: 09/05/23
 SCALE: AS NOTED


SHEET NO.
 20 OF 59
 DWG. NO.
 C-81

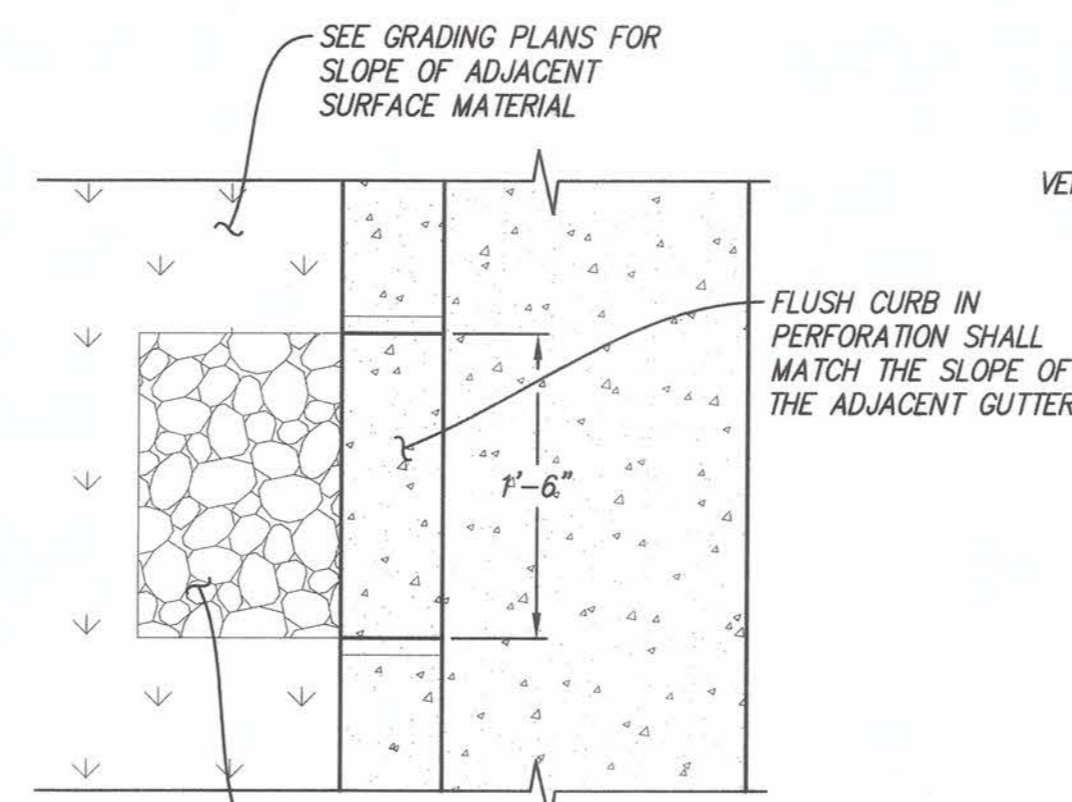

CURB PERFORATION AT CURB & GUTTER

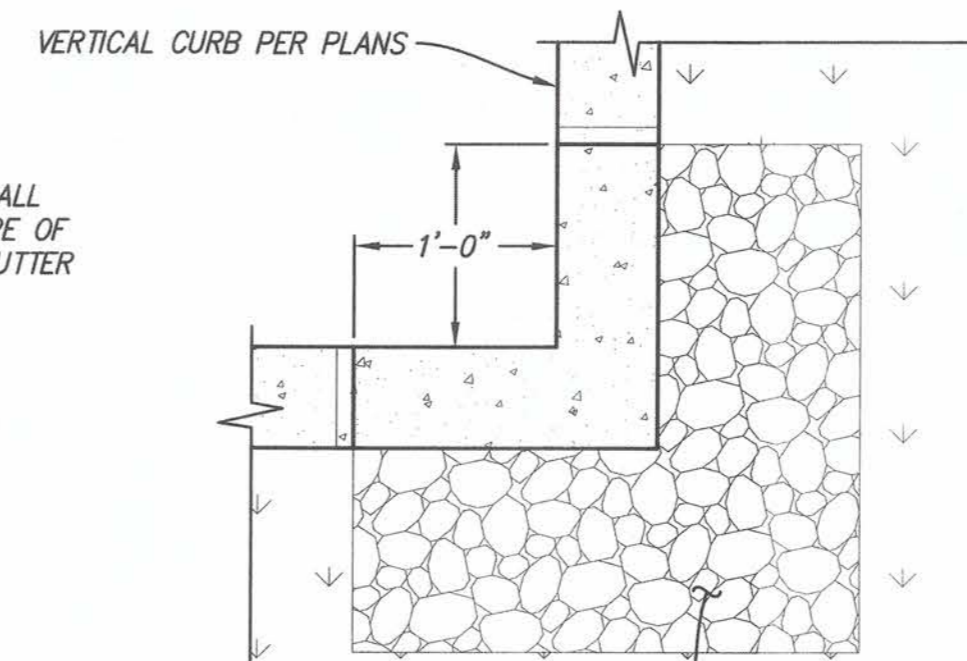

CURB PERFORATION AT CORNER

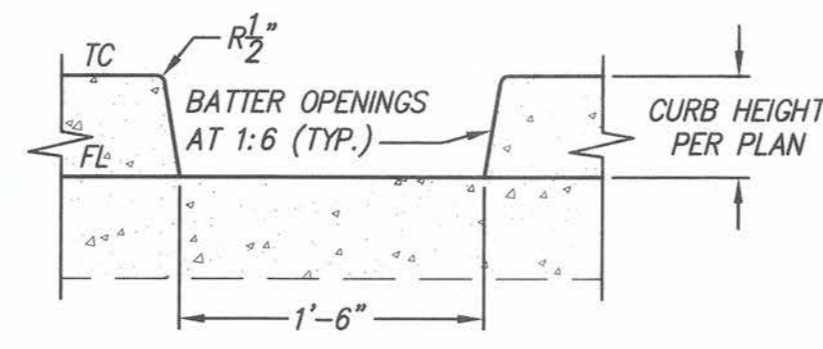

ELEVATION VIEW


NOTES:

1. ALL EXPOSED CONCRETE EDGES (HORIZONTAL AND VERTICAL) SHALL BE 1/2" RADIUS.
2. CURB OPENING FREQUENCY AND LOCATION SHALL BE PER PLAN.

CURB PERFORATION


1"=1'

5

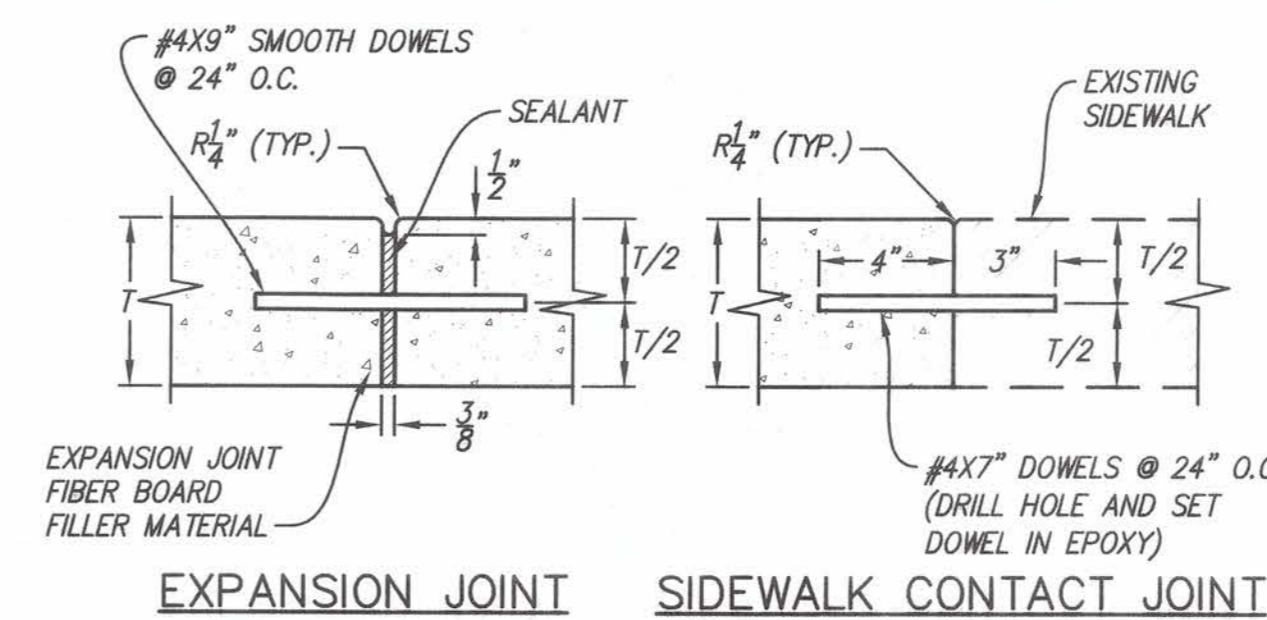


EXPANSION JOINT

SIDEWALK CONTACT JOINT

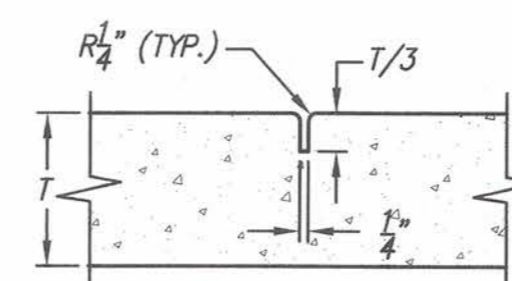

CONTROL JOINT

(2) #3 REBAR 3-FT LONG AT EACH CORNER. OMIT REBAR AT EXPANSION JOINTS

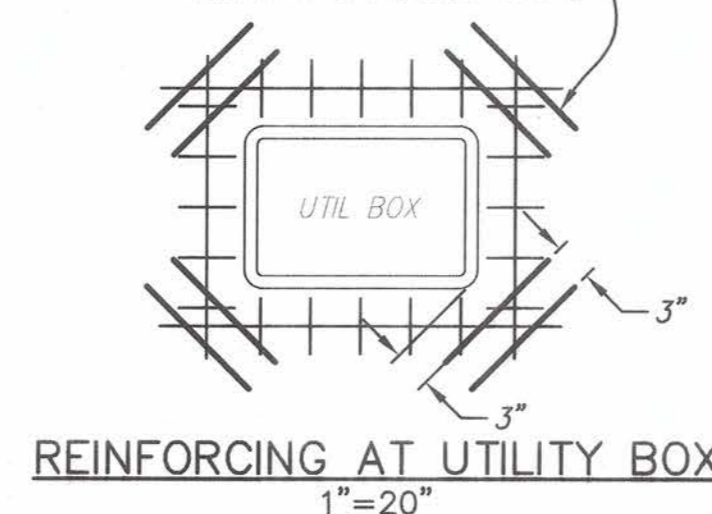

REINFORCING AT UTILITY BOX


NOTES:

1. REFER TO LANDSCAPE PLANS AND/OR PROJECT SPECIFICATIONS FOR JOINT SPACING.
2. REFER TO LANDSCAPE PLANS FOR SCORE PATTERN.

CONCRETE JOINTS


1"=0.5'

6

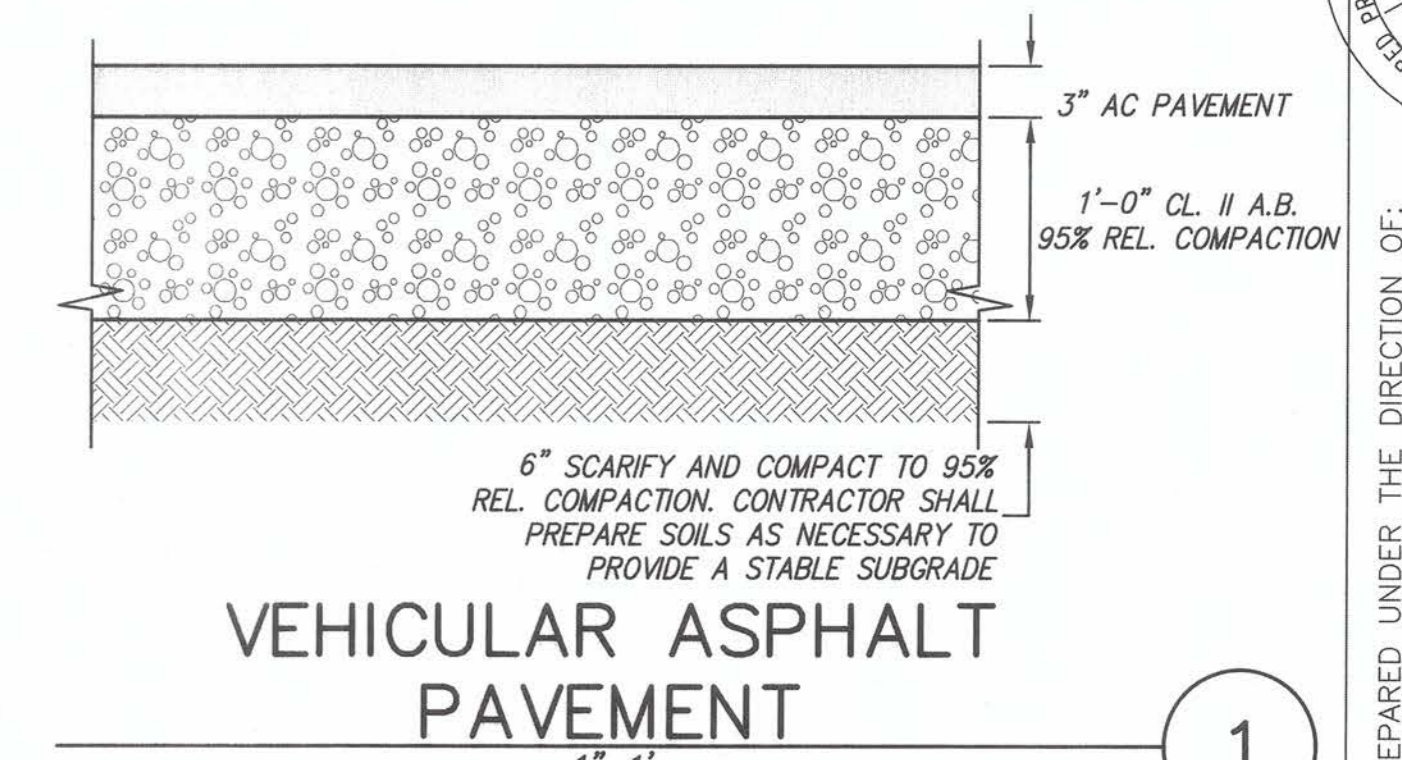


VEHICULAR ASPHALT PAVEMENT

1

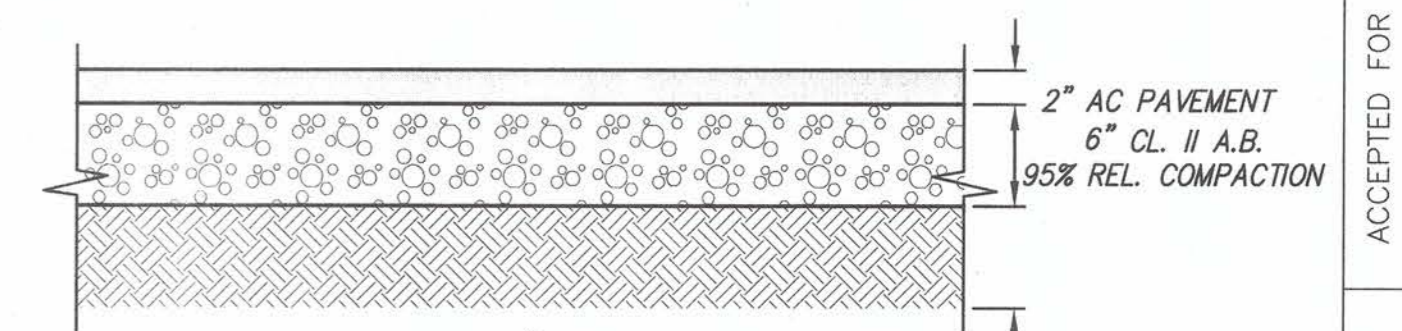


PEDESTRIAN ASPHALT PAVEMENT

2

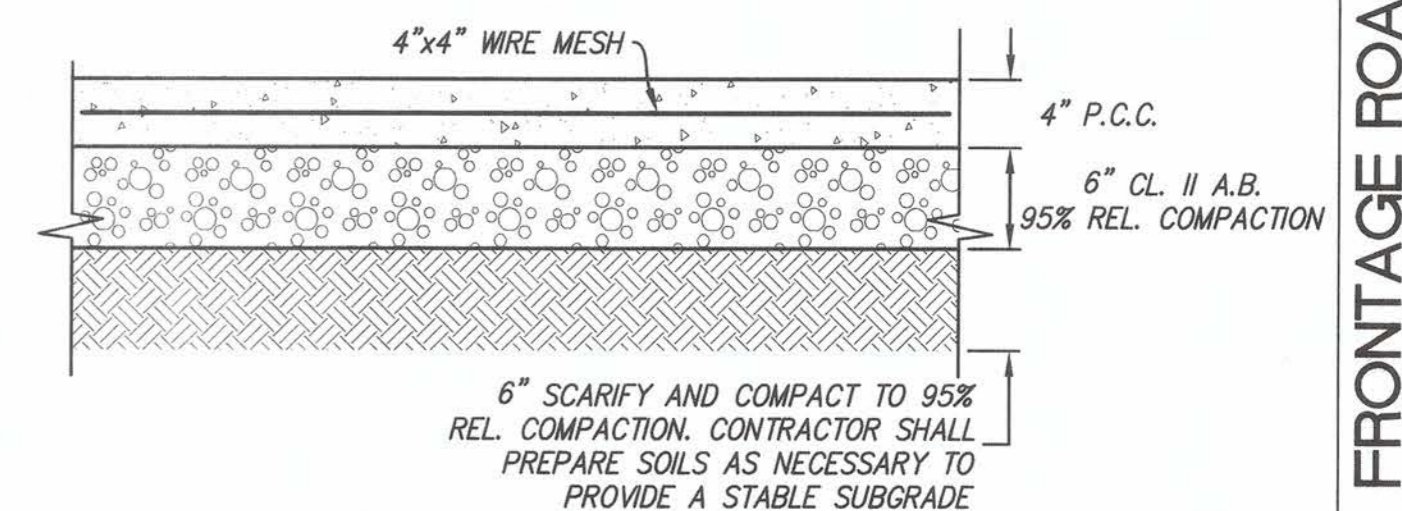

PEDESTRIAN CONCRETE


3

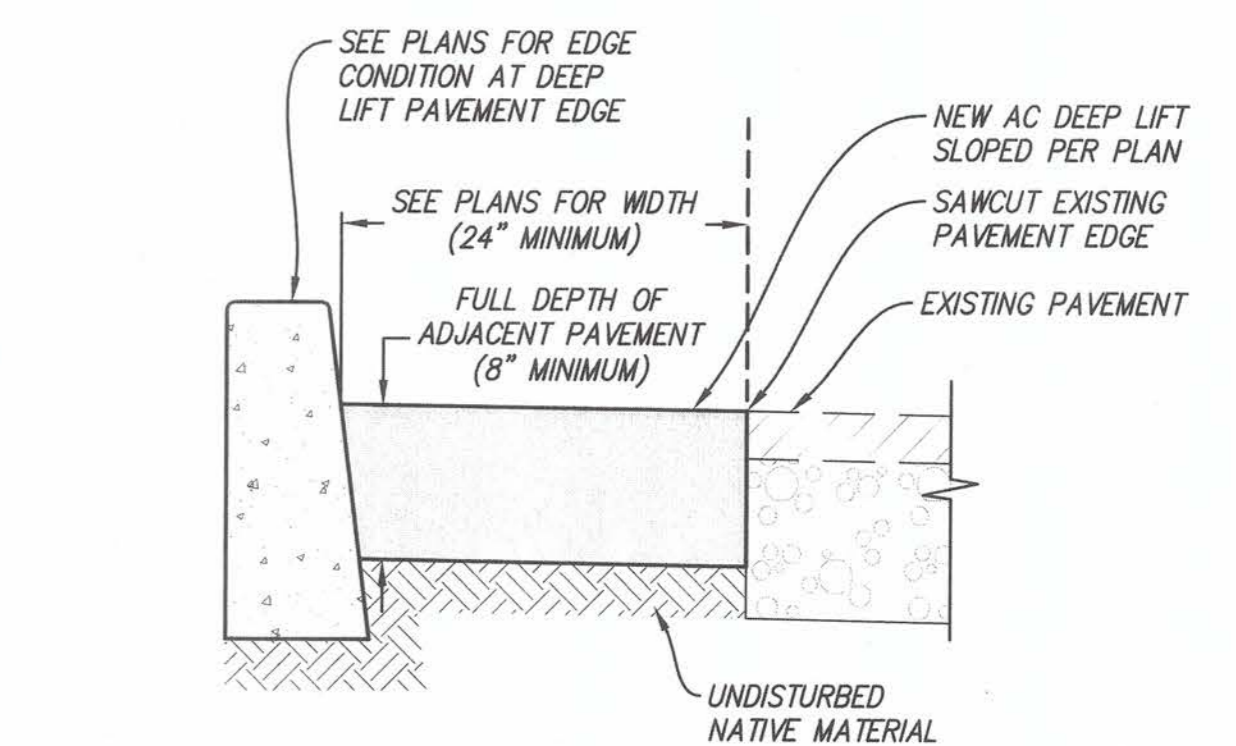

ASPHALT DEEP LIFT

1"=1'

4

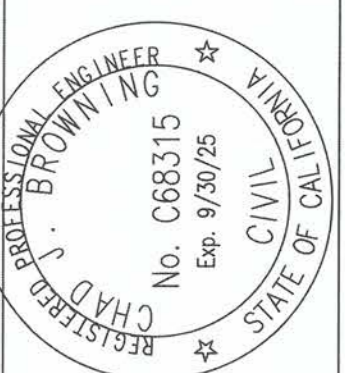

PREPARED UNDER THE DIRECTION OF:
Chad J. Browning
 CHAD J. BROWNING
 R.C.E. NO. 68315
 EXPIRES 9-30-25
 DATE: 9/20/23

ACCEPTED FOR USE:
John Samuelson
 JOHN SAMUELSON
 City Engineer
 Date: 9/26/23



FRONTAGE ROAD LIVING GREEN TRAIL DESIGN CONSTRUCTION DETAILS
 CONTRACT NAME:
 CONTRACT NUMBER:

BY	DATE	DESCRIPTION


DATE	REV	DESCRIPTION

SHEET NO. 21 OF 59
 DWG. NO. C-8.2


SANITARY SEWER NOTES

- See City Ordinance and Central Contra Costa Sanitary District (CCCS) Sections 1 - 15 for design criteria and details.
- Use S-2 for sanitary sewer lateral details. When S-2 conflicts with CCCSD details or specifications, the S-2 detail shall prevail.
- All other improvements shall be constructed per CCCSD details numbered DWG 1 through DWG 52, which is available online at <http://centralconra.org/index.cfm?navid=920> or may be purchased at the following location:
CCCS Offices
5019 Imhoff Place
Martinez, CA 94553
(925) 229-3890
- For trench width, use City Standard Detail R-5.
- Wherever "the Engineer" or "County Engineer" is used, this refers to the City Engineer.
- No steps in any structures (MH, vaults, etc.).
- Sanitary sewer mains, sewer manholes, and sewer lateral services (side sewers) shall be constructed in accordance with the CCCSD Standard Specifications (Sections 18 through 23 and selected Standard Details, as modified by these City Standards. City of Pittsburg Standard Specifications shall not apply except where the CCCSD Standard Specifications are silent.
- Where the CCCSD Standard Specifications and Standard Drawings make reference to "District", that term shall mean the City of Pittsburg. Except where modified by these City Standards, the Contractor shall furnish all materials and perform all construction operations and installations, television inspection, and testing of new facilities, regardless of contradictory language in the CCCSD standards stating that the work will be performed by the "District".
- Grade rings are to be 12" maximum.
- For motor court homes, manholes are to be located at least 30' from doors to avoid odor.
- Sewer - check concrete apron around it.

DRAFT	NO.	DATE	REVISION	DRAWN BY:	STANDARD DETAIL	DATE
	1	2019-01-11	NOTES 2-11	JK	SANITARY SEWER NOTES	3/8/23
				CHECKED BY: MK		
				DATE: 2019-01-11		
				SCALE: NONE		

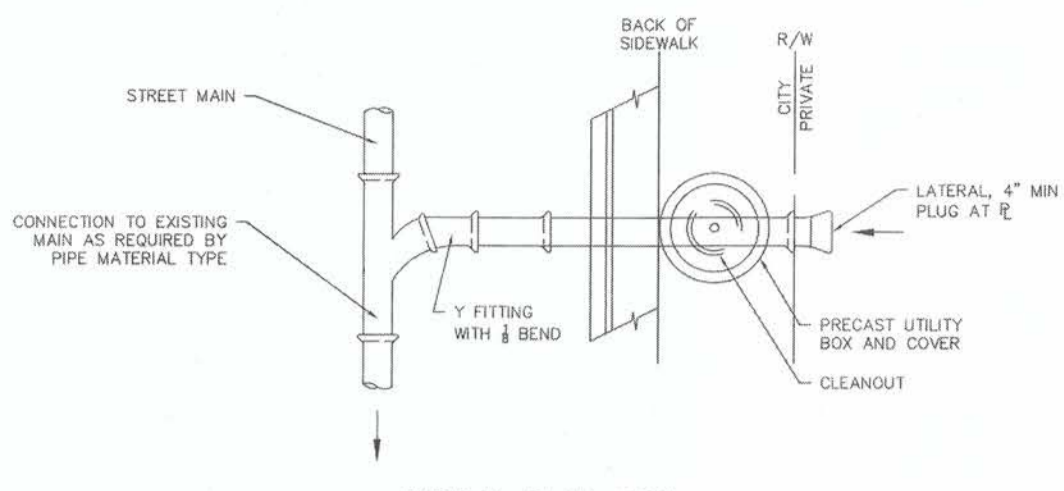

TYPICAL PLAN VIEW
SCALE: NTS

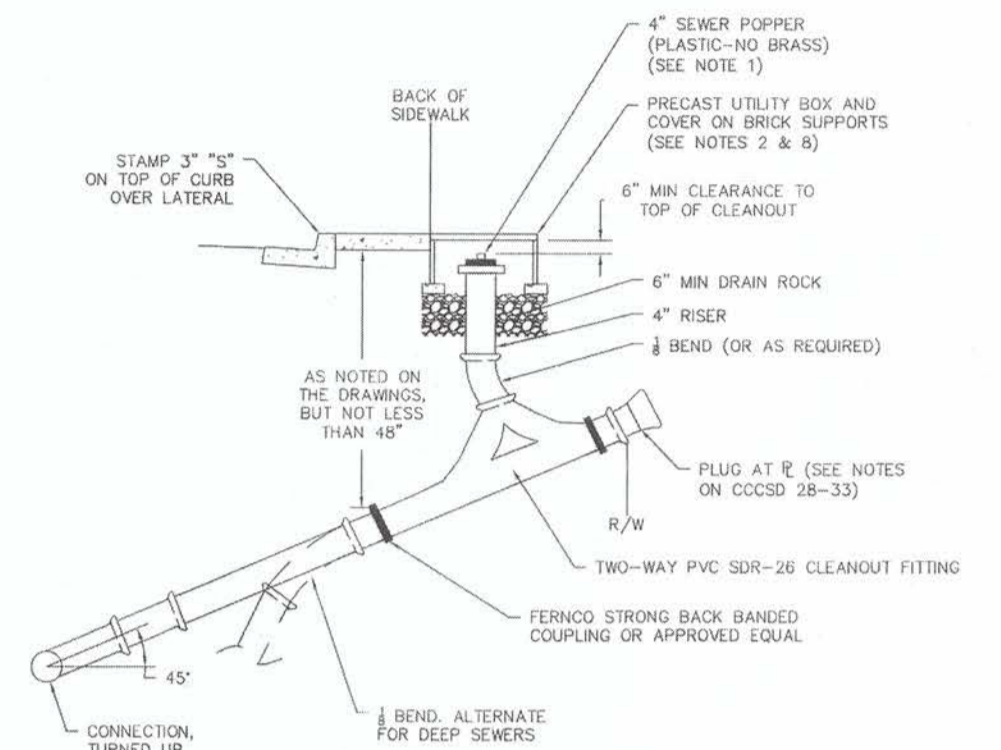


TYPICAL SECTION VIEW
SCALE: NTS

DRAFT	NO.	DATE	REVISION	DRAWN BY:	STANDARD DETAIL	DATE
	1	2019-01-11	NOTES 2-11	JK	SANITARY SEWER LATERAL CLEANOUT	3/8/23
				CHECKED BY: MK		
				DATE: 2019-01-11		
				SCALE: NTS		

SANITARY SEWER LATERAL CLEANOUT NOTES


- Jones Stephens Corp., sewer pop-up cleanout and relief valve, (part no. 562-304) 3" x 4". No hub, or approved equal, where required. (No brass).
- Christy F8 utility box and F8 reinforced concrete lid, or approved equal, labeled "SEWER".
- On laterals 6" and larger, use two-way PVC SDR-26 cleanout.
- Riser to be max. 6" diameter riser material to be the same as lateral.
- The minimum lateral slope shall be 1/8" per foot, for 4" diameter pipe, and 1/8" per foot for 6" diameter pipe.
- All lateral piping and fittings shall be the same diameter.
- Install sanitary sewer backwater overflow device when the pad elevation is less than 12" above nearest upstream sewer manhole rim or the finished floor (if known) is less than 12" above the nearest upstream sewer manhole rim.
- Where utility box is to be located in an area subject to vehicular traffic loading, the permittee shall furnish a traffic box for H/20 loading. Traffic box shall be Christy GST box with lid labeled "SEWER" or approved equal.
- Sanitary sewer cleanouts are to be at least 3' clear of driveway flares and a minimum horizontal clearance of 5' from water lateral.
- For laterals servicing two units or more, laterals shall be 6" PVC SDR-26.

DRAFT	NO.	DATE	REVISION	DRAWN BY:	STANDARD DETAIL	DATE
	1	2019-01-11	NOTES 2-11	JK	SANITARY SEWER LATERAL CLEANOUT - NOTES	3/8/23
				CHECKED BY: MK		
				DATE: 2019-01-11		
				SCALE: NONE		

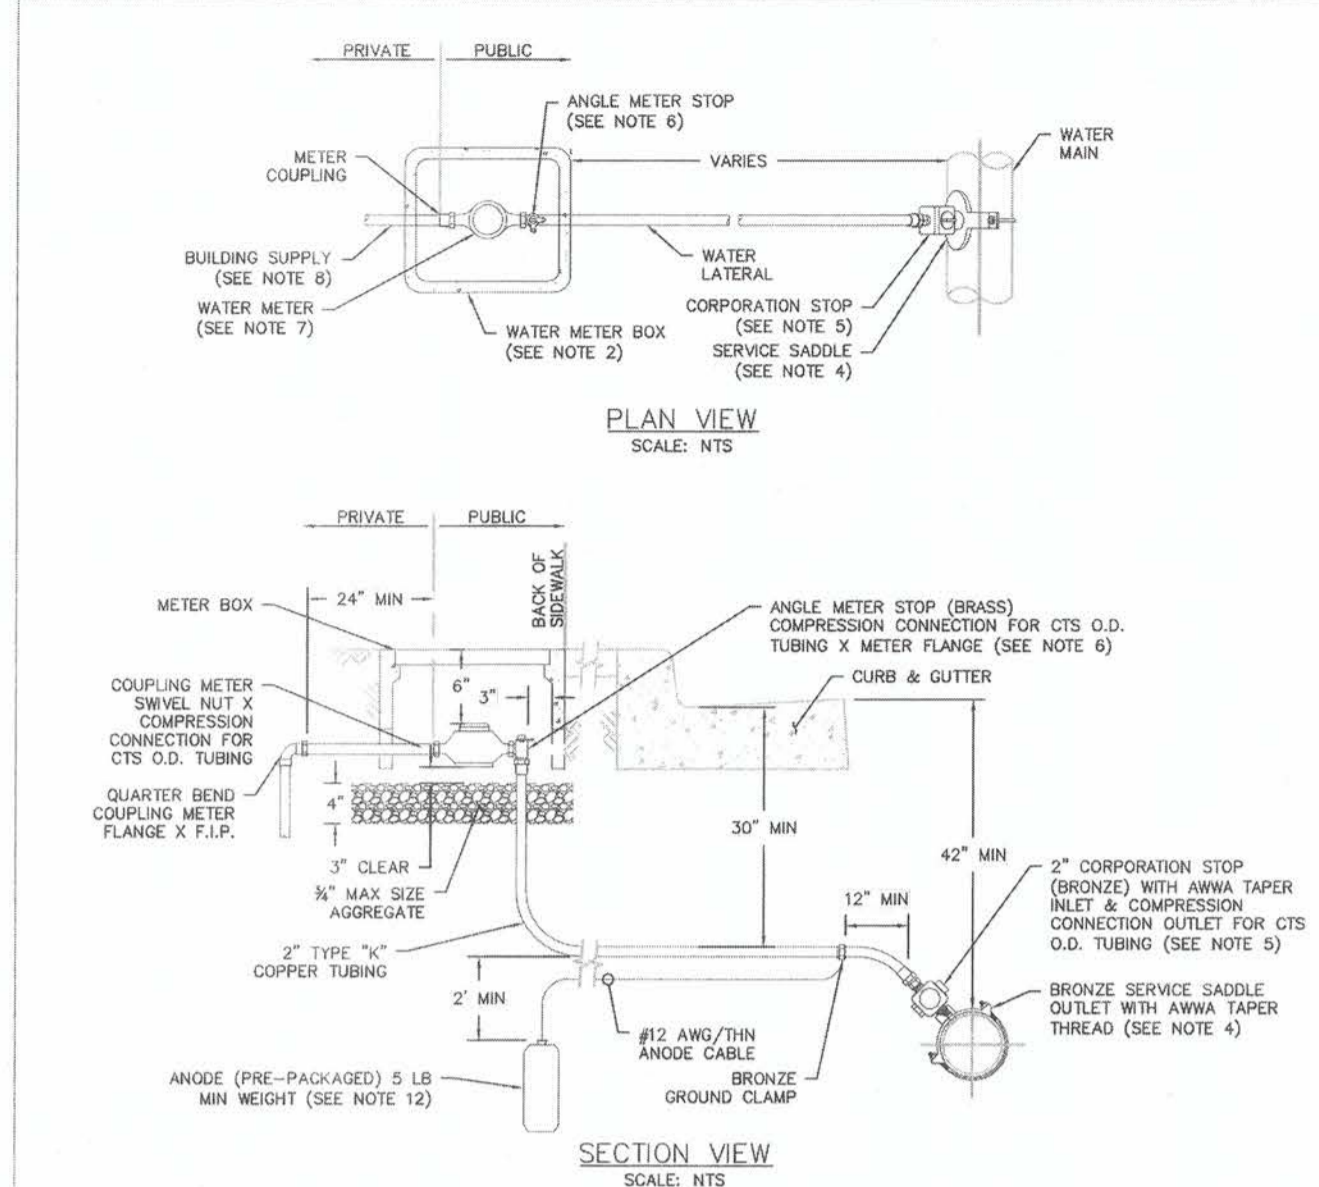

- NOTES**
- AFTER PAYMENT OF FEES, WATER METER SHALL BE FURNISHED AND INSTALLED BY THE CITY FOR NEW SERVICES.
 - METER BOX SHALL BE CHRISTY B36 (18" x 30") WITH FL36E LID (OR APPROVED EQUAL).
 - WHERE METER BOX IS TO BE LOCATED IN AN AREA SUBJECT TO VEHICULAR TRAFFIC LOADING, THE PERMITTEE SHALL FURNISH A TRAFFIC BOX FOR H/20 LOADING. TRAFFIC BOX SHALL BE CHRISTY B10" X17" WITH B36-616 LID (OR APPROVED EQUAL).
 - FOR PIPES UP TO 12" IN DIAMETER, THE SERVICE SADDLE SHALL BE MUELLER H-12000 SERIES C.C. TAPERED THREAD (OR APPROVED EQUAL). FOR PIPES LARGER THAN 12" IN DIAMETER, THE SERVICE SADDLE SHALL BE MUELLER H200 OR H205 SERIES (OR APPROVED EQUAL). SADDLES FOR PVC PIPE SHALL BE DOUBLE OR WIDE STRAP DESIGN.
 - CORPORATION STOP SHALL BE 2" MUELLER B-2500BN (OR APPROVED EQUAL).
 - ANGLE METER STOP SHALL BE 2" MUELLER B-2427BN (OR APPROVED EQUAL).
 - WATER METER SHALL BE LOCATED IN THE CENTER OF WATER METER BOX.
 - MINIMUM COVER OVER BUILDING SUPPLY (YARD PIPING) SHALL NOT BE LESS THAN THAT SPECIFIED IN THE UNIFORM PLUMBING CODE.
 - WATER SERVICES TO BE SIZED PER THE REQUIREMENTS OF THE LATEST VERSION OF CALIFORNIA PLUMBING CODE.
 - ALL WATER SERVICE FITTINGS SHALL BE LEAD-FREE.
 - THE METER BOX FOR A 1 1/2-IN TURBINE METER SHALL BE A CHRISTY B-30 BOX WITH B-30E LID (OR B-30-81G LID FOR TRAFFIC AREAS), OR APPROVED EQUALS. THE METER BOX FOR A 2-IN TURBINE METER SHALL BE A CHRISTY B-36 BOX WITH B-36E LID (OR B-36-81G LID FOR TRAFFIC AREAS), OR APPROVED EQUALS.
 - 5 LB MINIMUM ANODE REQUIRED ON ALL COPPER SERVICE LINES 2" AND LESS UNLESS GEOTECHNICAL REPORT STIPULATES IT IS NOT NECESSARY. ADDITIONAL WEIGHT MAY BE REQUIRED BY GEOTECHNICAL REPORT. INSULATING COUPLING REQUIRED BETWEEN COPPER WATER LATERAL AND WATER MAIN IF MAIN IS METALLIC.


DRAFT	NO.	DATE	REVISION	DRAWN BY:	STANDARD DETAIL	DATE
	1	2019-01-11	ADDED ANODE	DJR	2" COPPER WATER SERVICE FOR 1-1/2" & 2" WATER METERS	3/8/23
				CHECKED BY: MK		
				DATE: 2019-01-11		
				SCALE: NTS		

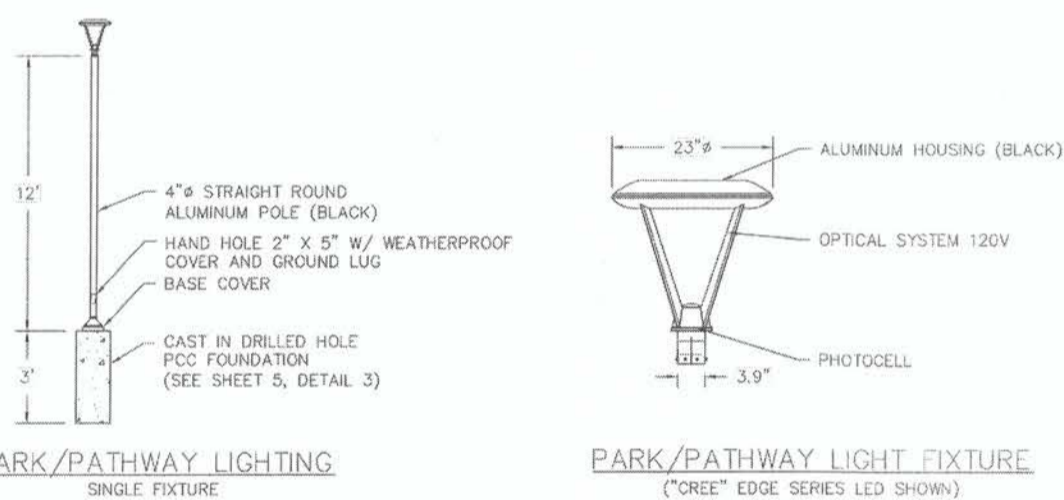

- NOTES**
- ALL POLE HARDWARE NUTS/BOLTS/SCREWS SHALL BE STAINLESS STEEL. FOUNDATION MOUNTING BOLTS/NUTS/WASHERS SHALL BE GALVANIZED.
 - A No. 5 PULLBOX SHALL BE INSTALLED AT EACH LIGHT POLE. PULLBOX LID SHALL HAVE "LIGHTING" STAMPED IN LID.
 - A PHOTOCELL SHALL BE INSTALLED IN EACH FIXTURE FOR UN-METERED ELECTRICAL SERVICE INSTALLATIONS.
 - A PHOTOCELL SHALL BE INSTALLED IN SERVICE ASSEMBLY FOR METERED ELECTRICAL SERVICE INSTALLATIONS.
 - EACH LIGHT FIXTURE SHALL BE FUSED.
 - CITY-APPROVED PARK/PATHWAY LIGHTING PARTS (OR APPROVED EQUALS) TO BE USED. SEE TABLE 2 FOR LIST OF CITY-APPROVED LIGHTING PARTS. SEE SHEET 6 FOR LIGHTING PARTS SPECIFICATIONS.

LIGHT FIXTURE	"ORLE" (EDGE SERIES) ARE-EDR-SM-R3-08-E-UL-BK-40R-525-P
POLE	"CYCLONE LIGHTING" PA40-12-IN32-BK-TX-R30
BASE COVER	"CYCLONE LIGHTING" B011-BK-TX


DRAFT	NO.	DATE	REVISION	DRAWN BY:	STANDARD DETAIL	DATE
	1	2019-01-11	PARTS LIST	TJM	PARK/PATHWAY LIGHTING	3/8/23
				CHECKED BY: MK		
				DATE: 2019-01-11		
				SCALE: NTS		

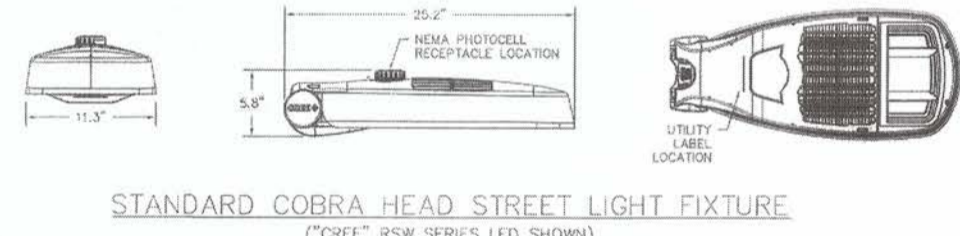


- NOTES**
- ALL POLE HARDWARE NUTS/BOLTS/SCREWS SHALL BE STAINLESS STEEL. MOUNTING BOLTS/NUTS SHALL BE GALVANIZED.
 - A PULLBOX SHALL BE INSTALLED AT EACH LIGHT POLE.
 - A PHOTOCELL SHALL BE INSTALLED ON EACH FIXTURE.
 - EACH LIGHT FIXTURE SHALL BE FUSED.
 - CONDUIT SHALL HAVE A MINIMUM COVER OF 24 INCHES.
 - USE 8' LUMINAIRE ARM FOR ROADWAYS LESS THAN 40' IN WIDTH AND 15' LUMINAIRE ARM FOR ROADWAYS 40' OR MORE IN WIDTH.
 - A PHOTOCELL SHALL BE INSTALLED IN EACH FIXTURE FOR UN-METERED ELECTRICAL SERVICE INSTALLATIONS.
 - A PHOTOCELL SHALL BE INSTALLED IN SERVICE ASSEMBLY FOR METERED ELECTRICAL SERVICE INSTALLATIONS.
 - CITY-APPROVED STANDARD STREET LIGHTING PARTS (OR APPROVED EQUALS) TO BE USED. SEE TABLE 3 FOR LIST OF CITY-APPROVED LIGHTING PARTS. SEE SHEET 6 FOR LIGHTING PARTS SPECIFICATIONS.

LIGHT FIXTURE	"ORLE" (RISER SERIES, MEDIUM) RSM-A-RHT-SM-14-40R-UL-01-N-0
POLE	"THARCO" ALUMINUM POLE AND LUMINAIRE ARM (SEE SHEET 4)


DRAFT	NO.	DATE	REVISION	DRAWN BY:	STANDARD DETAIL	DATE
	1	2019-01-11	PARTS LIST	AW	STANDARD STREET LIGHTING	3/8/23
				CHECKED BY: MK		
				DATE: 2019-01-11		
				SCALE: NTS		

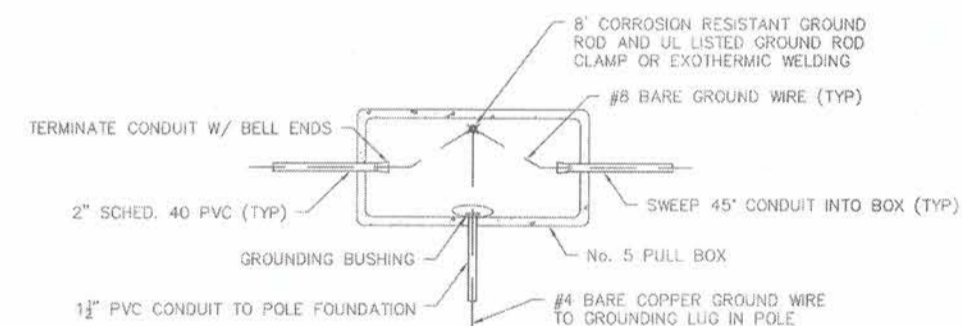

1 PULLBOX INSTALLATION
FOR ALL STREET LIGHTING

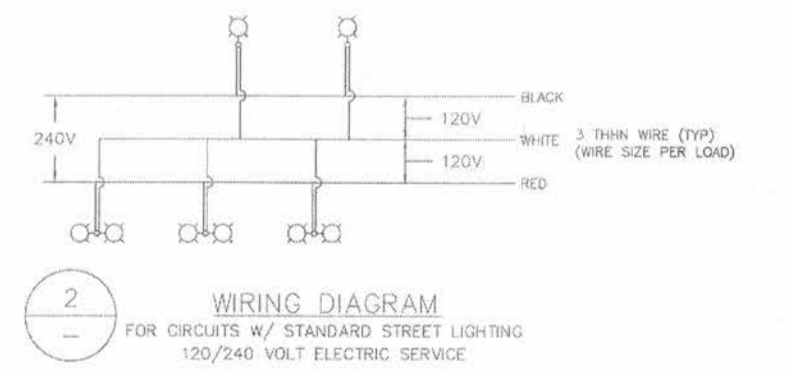

2 WIRING DIAGRAM
FOR CIRCUITS W/ STANDARD STREET LIGHTING
120/240 VOLT ELECTRIC SERVICE

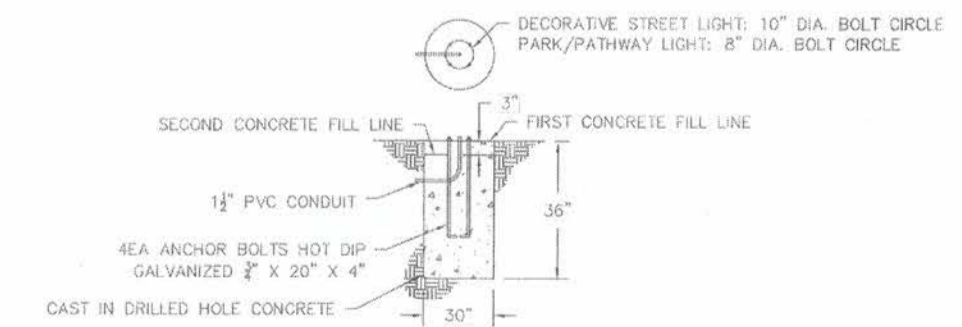

3 STREET LIGHT FOUNDATION
FOR DECORATIVE AND PARK/PATHWAY LIGHTING

DRAFT	NO.	DATE	REVISION	DRAWN BY:	STANDARD DETAIL	DATE
	1	2019-01-11	PARTS LIST	TJM	LIGHTING DETAILS	3/8/23
				CHECKED BY: MK		
				DATE: 2019-01-11		
				SCALE: NTS		



PREPARED UNDER THE DIRECTION OF:
Chad J. Browning
DATE: 9/20/23

ACCEPTED FOR USE:
John Samuelson
City Engineer
DATE: 9/21/23




**FRONTAGE ROAD
LIVING GREEN TRAIL DESIGN
CONSTRUCTION DETAILS**
CONTRACT NAME:
CONTRACT NUMBER:

BY	DESCRIPTION
DRAWN: CW	
CHECKED: SC	
REVIEWED: CB	
DATE: 09/05/23	
SCALE: AS NOTED	

DATE	REV	DESCRIPTION

SHEET NO.
22 OF 59
DWG. NO.
C-83

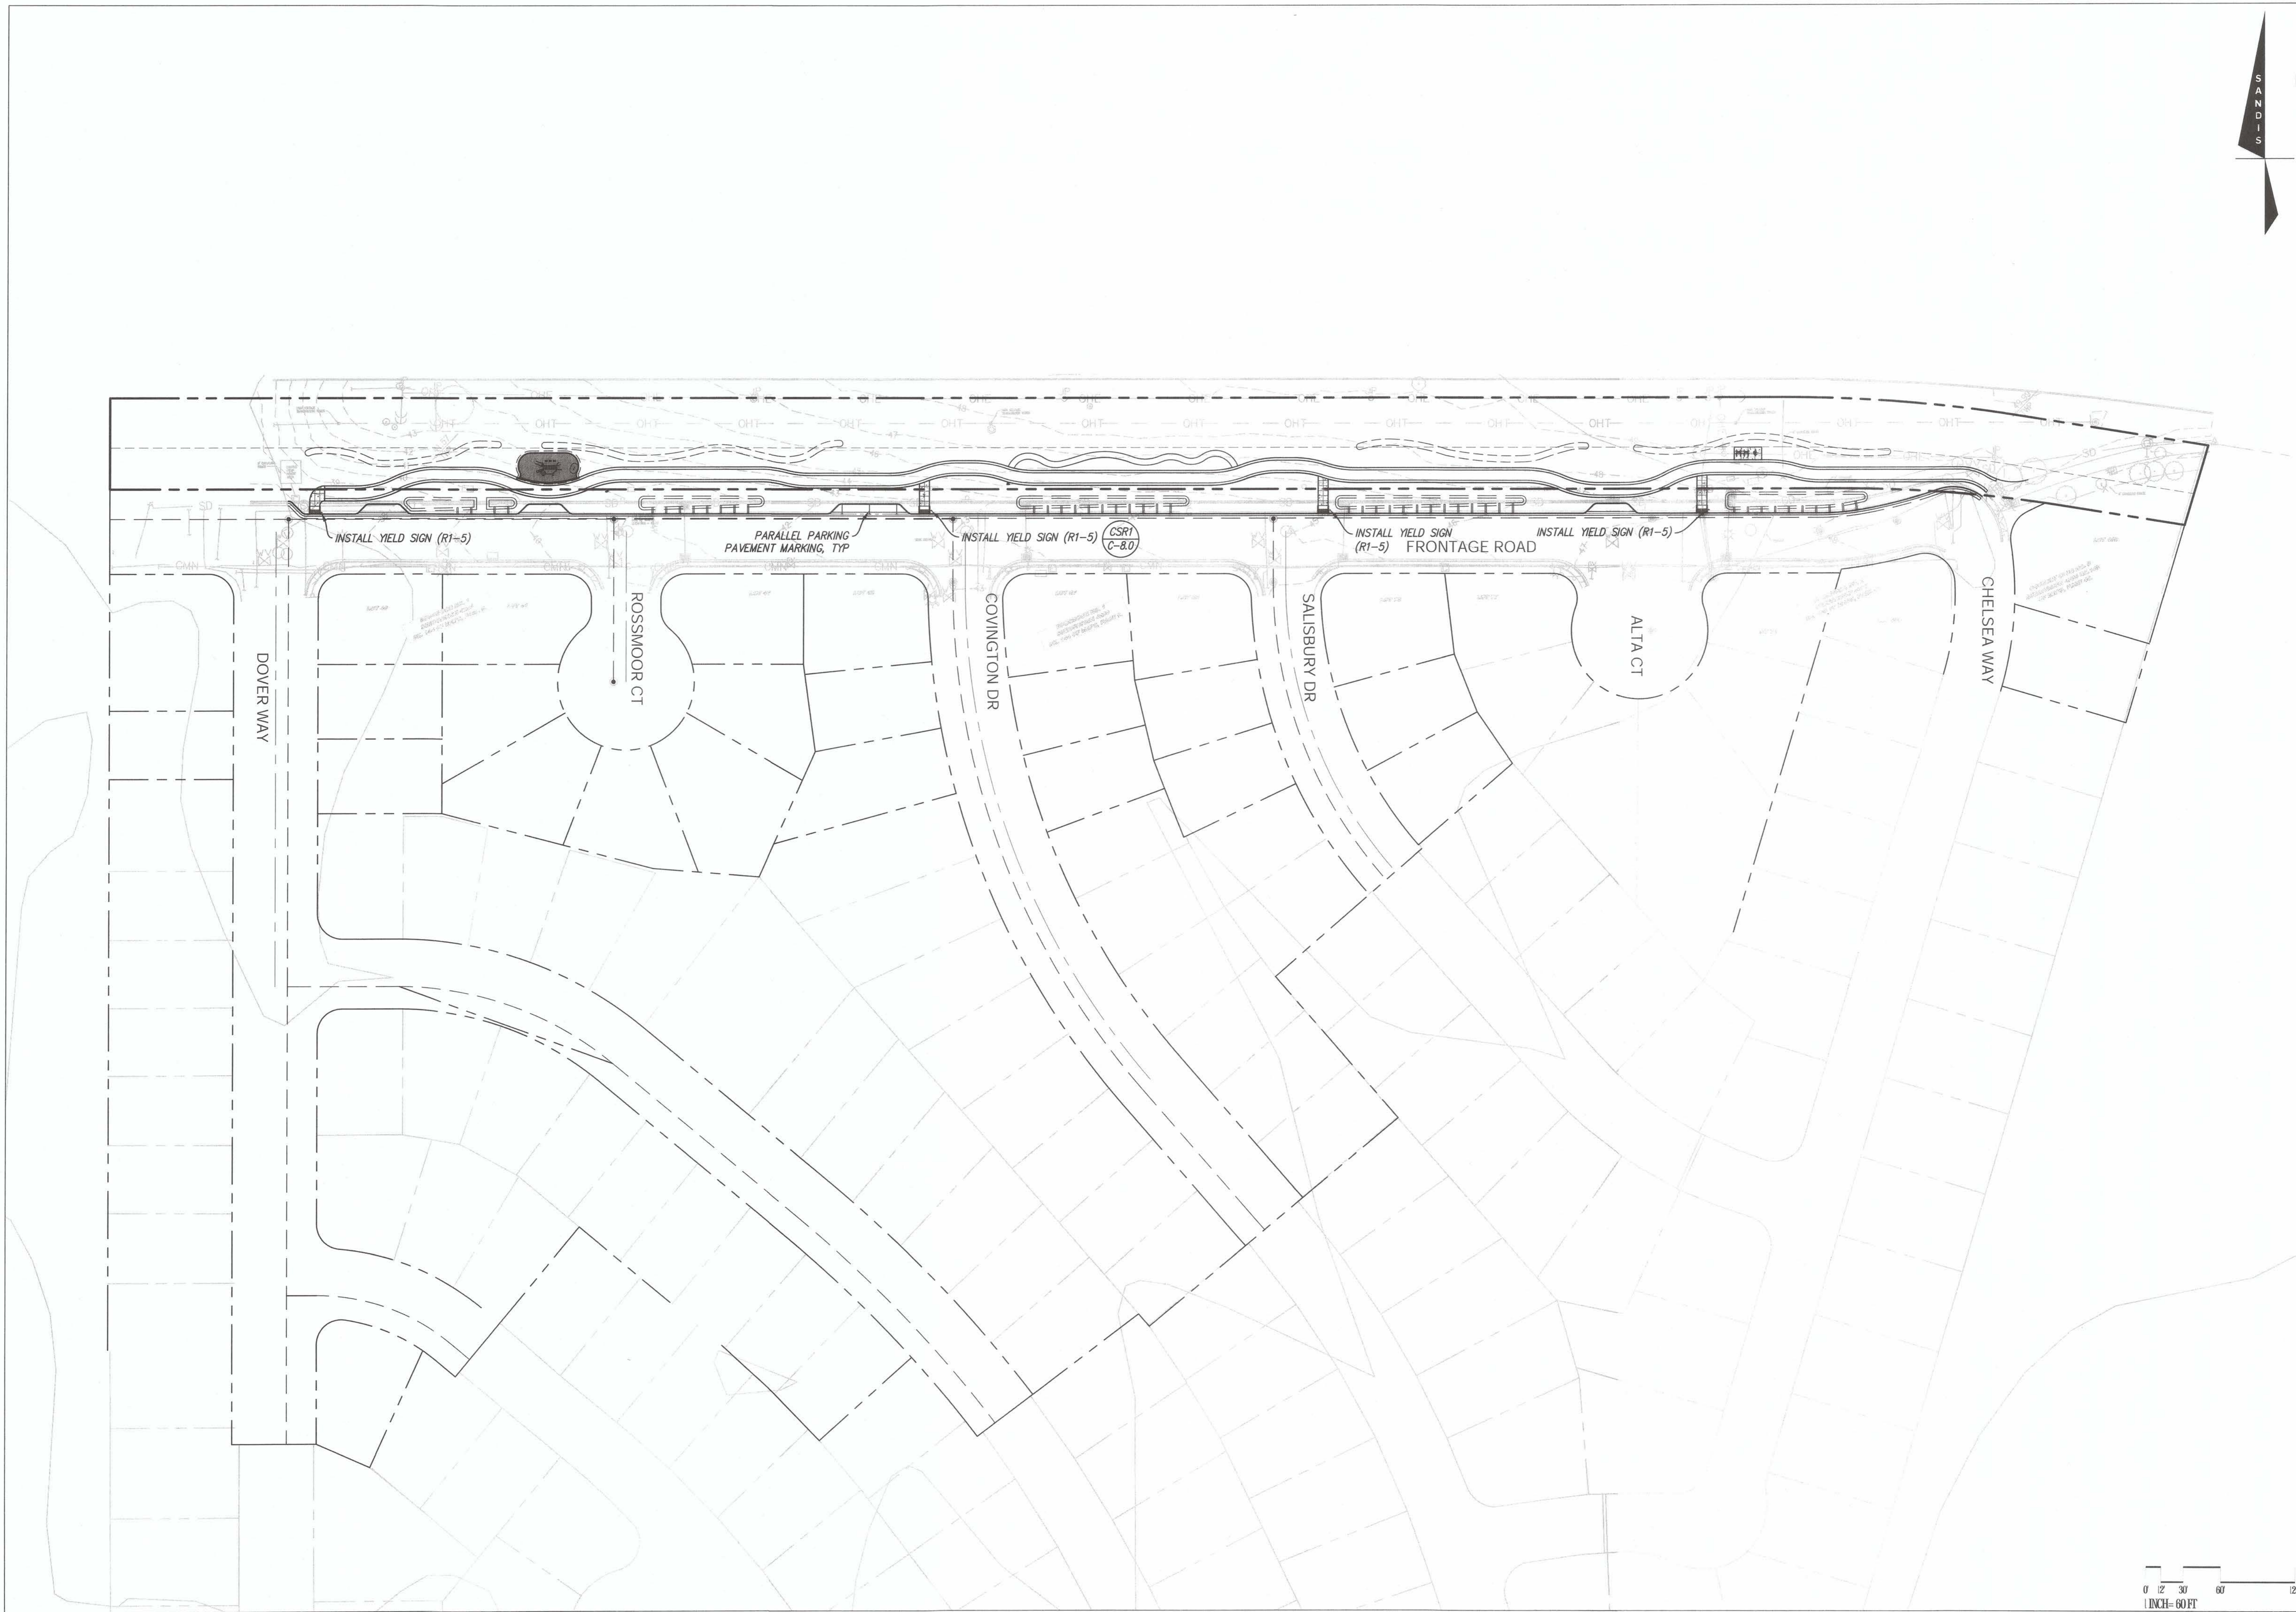

DATE	REV	DESCRIPTION	BY	DRAWN: CW
				CHECKED: SC
				REVIEWED: CB
				DATE: 09/05/23
				SCALE: AS NOTED

FRONTAGE ROAD
LIVING GREEN TRAIL DESIGN
SIGNAGE AND STRIPING PLAN

CONTRACT NAME:
 CONTRACT NUMBER:




ACCEPTED FOR USE:

John Samuelson
 John Samuelson
 City Engineer
 Date: 9/22/23






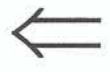

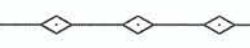


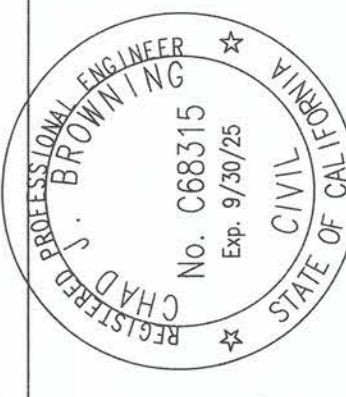PREPARED UNDER THE DIRECTION OF:

Chad J. Browning
 Chad J. Browning
 No. C68315
 Exp. 9/30/25
 REGISTERED CIVIL ENGINEER
 STATE OF CALIFORNIA

DATE: 9/20/23




LEGEND

-  STABILIZED EXIT (TC-1 C-10.1)
-  CONCRETE WASHOUT
-  SPILL KIT
-  PORTABLE RESTROOM
-  CONSTRUCTION TRAILER
-  PATH OF SURFACE DRAINAGE
-  FIBER ROLL (SE-9 C-10.1)
-  SILT FENCE (SE-1 C-10.1)
-  INLET PROTECTION (SE-10 C-10.1)
-  APPROXIMATE AREA OF CONSTRUCTION DISTURBANCE - AREA TO COMPLY WITH REQUIREMENTS IN PROJECT SWPPP

WATER POLLUTION CONTROL NOTES:

- A. TEMPORARY CONSTRUCTION ENTRANCE/EXIT LOCATION SHOWN IS APPROXIMATE. CONTRACTOR TO PROVIDE LOCATION WHERE APPROPRIATE.
- B. THIS PLAN REPRESENTS POSSIBLE WATER POLLUTION CONTROL MEASURES INCLUDING EROSION CONTROL AND SEDIMENT CONTROL.
- C. EXISTING SURFACES SHALL BE UNDISTURBED TO THE EXTENT PRACTICAL.
- D. GROUND WATER SHALL NOT BE DISCHARGED WITH STORM WATER. GROUND WATER DEWATERING OPERATIONS SHALL BE COORDINATED AS NEEDED WITH OWNER.
- E. CONTRACTOR SHALL PROVIDE EFFECTIVE SOIL COVER FOR AREAS OF CONSTRUCTION ACTIVITY THAT HAVE BEEN DISTURBED AND ARE NOT SCHEDULED TO BE ACTIVE FOR AT LEAST 14 DAYS.
- F. ALL EROSION CONTROL AND SEDIMENT CONTROLS TO BE OBTAINED INSTALLED AND MAINTAINED AS REQUIRED IN PROJECT SWPPP.
- G. CONTRACTOR TO INSTALL RUN-ON AND RUN-OFF CONTROL MEASURES ACCORDING TO PLANS OR AS NECESSARY TO ENSURE SEDIMENT IS NOT TRANSPORTED FROM SITE.
- H. CONTRACTOR TO PROVIDE BACK-UP EROSION PREVENTION MEASURES (SOIL STABILIZATION) WITH SEDIMENT CONTROL MEASURES SUCH AS STRAW WATTLES, SILT FENCE, GRAVEL INLET FILTERS, AND/OR SEDIMENT TRAPS OR BASINS. ENSURE CONTROL MEASURES ARE ADEQUATE, IN PLACE, AND IN OPERABLE CONDITIONS. SEDIMENT CONTROLS, INCLUDING INLET PROTECTION, ARE NECESSARY BUT SHOULD BE A SECONDARY DEFENSE BEHIND GOOD EROSION CONTROL MEASURES.
- I. STOCKPILE LOCATION(S) TO BE DETERMINED BY THE CONTRACTOR. COORDINATE WITH SITE O&P.
- J. ALL CONCRETE TRUCKS TO USE CHUTE WASH BUCKETS FOR CONCRETE RINSE, ALL CONCRETE PUMPS TO CAPTURE CONCRETE RINSE IN SECONDARY CONTAINMENT AND PROPERLY DISPOSE.
- K. STREET SWEEPING SHALL BE CHECKED DAILY TO ENSURE DEPOSITED SEDIMENT AND DEBRIS DOES NOT ENTER THE STORM DRAIN SYSTEM. USE REGENERATIVE VACUUM STREET CLEANER TO MITIGATE AIR AND WATER POLLUTION.
- L. RUNOFF THAT HAS CONTACTED AMENDED SOIL AREAS SHALL NOT BE ALLOWED TO LEAVE THE SITE OR ENTER THE STORM DRAIN SYSTEM.
- M. THE SURFACE OF CUT AND FILL SLOPES WITH GREATER THAN 5' IN VERTICAL HEIGHT SHOULD BE COVERED BY A TURF REINFORCING MAT TO HELP PROVIDE TEMPORARY EROSION PROTECTION UNTIL VEGETATION IS RE-ESTABLISHED OVER THE AREA TO PROVIDE LONG-TERM EROSION PROTECTION OF THE SLOPE SURFACE. A TYPE A REINFORCING MAT MEETING THE REQUIREMENTS OF SECTION 21-2.020(5) OF THE 2018 CALTRANS STANDARD SPECIFICATIONS, SUCH AS MIRAFI TM13C OR EQUIVALENT, SHALL BE USED. THE TURF REINFORCING MAT SHOULD BE OVERLAPPED A MINIMUM OF 1' AT THE SEAMS AND FIXED TO THE SURFACE OF THE SLOPE PER THE MANUFACTURER'S REQUIREMENTS. AT THE CONCLUSION OF CONSTRUCTION OPERATIONS, CUT AND FILL SLOPES SHOULD BE HYDROSEEDING TO HELP ENCOURAGE GROWTH OF VEGETATION ON THE SURFACE TO SERVE AS AN ADDITIONAL LONG-TERM EROSION CONTROL MEASURE.

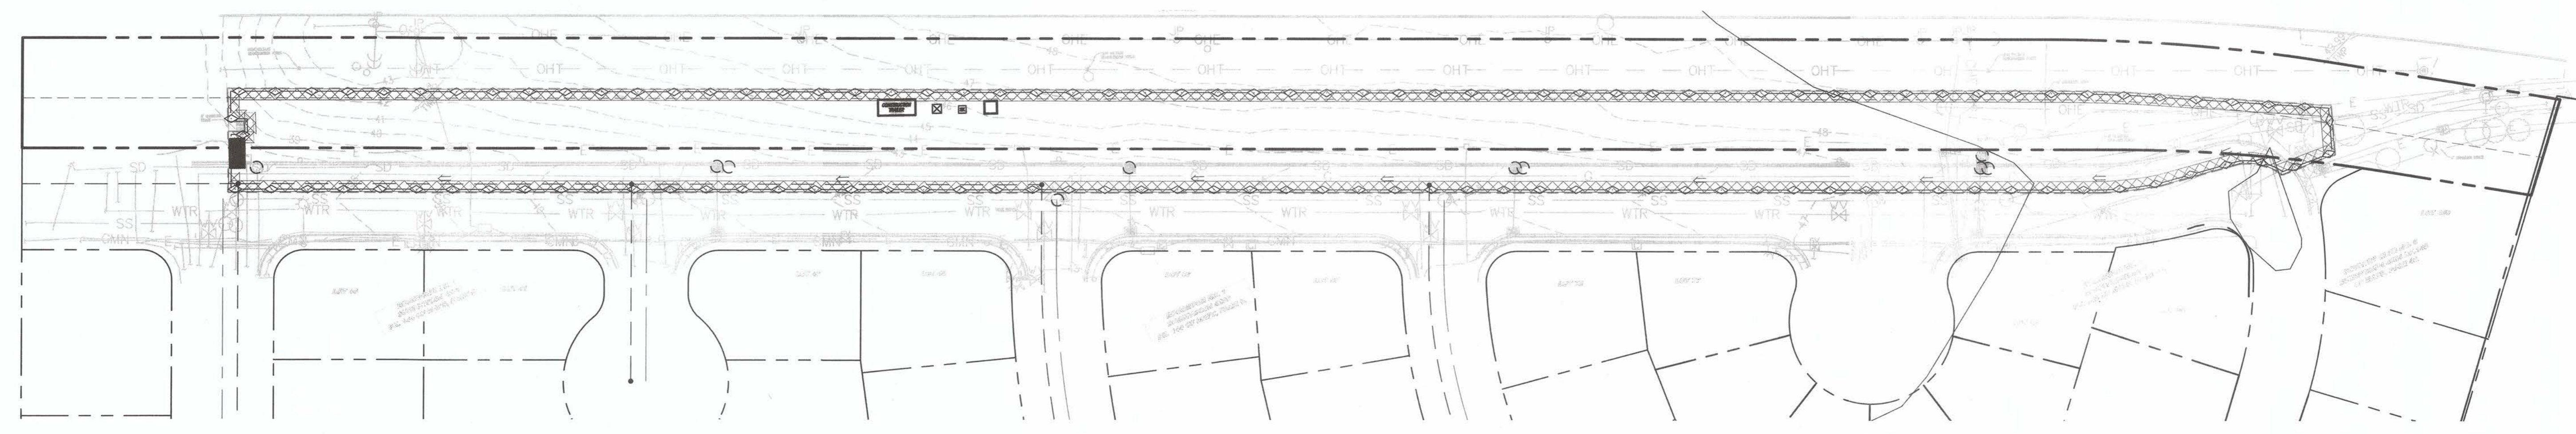

PREPARED UNDER THE DIRECTION OF:
 CHAD J. BROWNING
 R.C.E. NO. 68315
 EXPIRES 9-30-25
 DATE: 9/20/23

ACCEPTED FOR USE:
 JOHN SAMUELSON
 City Engineer
 Date: 9/22/23




**FRONTAGE ROAD
 LIVING GREEN TRAIL DESIGN
 EROSION CONTROL PLAN**
 CONTRACT NAME:
 CONTRACT NUMBER:


BY	DRAWN: CW
DESCRIPTION	CHECKED: SC
REV	REVIEWED: CB
DATE	DATE: 09/05/23
	SCALE: AS NOTED

DATE	
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DESCRIPTION	
BY	


SHEET NO.
 24 OF 59
 DWG. NO.
C-10.0

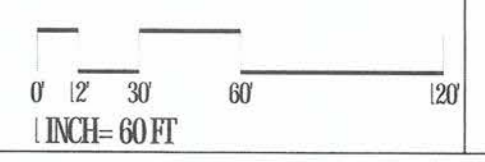


SE-1 Silt Fence

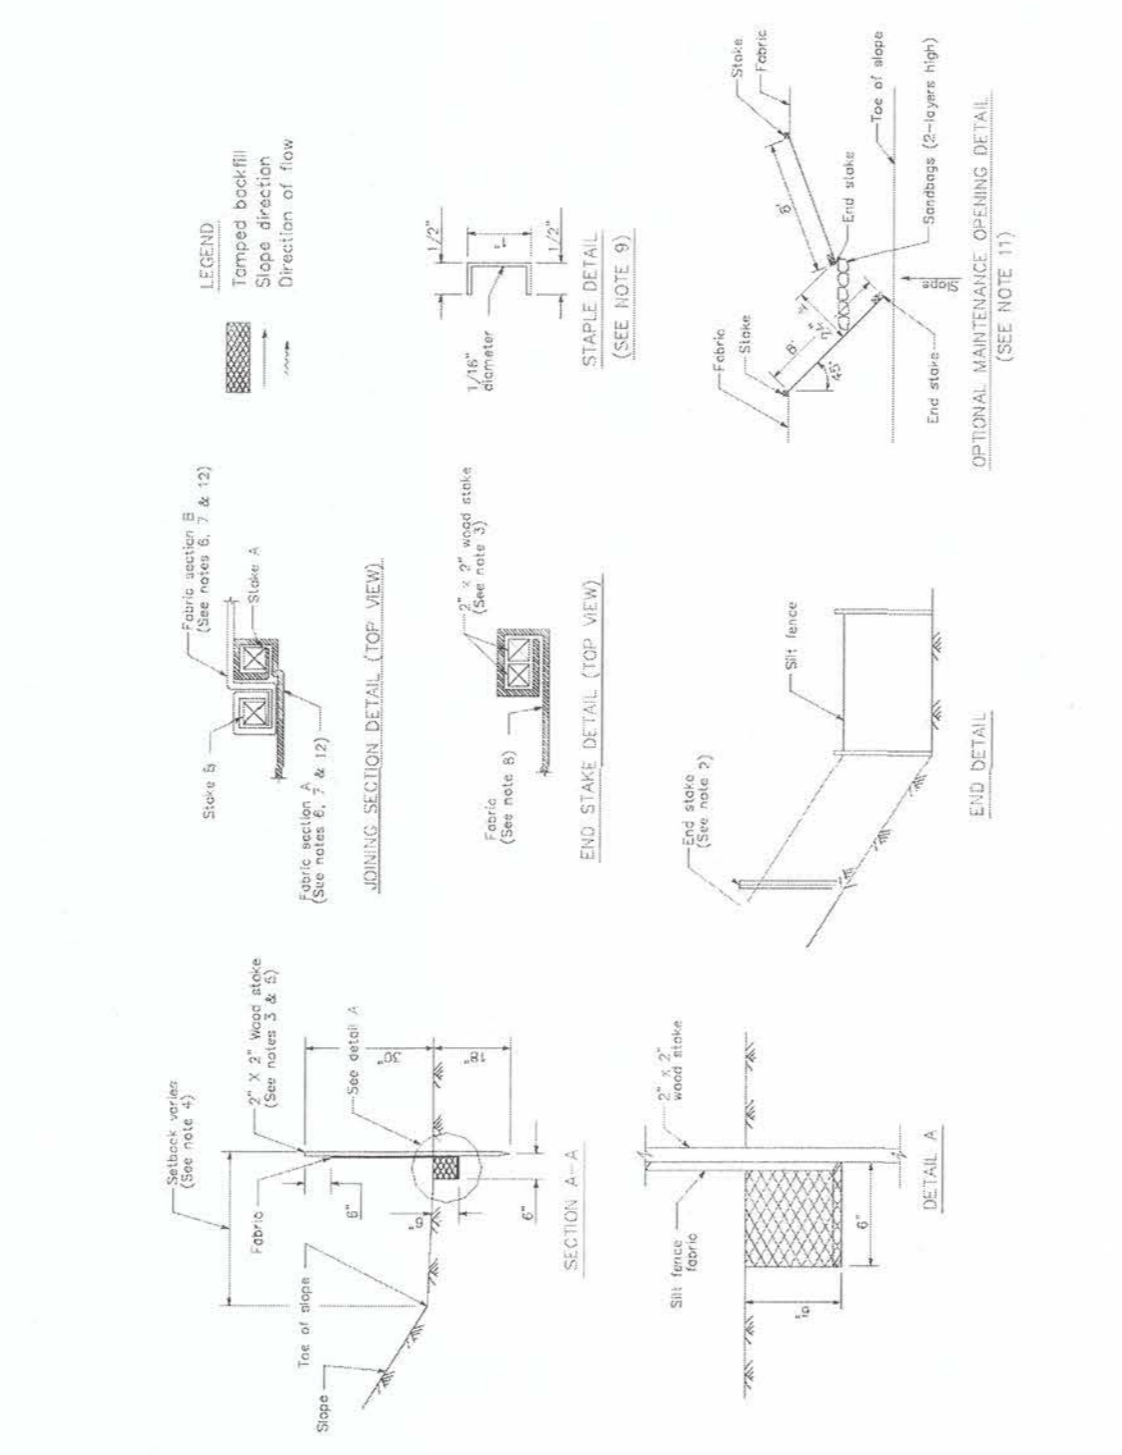


Fiber Rolls SE-5

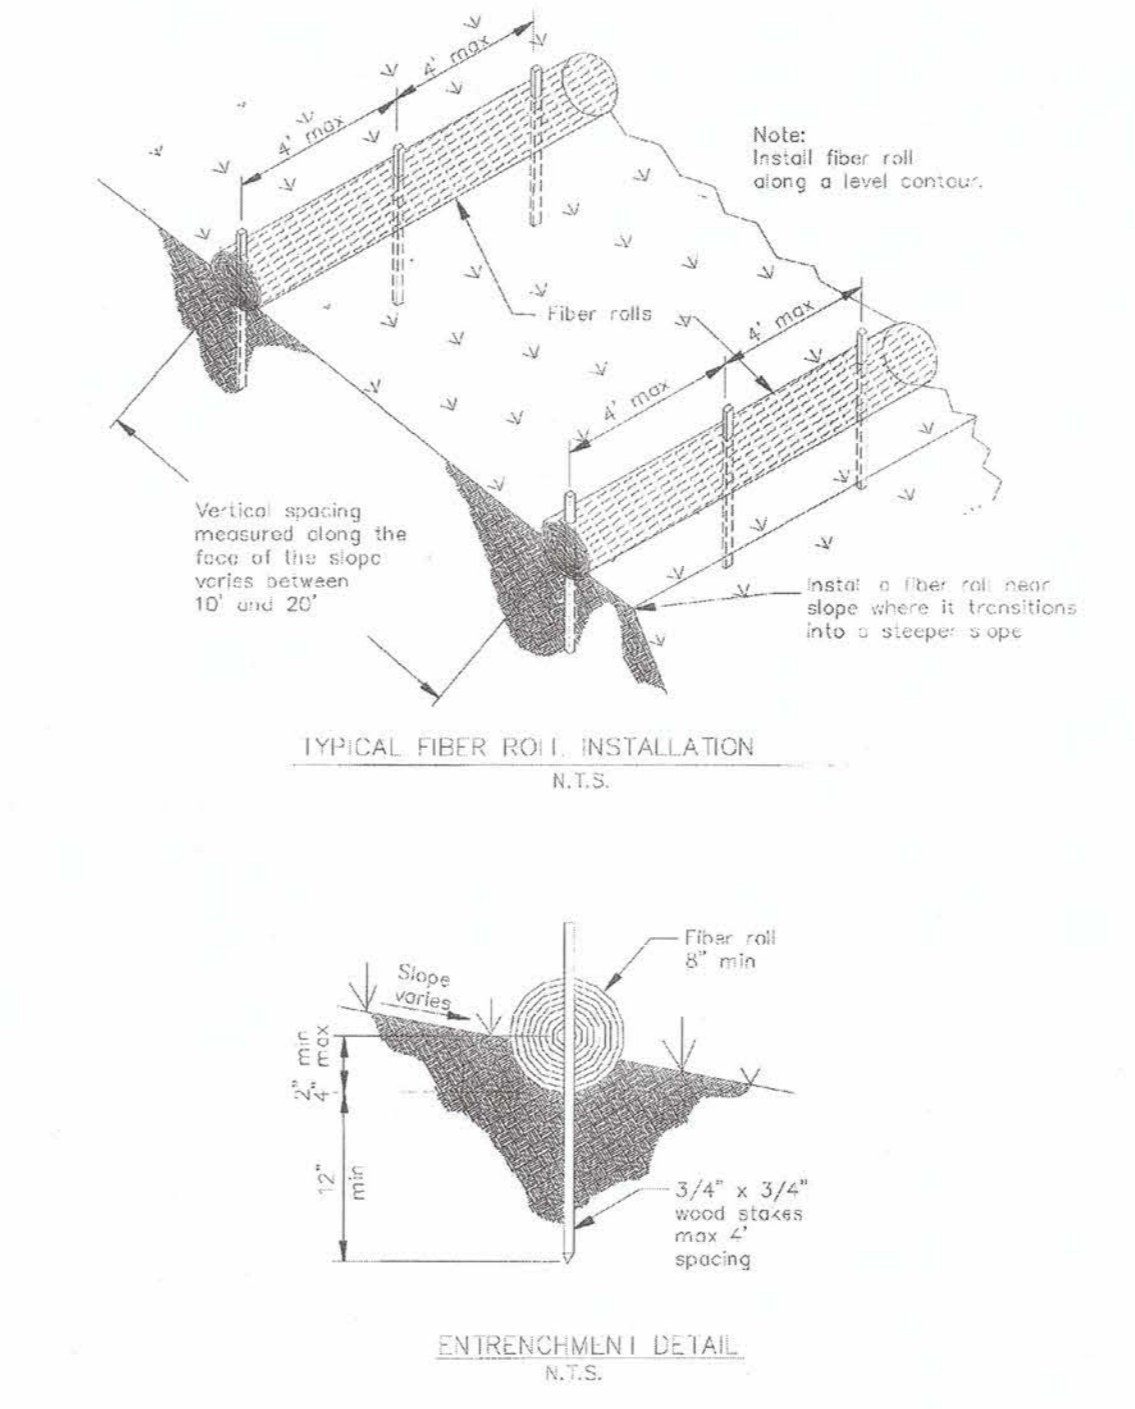

Storm Drain Inlet Protection SE-10

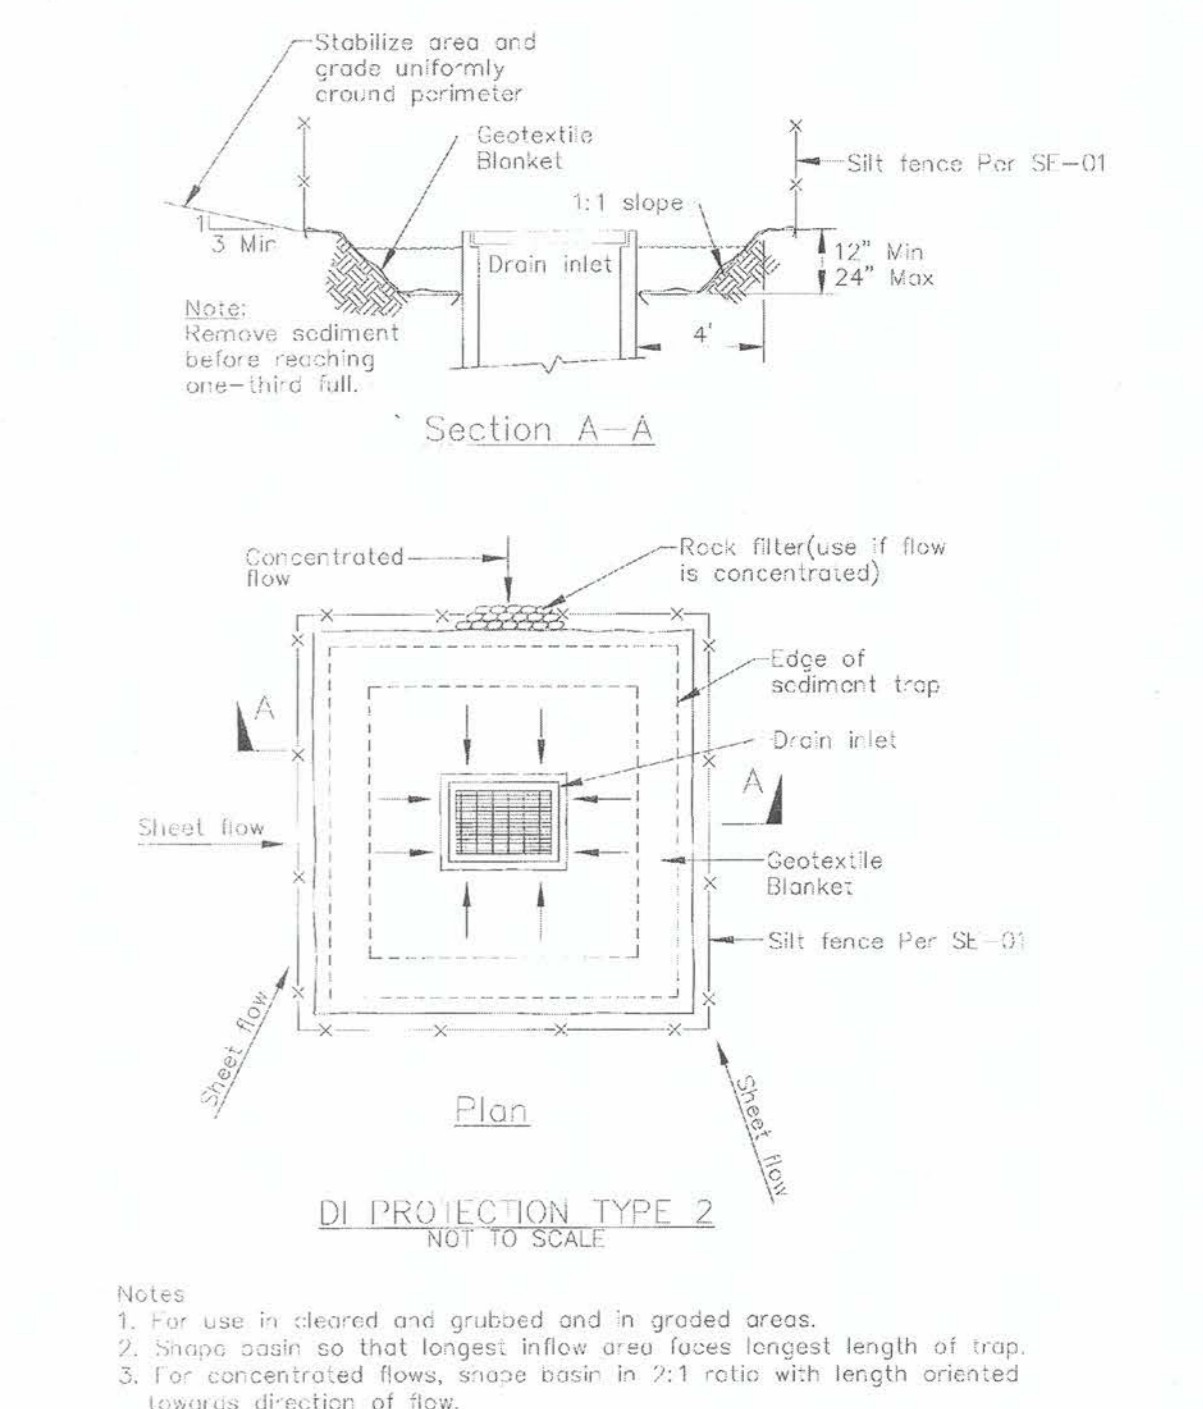

Concrete Waste Management WM-8

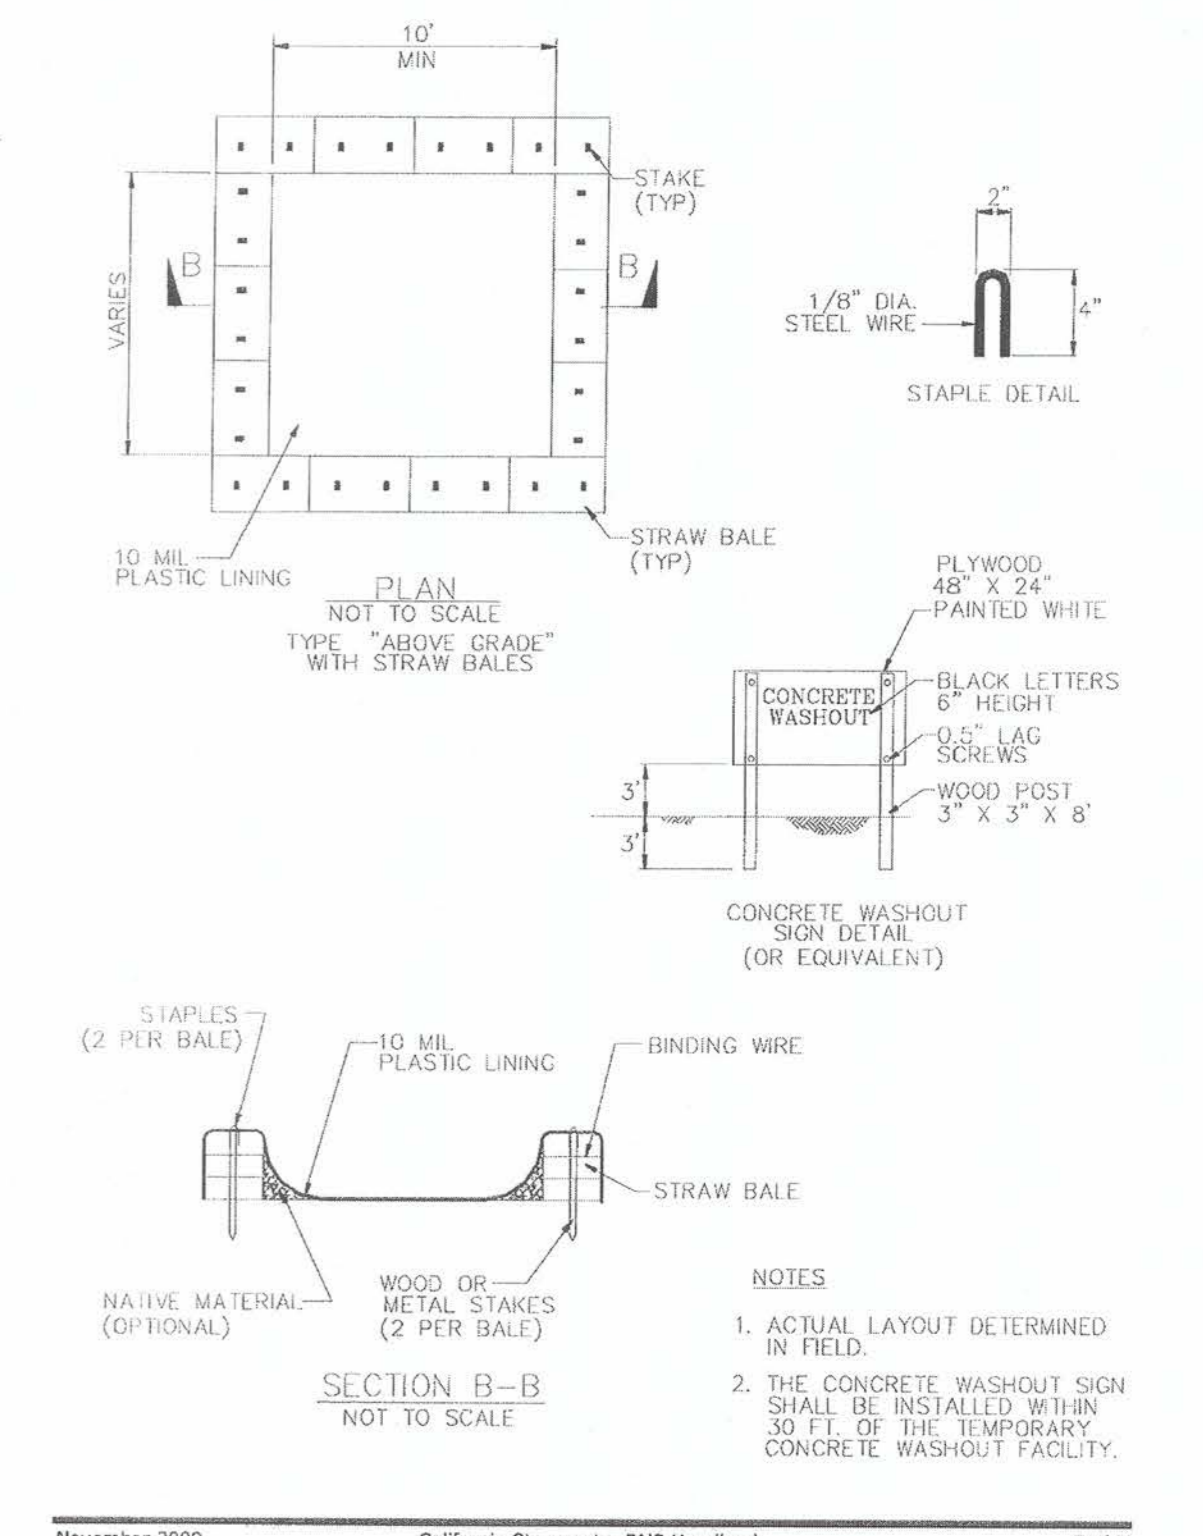

PREPARED UNDER THE DIRECTION OF: **Chad J. Browning** DATE: 9/20/23
 CHAD J. BROWNING R.C.E. NO. 68315 CIVIL EXP. 9-30-25

ACCEPTED FOR USE: **John Samuelson** Date: 9/26/23
 JOHN SAMUELSON City Engineer





FRONTAGE ROAD LIVING GREEN TRAIL DESIGN EROSION CONTROL DETAILS
 CONTRACT NAME: _____ CONTRACT NUMBER: _____

DATE	REV	DESCRIPTION	BY	SCALE

DRAWN: CW
 CHECKED: SC
 REVIEWED: CB
 DATE: 09/05/23
 SCALE: AS NOTED

SHEET NO. 25 OF 59
 DWG. NO. **C-10.1**

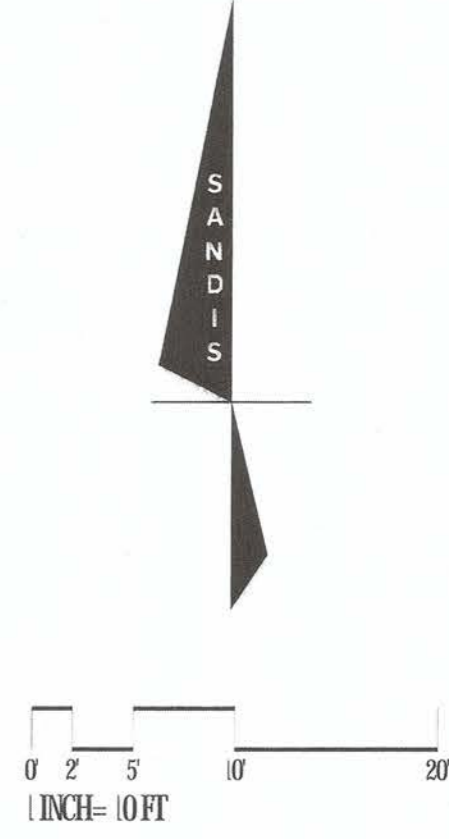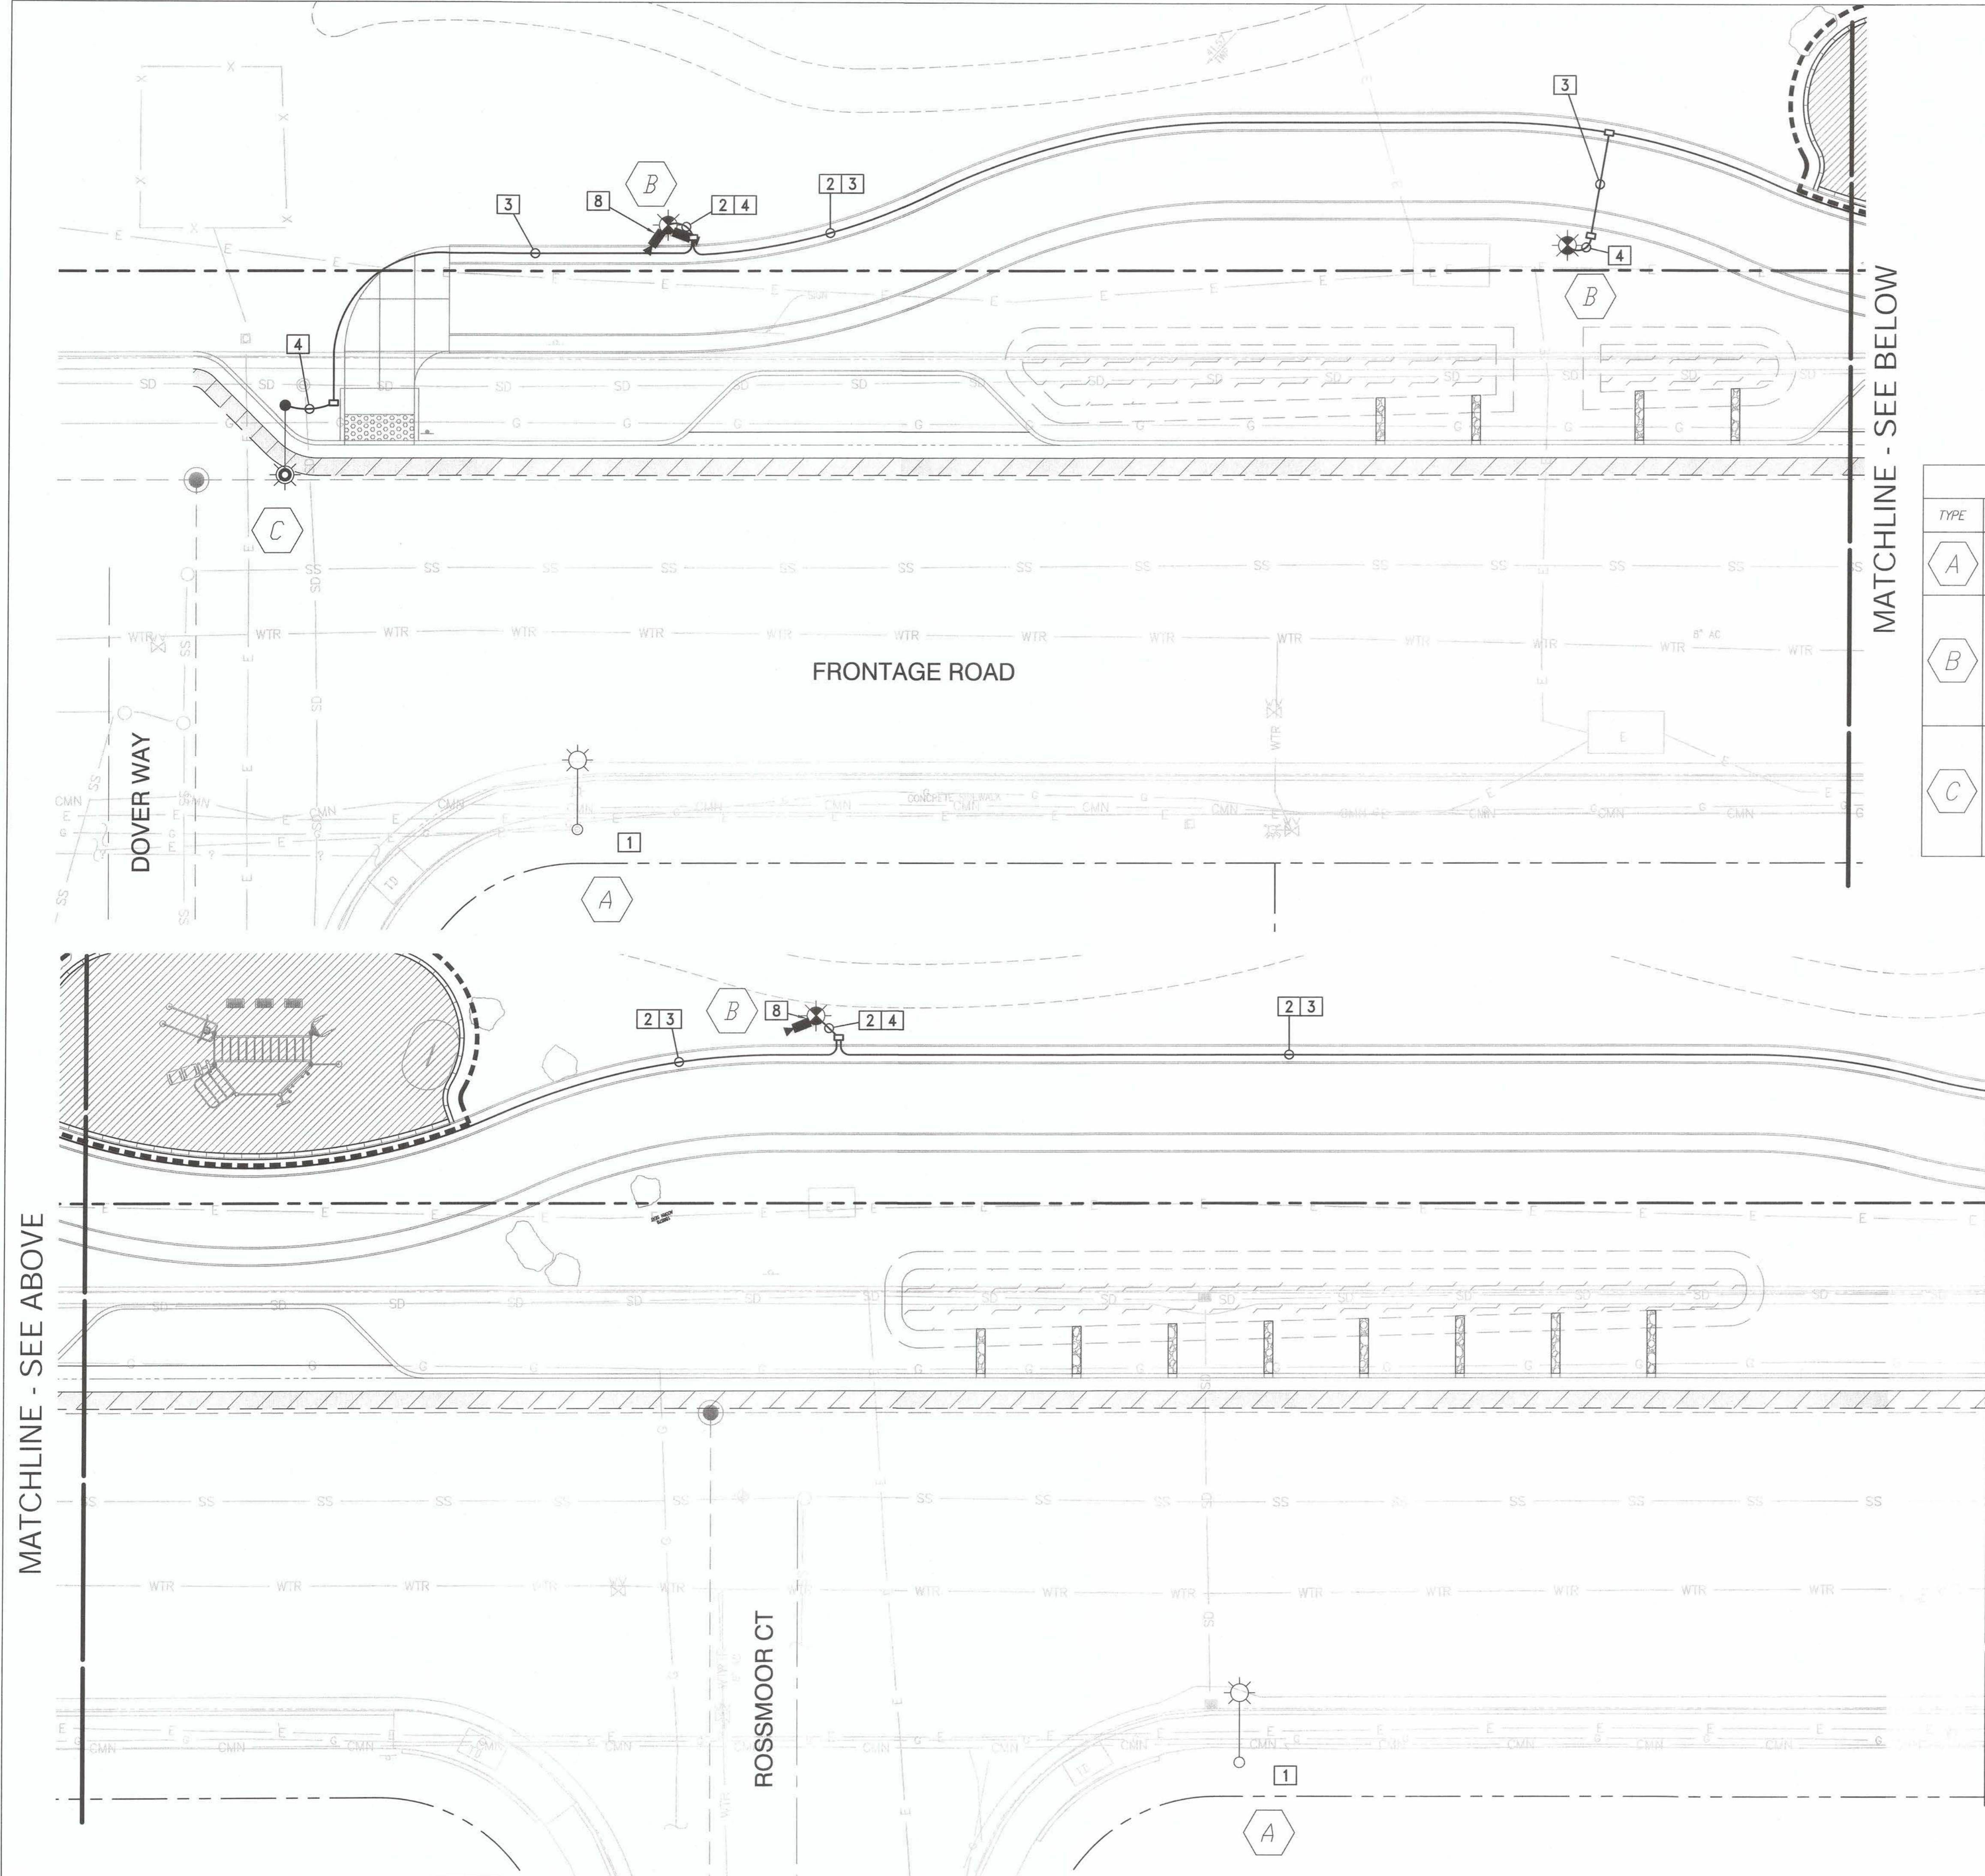

MATCHLINE - SEE BELOW

PROPOSED LIGHTING FIXTURE SCHEDULE

TYPE	SYMBOL	DESCRIPTION	POLE HEIGHT	LAMP	WATTAGE	VOLTAGE	QUANTITY	NOTES
A		EXISTING CREE RSWL SERIES ON EXISTING POLE	32'	LED	29W	120-277	2	-
B		CITY FURNISHED CREE ARE SERIES TYPE 3 ON CITY FURNISHED POLE	20'	LED	67W	120-277	3	CONTRACTOR TO INSTALL CITY FURNISHED LUMINAIRES AND POLES. CONTRACTOR TO PROVIDE NECESSARY COMPONENTS AS NEEDED TO PROVIDE A FUNCTIONAL LIGHTING SYSTEM.
C		CITY FURNISHED CREE RSWL SERIES TYPE 3 ON CITY FURNISHED POLE	32'	LED	47W	120-277	1	CONTRACTOR TO INSTALL CITY FURNISHED LUMINAIRES AND POLES. CONTRACTOR TO PROVIDE NECESSARY COMPONENTS AS NEEDED TO PROVIDE A FUNCTIONAL LIGHTING SYSTEM.

LEGEND

- STREET LIGHT CONDUIT
- PROPOSED ELECTRICAL PULL BOX
- CITY FURNISHED AND INSTALLED CCTV CAMERA

LIGHTING NOTES

- 1 EXISTING LUMINAIRE AND POLE TO REMAIN.
- 2 INSTALL TWO(2) 3/4" CONDUITS FOR CCTV CAMERA COMMUNICATION LINES AND 120 VAC POWER, AS REQUIRED BY THE CITY FOR "CCTV MAKE-READY." ONE(1) POWER CIRCUIT IN THE SERVICE ENCLOSURE SHALL BE DEDICATED TO CAMERA AND COMMUNICATIONS.
- 3 INSTALL 2" CONDUIT WITH 2-#8 AWG CONDUCTOR (SL) AND 1-#8 BARE GROUND WIRE.
- 4 INSTALL 1 1/2" CONDUIT WITH 2-#8 AWG CONDUCTOR (SL) AND 1-#4 BARE COPPER GROUND WIRE.
- 8 CITY TO FURNISH AND INSTALL 2.4MM CCTV CAMERAS ON LIGHT POLE.

ELECTRICAL LIGHTING NOTES

1. ALL WORK SHALL BE DONE IN CONFORMANCE WITH THE LATEST EDITION OF THE CITY OF PITTSBURG STANDARD DETAILS.
2. CONTRACTOR TO CONFIRM EXISTING STREET LIGHT CIRCUITS PRIOR TO CONSTRUCTION.
3. CONTRACTOR SHALL LOCATE AND PROTECT EXISTING UTILITIES FROM DAMAGE UNLESS SPECIFIED OTHERWISE.
4. ALL PULLBOXES SHALL BE SIZE #5 UNLESS SPECIFIED OTHERWISE.

MATCHLINE - SEE ABOVE

MATCHLINE - SEE SHEET C-10.1



PREPARED UNDER THE DIRECTION OF:

 CHAD J. BROWNING
 P.E. No. 68315
 EXPIRES 9-30-25

ACCEPTED FOR USE:

 JOHN SAMUELSON
 City Engineer
 Date: 9/26/23




**FRONTAGE ROAD
 LIVING GREEN TRAIL DESIGN
 LIGHTING PLAN**
 CONTRACT NAME:
 CONTRACT NUMBER:

BY	DRAWN: CW	CHECKED: SC	REVIEWED: CB	DATE: 09/05/23	SCALE: AS NOTED
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DATE	REV	DESCRIPTION

SHEET NO.
26 OF 59
 DWG. NO.
C-11.0

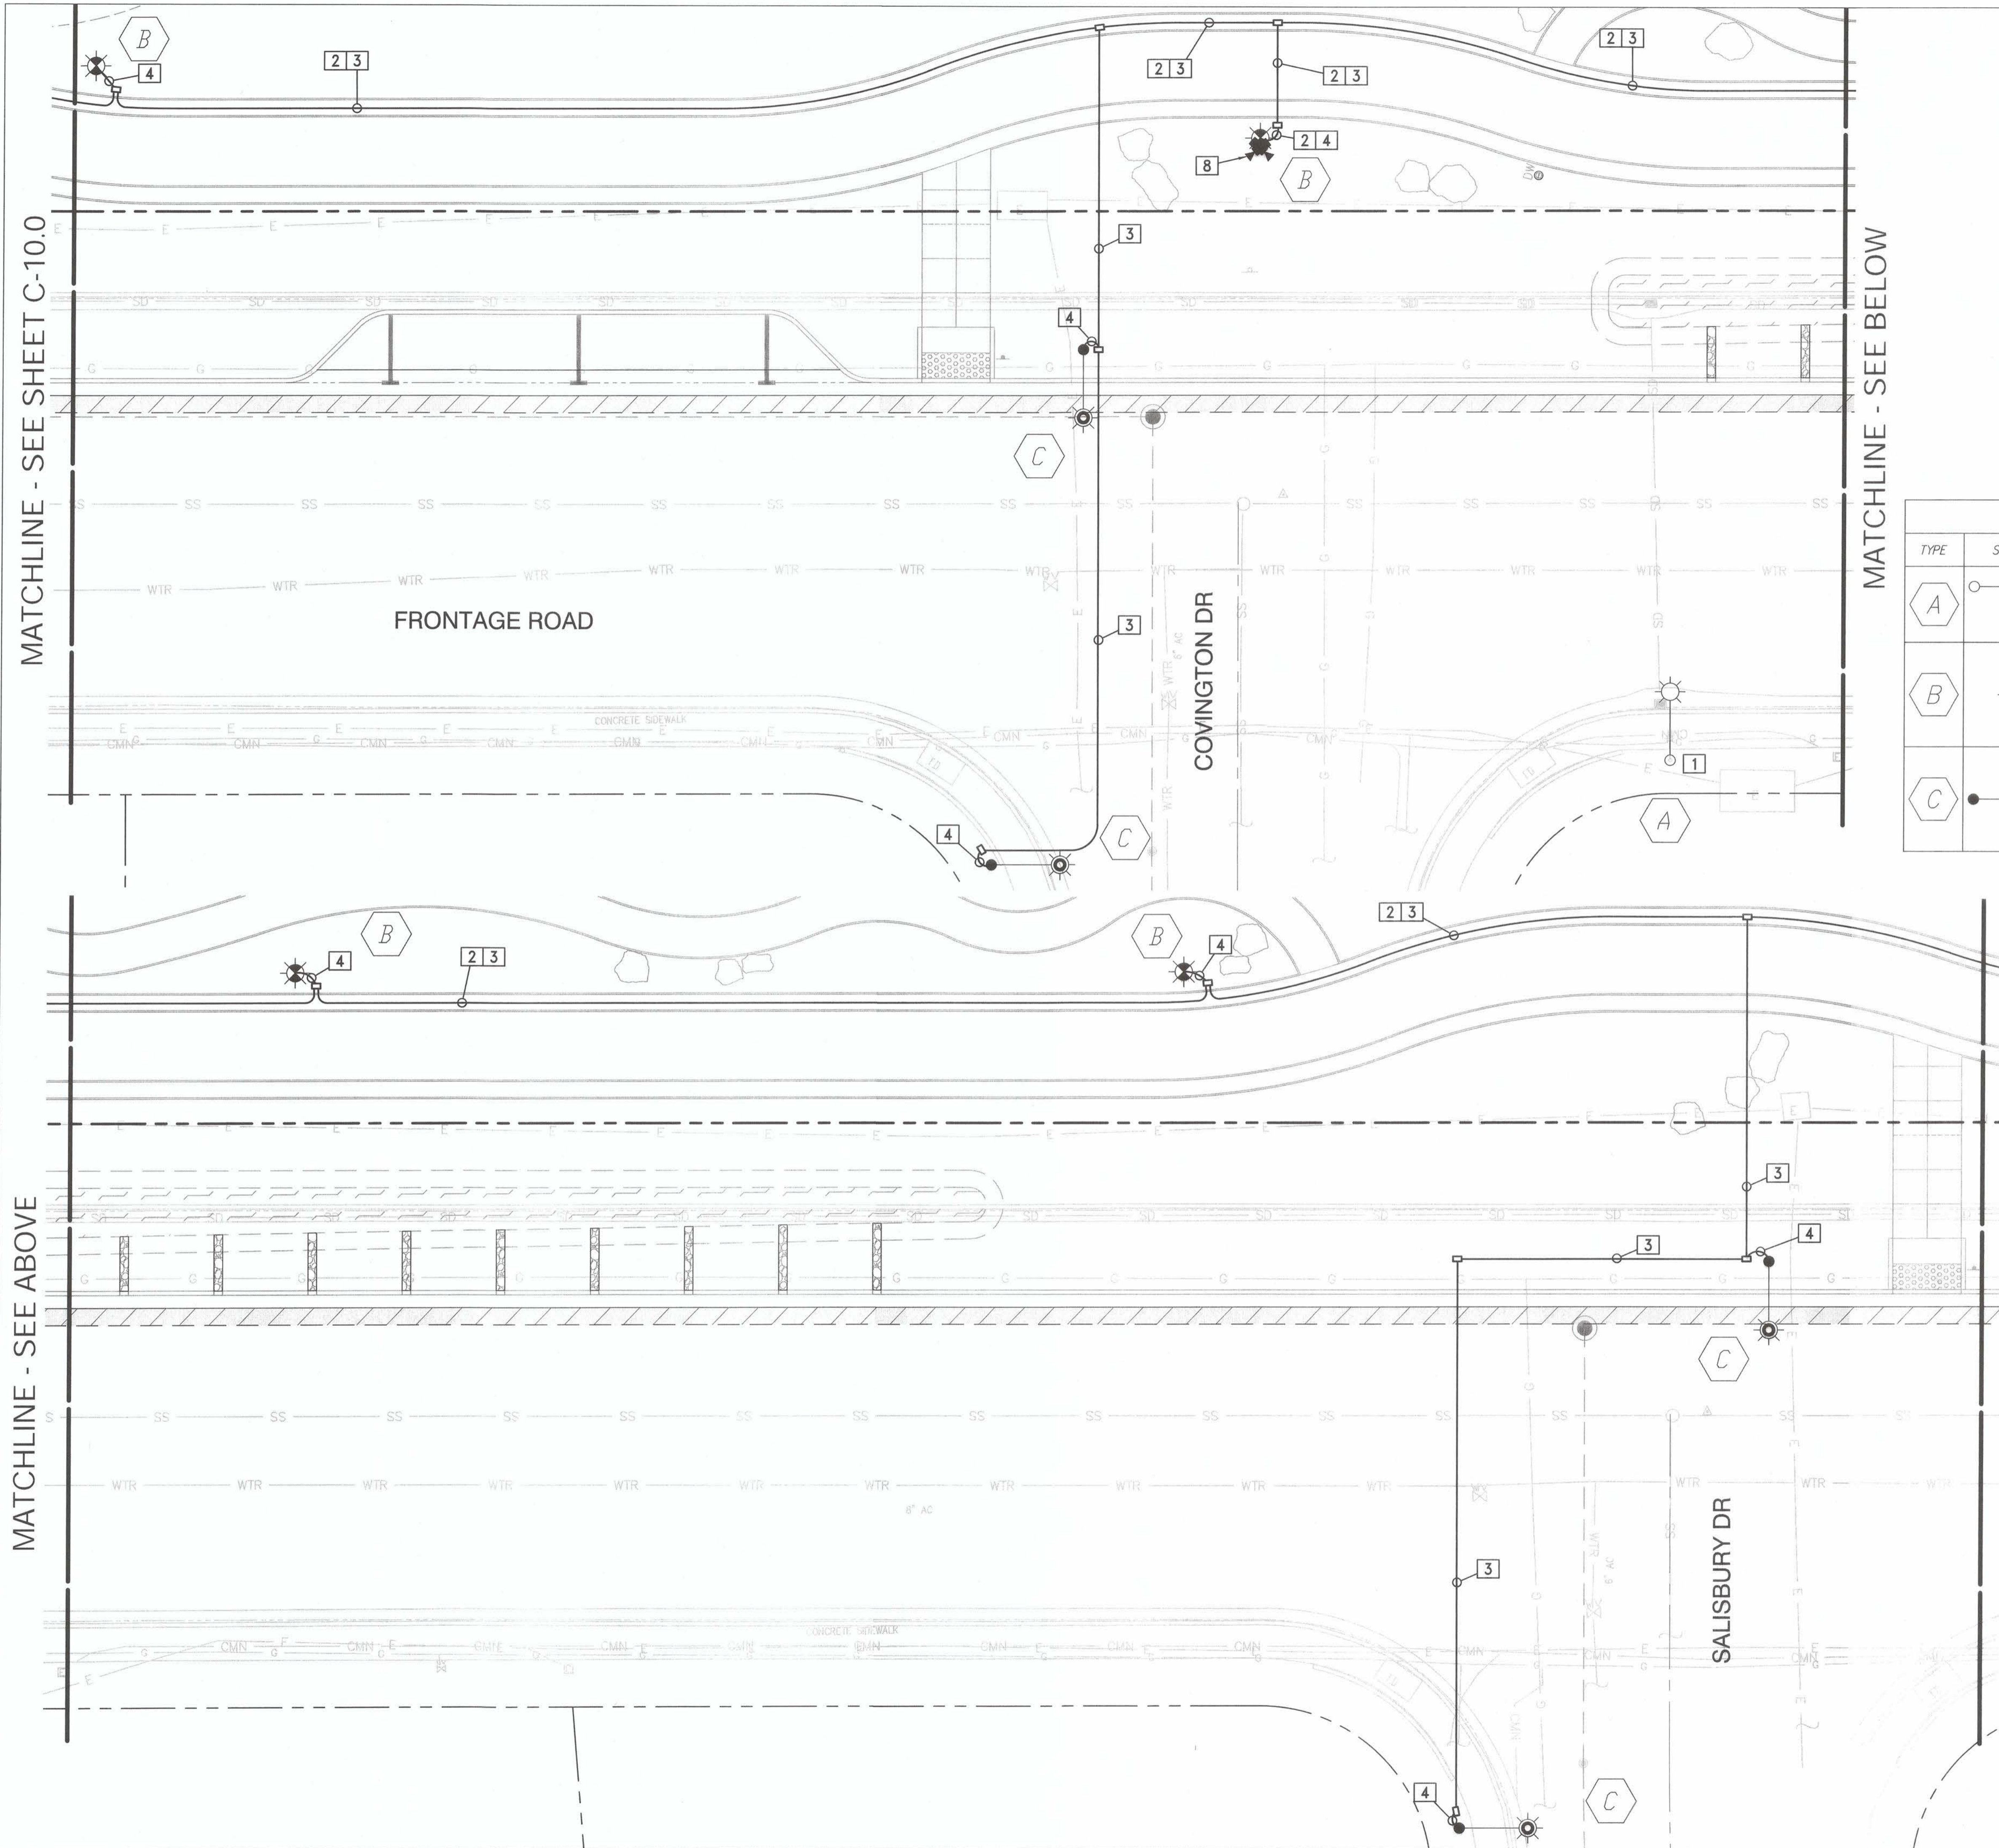


MATCHLINE - SEE SHEET C-10.0

MATCHLINE - SEE ABOVE

MATCHLINE - SEE BELOW

MATCHLINE - SEE SHEET C-10.2

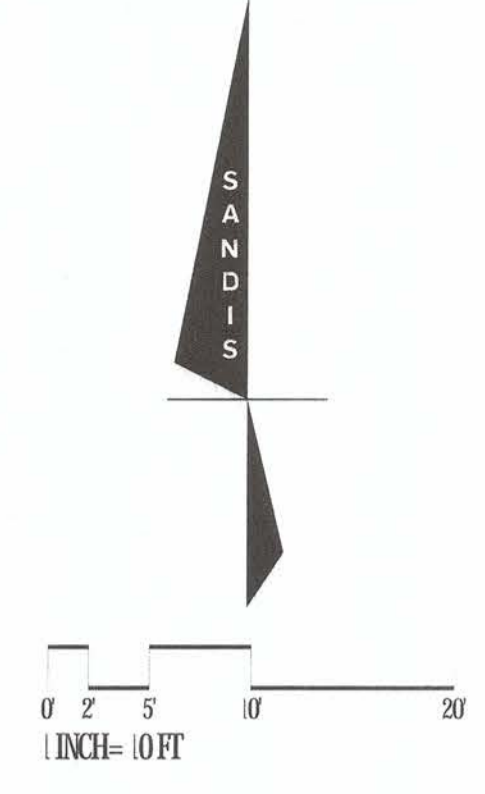

PROPOSED LIGHTING FIXTURE SCHEDULE								
TYPE	SYMBOL	DESCRIPTION	POLE HEIGHT	LAMP	WATTAGE	VOLTAGE	QUANTITY	NOTES
A		EXISTING CREE RSWL SERIES ON EXISTING POLE	32'	LED	29W	120-277	1	-
B		CITY FURNISHED CREE RSWL SERIES TYPE 3 ON CITY FURNISHED POLE	20'	LED	67W	120-277	4	CONTRACTOR TO INSTALL CITY FURNISHED LUMINAIRES AND POLES. CONTRACTOR TO PROVIDE NECESSARY COMPONENTS AS NEEDED TO PROVIDE A FUNCTIONAL LIGHTING SYSTEM.
C		CITY FURNISHED CREE RSWL SERIES TYPE 3 ON CITY FURNISHED POLE	32'	LED	47W	120-277	4	CONTRACTOR TO INSTALL CITY FURNISHED LUMINAIRES AND POLES. CONTRACTOR TO PROVIDE NECESSARY COMPONENTS AS NEEDED TO PROVIDE A FUNCTIONAL LIGHTING SYSTEM.

LEGEND


- STREET LIGHT CONDUIT
- PROPOSED ELECTRICAL PULL BOX
- CITY FURNISHED AND INSTALLED CCTV CAMERA

LIGHTING NOTES

- 1 EXISTING LUMINAIRE AND POLE TO REMAIN.
- 2 INSTALL TWO(2) 3/4" CONDUITS FOR CCTV CAMERA COMMUNICATION LINES AND 120 VAC POWER, AS REQUIRED BY THE CITY FOR "CCTV MAKE-READY." ONE(1) POWER CIRCUIT IN THE SERVICE ENCLOSURE SHALL BE DEDICATED TO CAMERA AND COMMUNICATIONS.
- 3 INSTALL 2" CONDUIT WITH 2-#8 AWG CONDUCTOR (SL) AND 1-#8 BARE GROUND WIRE.
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- 8 CITY TO FURNISH AND INSTALL 2.4MM CCTV CAMERAS ON LIGHT POLE.

ELECTRICAL LIGHTING NOTES

1. ALL WORK SHALL BE DONE IN CONFORMANCE WITH THE LATEST EDITION OF THE CITY OF PITTSBURGH STANDARD DETAILS.
2. CONTRACTOR TO CONFIRM EXISTING STREET LIGHT CIRCUITS PRIOR TO CONSTRUCTION.
3. CONTRACTOR SHALL LOCATE AND PROTECT EXISTING UTILITIES FROM DAMAGE UNLESS SPECIFIED OTHERWISE.
4. ALL PULLBOXES SHALL BE SIZE #5 UNLESS SPECIFIED OTHERWISE.

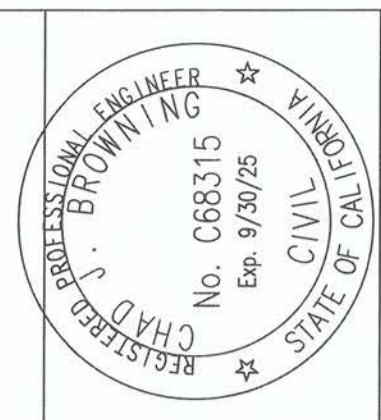

PREPARED UNDER THE DIRECTION OF:

 CHAD J. BROWNING
 R.C.E. NO. 68315
 EXPIRES 9-30-25

ACCEPTED FOR USE:

 JOHN SAMUELSON
 City Engineer
 Date: 9/26/23





**FRONTAGE ROAD
 LIVING GREEN TRAIL DESIGN
 LIGHTING PLAN**
 CONTRACT NAME:
 CONTRACT NUMBER:

BY	DRAWN: CW
CHECKED: SC	
REVIEWED: CB	
DATE: 09/05/23	
SCALE: AS NOTED	

DATE	REV	DESCRIPTION

SHEET NO.
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 DWG. NO.
C-111

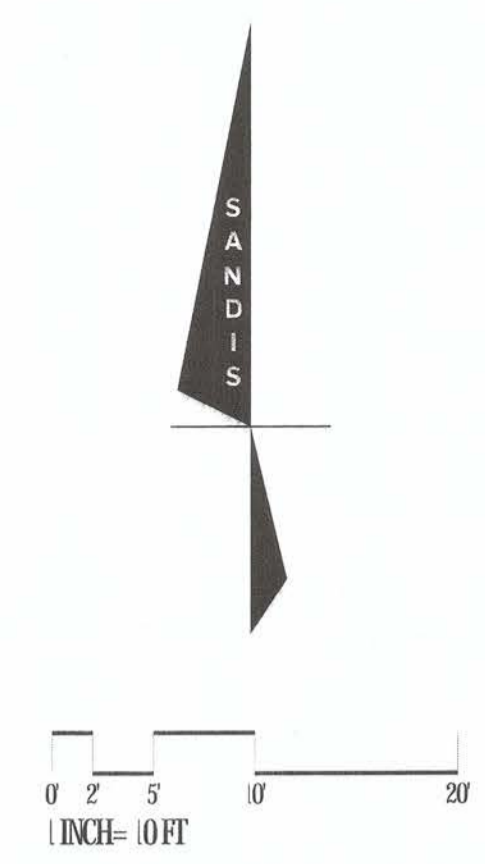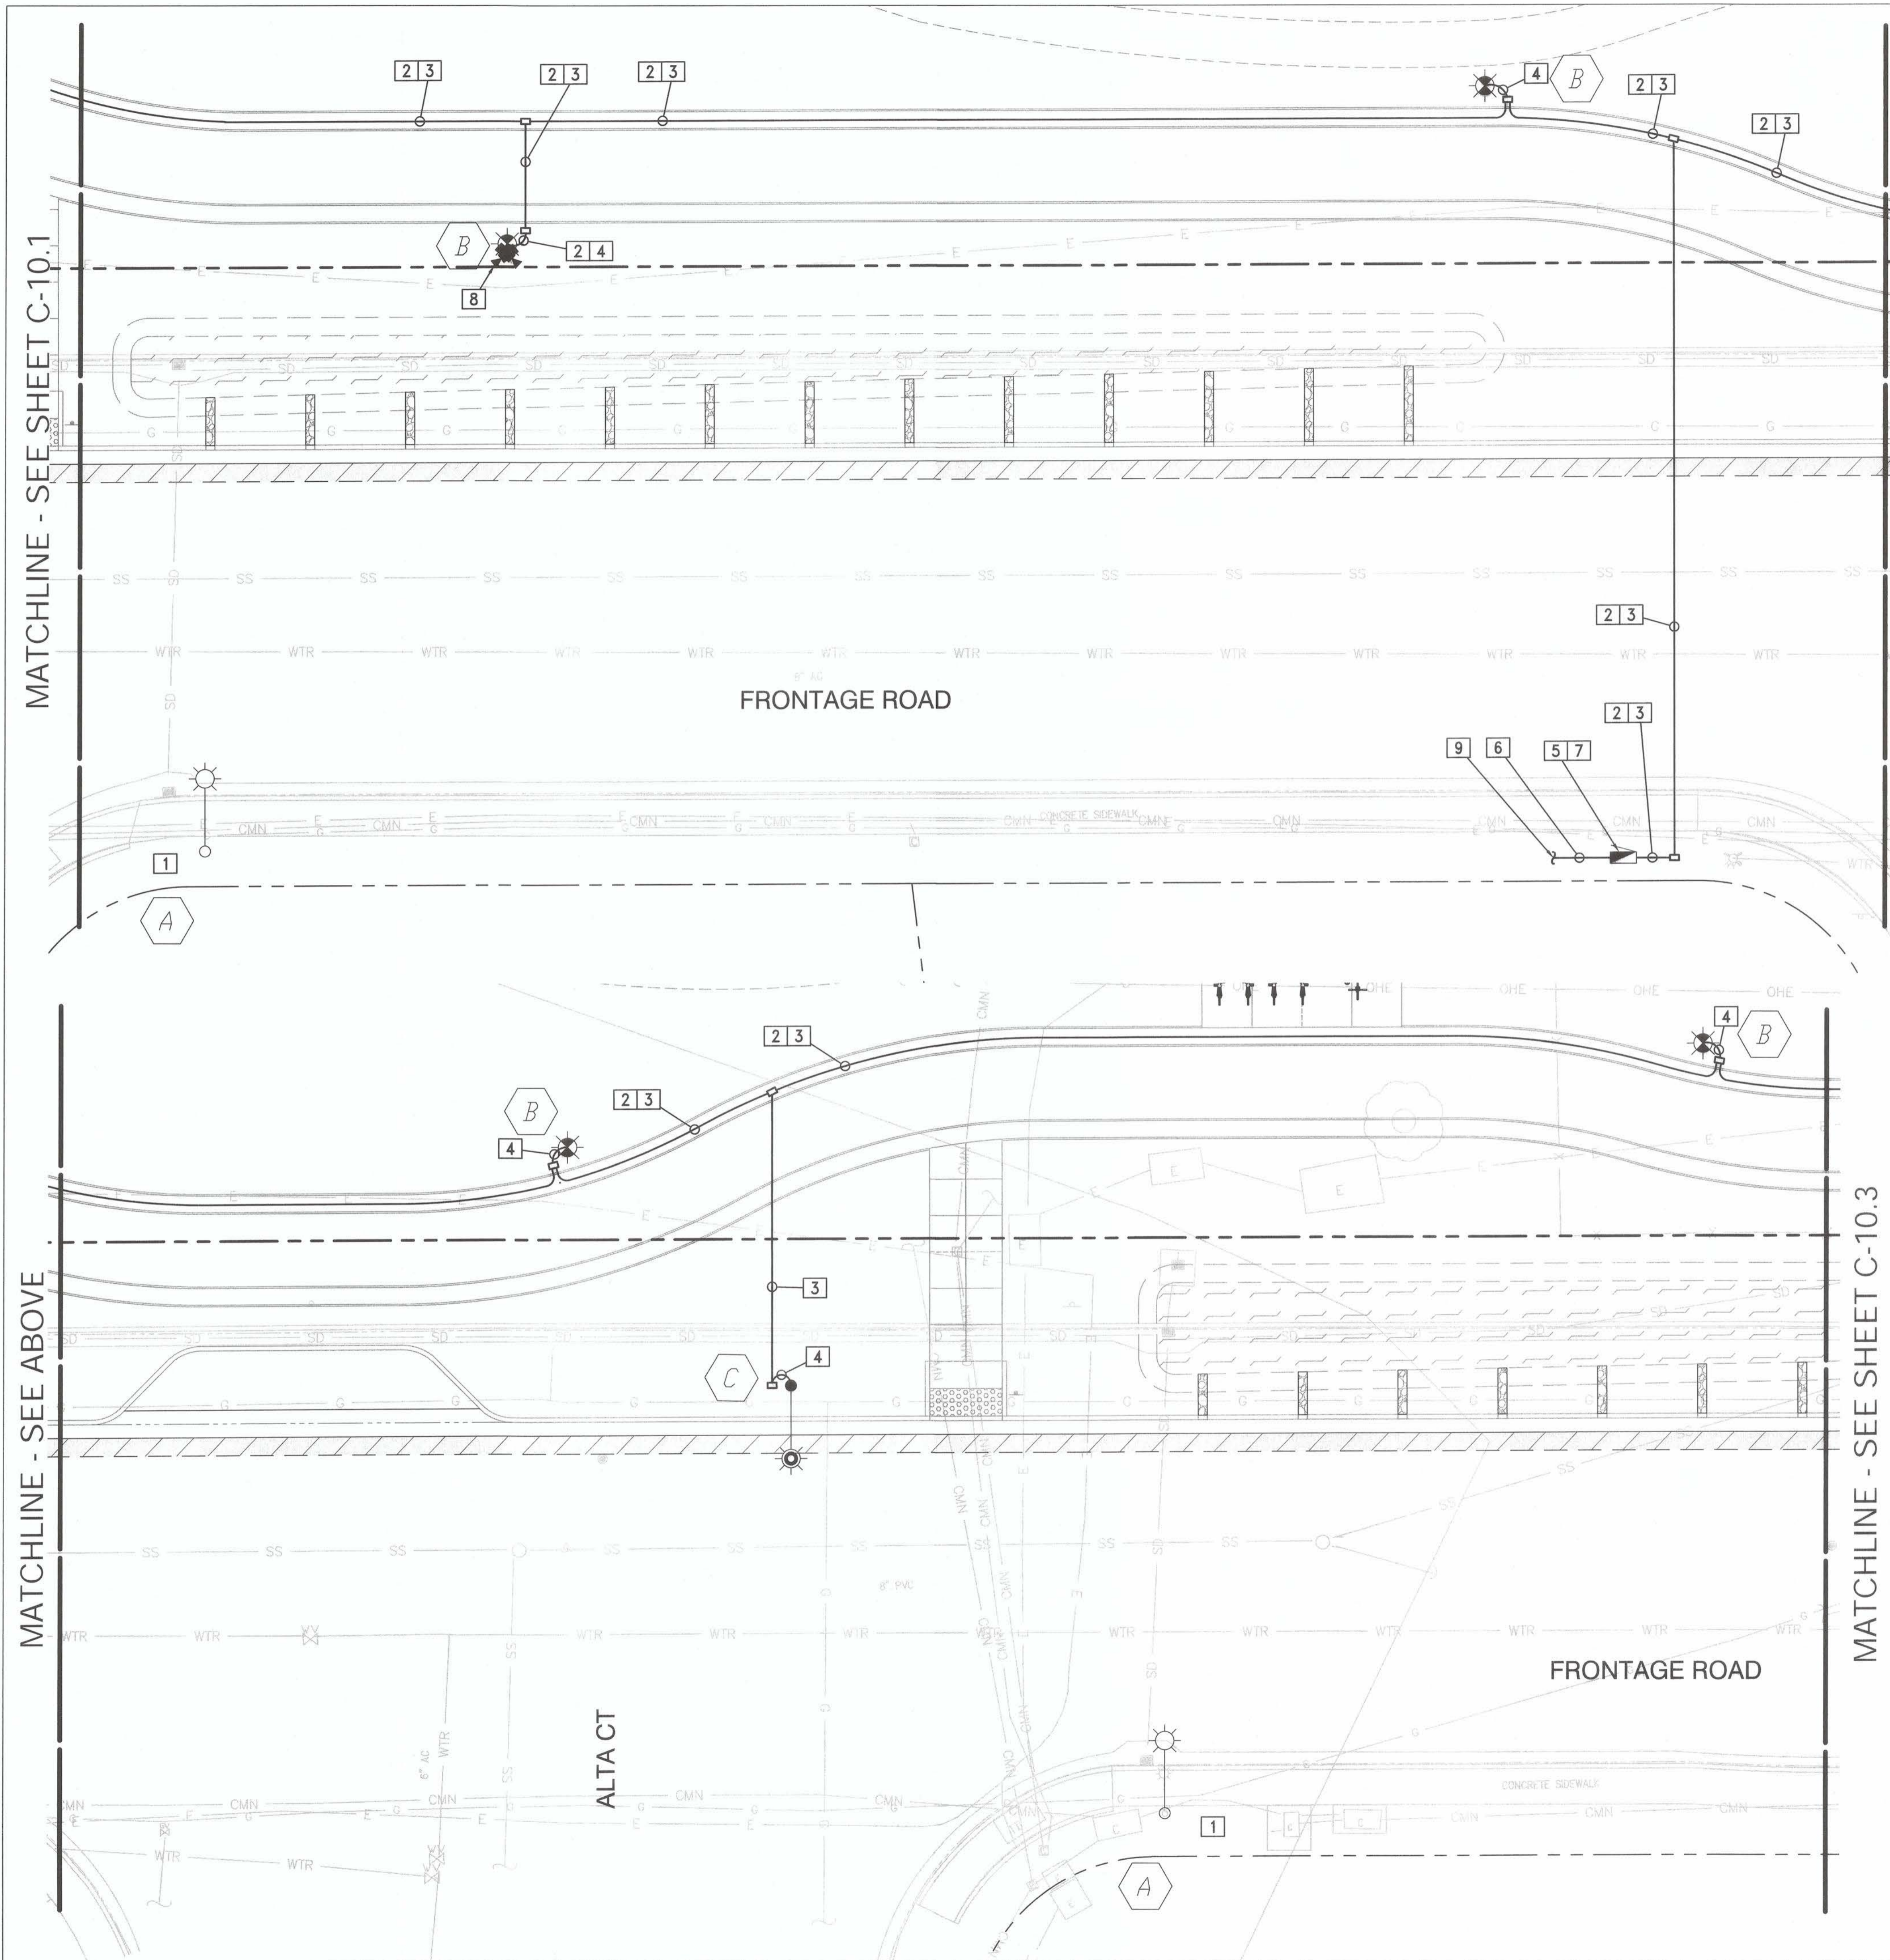

PROPOSED LIGHTING FIXTURE SCHEDULE

TYPE	SYMBOL	DESCRIPTION	POLE HEIGHT	LAMP	WATTAGE	VOLTAGE	QUANTITY	NOTES
A		EXISTING CREE RSWL SERIES ON EXISTING POLE	32'	LED	29W	120-277	2	-
B		CITY FURNISHED CREE ARE SERIES TYPE 3 ON CITY FURNISHED POLE	20'	LED	67W	120-277	4	CONTRACTOR TO INSTALL CITY FURNISHED LUMINAIRES AND POLES. CONTRACTOR TO PROVIDE NECESSARY COMPONENTS AS NEEDED TO PROVIDE A FUNCTIONAL LIGHTING SYSTEM.
C		CITY FURNISHED CREE RSWL SERIES TYPE 3 ON CITY FURNISHED POLE	32'	LED	47W	120-277	1	CONTRACTOR TO INSTALL CITY FURNISHED LUMINAIRES AND POLES. CONTRACTOR TO PROVIDE NECESSARY COMPONENTS AS NEEDED TO PROVIDE A FUNCTIONAL LIGHTING SYSTEM.

LEGEND


- STREET LIGHT CONDUIT
- PROPOSED ELECTRICAL PULL BOX
- CITY FURNISHED AND INSTALLED CCTV CAMERA
- TYPE III-AF SERVICE CABINET

LIGHTING NOTES

- 1 EXISTING LUMINAIRE AND POLE TO REMAIN.
- 2 INSTALL TWO(2) 3/4" CONDUITS FOR CCTV CAMERA COMMUNICATION LINES AND 120 VAC POWER, AS REQUIRED BY THE CITY FOR "CCTV MAKE-READY". ONE(1) POWER CIRCUIT IN THE SERVICE ENCLOSURE SHALL BE DEDICATED TO CAMERA AND COMMUNICATIONS.
- 3 INSTALL 2" CONDUIT WITH 2-#8 AWG CONDUCTOR (SL) AND 1-#8 BARE GROUND WIRE.
- 4 INSTALL 1 1/2" CONDUIT WITH 2-#8 AWG CONDUCTOR (SL) AND 1#4 BARE COPPER GROUND WIRE.
- 5 INSTALL TYPE III-AF SERVICE EQUIPMENT ENCLOSURE PER CALTRANS SHEET ES-2D WITH LIGHTING CIRCUIT, IRRIGATION CIRCUIT, AND CCTV AND COMMUNICATIONS CIRCUIT. SEE WIRING DIAGRAM ON SHEET E-4 FOR REFERENCE.
- 6 INSTALL 3" CONDUIT FOR PG&E SECONDARY LINE. CONNECT SECONDARY LINE TO PG&E POINT OF CONNECTION PER PG&E INSTRUCTION.
- 7 CITY TO FURNISH AND INSTALL WIRELESS RADIO LINK TO CONNECT CCTV CAMERAS BACK TO CITY HALL.
- 8 CITY TO FURNISH AND INSTALL 2.4MM CCTV CAMERAS ON LIGHT POLE.
- 9 COORDINATE WITH PG&E FOR POC AND SERVICE LOCATION BASED ON THE CITY PROVIDED PG&E APPLICATION.

ELECTRICAL LIGHTING NOTES

1. ALL WORK SHALL BE DONE IN CONFORMANCE WITH THE LATEST EDITION OF THE CITY OF PITTSBURGH STANDARD DETAILS.
2. CONTRACTOR TO CONFIRM EXISTING STREET LIGHT CIRCUITS PRIOR TO CONSTRUCTION.
3. CONTRACTOR SHALL LOCATE AND PROTECT EXISTING UTILITIES FROM DAMAGE UNLESS SPECIFIED OTHERWISE.
4. ALL PULLBOXES SHALL BE SIZE #5 UNLESS SPECIFIED OTHERWISE.

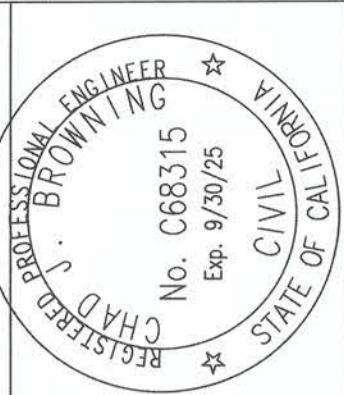

PREPARED UNDER THE DIRECTION OF:

 CHAD J. BROWNING
 R.C.E. NO. 68315
 DATE: 9/20/23
 EXPIRES 9-30-25

ACCEPTED FOR USE:

 JOHN SAMUELSSON
 City Engineer
 Date: 9/26/23



**FRONTAGE ROAD
 LIVING GREEN TRAIL DESIGN
 LIGHTING PLAN**

CONTRACT NAME:
 CONTRACT NUMBER:

DATE	REV	DESCRIPTION	BY	DRAWN: CW	CHECKED: SC	REVIEWED: CB	DATE: 09/05/23	SCALE: AS NOTED

SHEET NO.
28 OF 59
 DWG. NO.
C-11.2

LAYOUT NOTES

- CONTRACTOR SHALL VERIFY ALL UTILITIES, GRADES, EXISTING CONDITIONS AND DIMENSIONS IN THE FIELD PRIOR TO COMMENCING WORK. ALL DISCREPANCIES OR QUESTIONS SHALL BE BROUGHT TO THE ATTENTION OF THE LANDSCAPE ARCHITECT FOR RESOLUTION.
- ALL WRITTEN DIMENSIONS SUPERCEDE ALL SCALED DISTANCES AND DIMENSIONS. DIMENSIONS SHOWN ARE FROM THE FACE OF THE BUILDING, WALL, BACK OF CURB, EDGE OF WALK, PROPERTY LINE, OR CENTERLINE OF COLUMN UNLESS OTHERWISE NOTED ON THE DRAWINGS.
- ALL DIMENSIONS AT ROADWAY ARE TO FACE OF CURB.
- ALL ANGLES ARE 45 DEGREE, 90 DEGREE, OR 135 DEGREE UNLESS OTHERWISE NOTED.
- ALL CURVES AND ALL TRANSITIONS BETWEEN CURVES AND STRAIGHT EDGES SHALL BE SMOOTH.
- ALL RETURN RADII AND CURB DATA ARE TO FACE OF CURB.
- SCORE LINES IN SIDEWALKS SHALL BE SPACED TO EQUAL THE WIDTH OF THE WALKWAY, UNLESS OTHERWISE SHOWN. EXPANSION JOINTS IN SIDEWALKS SHALL BE 20' ON CENTER MAXIMUM.
- SIDEWALK, CURB AND GUTTER, GRADING AND DRAINAGE IS BASED ON DRAWINGS PREPARED BY THE CIVIL ENGINEER.
- STATIONING HEREON IS ALONG CONSTRUCTION CENTERLINE UNLESS OTHERWISE SHOWN OR INDICATED.
- ANY EXTRA CONSTRUCTION STAKING NECESSITATED SOLELY BY THE CONTRACTOR'S NEGLIGENCE WILL BE CHARGED TO THE CONTRACTOR ON A TIME AND EXPENSES BASIS AND PAID FOR BY THE CONTRACTOR.
- SEE IRRIGATION DRAWINGS FOR GENERAL SYSTEM REQUIREMENTS AND FOR LOCATION OF IRRIGATION MAINLINE PIPING. SLEEVES TO ACCOMMODATE IRRIGATION PIPING, SIZED AS NEEDED, SHALL BE IN PLACE UNDER AND THROUGH SLABS AND WALLS, PRIOR TO POURING.
- PROVIDE CONTINUOUS HEADERS AT THE EDGES OF ALL AC PAVING, SHRUB AREAS, LAWN AREAS, DECOMPOSED GRANITE WHERE IT IS NOT CONSTRAINED BY A CONCRETE PAVING OR MOW BAND.
- ALL CONCRETE PAVEMENTS SHALL BE DOWELED INTO CURBS, SIDEWALKS, AND BUILDING FOUNDATIONS.
- REFER TO GEOTECHNICAL REPORT FOR ADDITIONAL INFORMATION, SECTIONS, REINFORCEMENT, AND PREPARATION. IN CASE OF DISCREPANCY THE GEOTECHNICAL REPORT SHALL GOVERN.
- ALL TYPICAL DETAILS SHALL APPLY UNLESS NOTED OTHERWISE.
- ANY AND ALL WORK WITHIN PITTSBURG RIGHT OF WAY SHALL CONFORM TO ALL PITTSBURG STANDARD DETAILS AND SPECIFICATIONS.
- CONCRETE FOOTINGS INSTALLED FOR ALL SITE FURNISHINGS, SPORTS EQUIPMENT, ETC. IN DECORATIVE PAVEMENT, ASPHALT PAVING, DECOMPOSED GRANITE, CONCRETE PAVING, AND PLANTERS SHALL BE HELD BELOW GRADE.
- ALL EXISTING ITEMS TO REMAIN SHALL BE PROTECTED AS REQUIRED. ANY DAMAGED ITEMS SHALL BE FULLY REPAIRED OR REPLACED AT THE CONTRACTOR'S EXPENSE TO THE FULL SATISFACTION OF THE OWNER.
- CONTRACTOR SHALL BE RESPONSIBLE FOR ANY COORDINATION WITH SUBCONTRACTORS AS REQUIRED TO ACCOMPLISH OPERATIONS.
- ALL QUANTITIES AND PAY ITEMS ARE AND WILL BE BASED ON HORIZONTAL MEASUREMENTS.
- ALL PATTERNS, LINE TYPES, AND SYMBOLS SHOWN WITHIN THE PLAN SET REFERENCE THE LAYOUT LEGEND AND ARE PART OF THE SCOPE OF WORK. CALLOUTS ARE SHOWN FOR CLARIFICATION OF WORK, BUT DO NOT INDICATE EVERY AND ALL INSTANCES OF SUCH WORK. THE CONTRACTOR SHALL REQUEST CLARIFICATION TO ANY ITEMS (INCLUDING BUT NOT LIMITED TO PAVING, WALLS, FINISHES, COLORS, FENCING, FOUNTAINS, POTS, AND SITE FURNITURE) NOT CLEARLY IDENTIFIED TO BE PART OF THE SCOPE OF WORK PRIOR TO BID.
- THE CONTRACT DRAWINGS MUST BE ACCOMPANIED BY CONTRACT SPECIFICATIONS. THE CONTRACTOR MUST CONTACT THE LANDSCAPE ARCHITECT AT 925-736-8176 FOR SPECIFICATIONS IF NOT RECEIVED.
- THE CONTRACTOR IS RESPONSIBLE FOR ALL WORK AND MATERIALS OF THE CONTRACT DOCUMENTS INCLUDING ALL WORK AND MATERIALS PROVIDED BY SUBCONTRACTORS. ALL QUALIFICATIONS OF THE CONTRACT DOCUMENTS INCLUDING ALL SPECIFIC EXCLUSIONS OF ANY WORK, DETAILS, MATERIALS, AND INCIDENTALS SHALL BE CONFIRMED AND ACCEPTED IN WRITING BY THE CONTRACTOR AND OWNER UPON FINALIZATION OF BIDS AND CONTRACT. THE LANDSCAPE ARCHITECT SHALL BE NOTIFIED OF ALL QUALIFICATIONS AND NOTIFICATIONS.

SUBMITTAL AND MOCK UP NOTES

- PAVING
- CONTRACTOR SHALL SUBMIT DECOMPOSED GRANITE MOCK UP PER SPECS FOR REVIEW AND APPROVAL PRIOR TO INSTALLATION.

ABBREVIATIONS

AB	AGGREGATE BASE	CP	CONTROL POINT	ES	EQUAL SPACING	INV	INVERT ELEVATION	N	NORTH	PR	PROPOSED	SMH	SIGNAL MANHOLE	THRU	THROUGH
AC	ASPHALT CONCRETE	CTRL	CONTROL	EW	EACH WAY	IC	IRRIGATION CONTROL	NE	NORTH EAST	PVC	POLYVINYL CHLORIDE PIPE	SP	SPACING	TOD	TOP OF DOCK
AD	AREA DRAIN	CY	CUBIC YARD	EX., EXIST.	EXISTING	IRR	IRRIGATION	NW	NORTH WEST	(R)	RELOCATED	S.P.D.	SEE PLUMBING DRAWINGS	TOE	TOE OF SLOPE
ADA	AMERICANS WITH DISABILITIES ACT	C.3	PROVISION OF THE MUNICIPAL REGIONAL STORMWATER NPDES	(F), FUT.	FUTURE	JB	JUNCTION BOX	(N)	NEW	RC	RADIUS	SS	SANITARY SEWER	TOS	TOP OF STAIR
ADD ALT	ADD ALTERNATE			FC	FACE OF CURB	JT	JOINT TRENCH	N.I.C.	NOT IN CONTRACT	R	RELATIVE COMPACTION	SSCO	SANITARY SEWER CLEANOUT	TOW	FG @ TOP OF WALL
AFF	ABOVE FINISHED GRADE		PERMIT (MRP) THAT REQUIRES EACH DISCHARGER TO CONTROL THE FLOW OF STORMWATER POLLUTANTS FROM NEW DEVELOPMENT AND REDEVELOPMENT SITES OVER WHICH IT HAS JURISDICTION	FF	FINISHED FLOOR	L	LENGTH	NO	NUMBER	RR	RAILROAD	SSM	SANITARY SEWER MANHOLE	TS	TOP OF SLAB
AGG	AGGREGATE SUBBASE			FG	FINISHED GRADE	L.O.W.	LIMIT OF WORK	NTS	NOT TO SCALE	R/W	RIGHT OF WAY	SST	STAINLESS STEEL	TYP	TYPICAL
BFP	BACK FLOW PREVENTOR			FL	FLOW LINE	LP	LIP OF GUTTER	OC	ON CENTER	S	SLOPE OR SOUTH	S.S.D.	SEE STRUCTURAL DRAWINGS	UON	UNLESS OTHERWISE NOTED
BLDG	BUILDING			FOB	FACE OF BUILDING	LSA	LANDSCAPE ARCHITECT	OFCI	OWNER FURNISHED CONTRACTOR	S.A.A.	SEE ARCHITECTURAL DRAWINGS	ST	STREET	U/G	UNDERGROUND
BLVD	BOULEVARD			FS	FINISHED SURFACE	LSB	LIGHT SAND BLAST	OFOW	OWNER FURNISHED OWNER	SCD	SEE CIVIL DRAWINGS	STA	STATION	W	WATER OR WEST
BOS	BOTTOM OF STEP			FT	FOOT	MAX	MAXIMUM	SD	STORM DRAIN	SE	SOUTH EAST	STD	STANDARD	WM	WATER METER
BOW	FG @ BOTTOM OF WALL	DOM	DOMESTIC	(A)	GROUND ELEVATION	MDL	MODEL	SE	SEE ELECTRICAL DRAWINGS	S.E.D.	SEE ELECTRICAL DRAWINGS	SO	SQUARE	WP	WATERPROOF
B/W	BETWEEN	D/W	DRIVEWAY	GV	GATE VALVE	MED	MEDIUM	S	SAND BLAST	S.F.	SILT FENCE	S/W	SOUTH WEST OR SIDEWALK	WPM	WATERPROOF MEMBRANE
BW	BACK OF WALK	DWG	DRAWING	HCR	HANDICAP FACILITY	MEP	MECHANICAL/ELECTRICAL/PLUMBING	SF	SEE ARCHITECTURAL DRAWINGS	S.G.	SUBGRADE	T	TREAD	WTR	WATER
BW	BOTH WAYS	E	EAST OR ELECTRICAL	HDPE	HANDICAP FACILITY ACCESSIBLE RAMP	MFR	MANUFACTURER	SG	SEE ARCHITECTURAL DRAWINGS	SIM	SIMILAR	TBD	TO BE DETERMINED	WV	WATER VALVE
C	CONCRETE	(E)	EXISTING	HP	HIGH DENSITY POLYETHYLENE	MH	MANHOLE	S.L.D.	SEE LANDSCAPE DRAWINGS	PL	PERFORATED	TC	TOP OF CURB	WWF	WELDED WIRE FABRIC
CIP	CAST IN PLACE	EA	EACH	HSB	HEAVY SAND BLAST	MIN	MINIMUM	S.M.D.	SEE MECHANICAL DRAWINGS			TD	TRENCH DRAIN	W/	WITH
CL	CENTER LINE OR CLASS	EJ	EXPANSION JOINT	HT	HEIGHT	MSB	MEDIUM SAND BLAST					TEL, T	TELEPHONE	W/OUT	WITHOUT
CMU	CONCRETE MASONRY UNIT	ELEV	ELEVATION												
CONC	CONCRETE	EQ	EQUAL												

LAYOUT LEGEND

PAVING SCHEDULE					
SYMBOL	NAME	DETAIL	DESCRIPTION/ MANUFACTURER	MODEL AND SIZE	COLOR AND FINISH
	PEDESTRIAN CONCRETE PAVING	1/L5.03	CIP CONCRETE	-	STANDARD GRAY, MEDIUM BROOM
	DECOMPOSED GRANITE PAVING	3/L5.03	TECHNISOL	G3 COMMERCIAL SURFACE	CALIFORNIA GOLD
	REDWOOD HEADER	3/L5.02	-	SEE DETAIL	-

SITE FURNISHING SCHEDULE					
SYMBOL	NAME	DETAIL	DESCRIPTION/ MANUFACTURER	MODEL	COLOR AND FINISH
	BIKE RACK	1,2/L5.04	CITY STANDARD	MADRAX, UX-200-LB-IG-G CUSTOM LEAN BAR W/ CITY LOGO	FOREST GREEN
	BIKE REPAIR STATION	3/L5.04	MDF	195 SM W/ PLATE TEMPLATE, STANDARD PEDESTAL	FINISH: POWDER COAT COLOR: GREEN
	BOULDER PLACEMENT	2/L5.02	PARSONS WALLS OR APPROVED EQUAL	-	PER DETAIL
	DOG WASTE DISPENSER	4/L5.04	PET PICKUPS	MODERN DOG KIT	GREEN


LAYOUT LEGEND - ADD ALT

PAVING SCHEDULE					
SYMBOL	NAME	DETAIL	DESCRIPTION/ MANUFACTURER	MODEL	COLOR AND FINISH
	SYNTHETIC RUBBER SURFACING	4/L5.03	SURFACE AMERICA	EXTREME-10	BEIGE
	CONCRETE MOWBAND	2/L5.03	CIP CONCRETE	-	STANDARD GRAY, MEDIUM BROOM

SYMBOLS LEGEND							
SYMBOL	NAME	SYMBOL	NAME	SYMBOL	NAME	SYMBOL	NAME
	PLANTING AREA		LIMIT OF WORK		PROPOSED POST TOP LIGHT, S.E.D.		EXISTING POST TOP LIGHT TO REMAIN, S.E.D.
	STORMWATER TREATMENT AREA		POINT OF BEGINNING		PROPOSED STREET LIGHT, S.E.D.		EXISTING STREET LIGHT TO REMAIN, S.E.D.
	SCORE LINE		CENTER LINE		RIP RAP, S.C.D.		SIGN, S.C.D.
	EXPANSION JOINT		FLUSH/ ALIGN				

SHEET LIST TABLE

SHEET NO.	SHEET TITLE
L1.01	NOTES AND LEGEND
L1.02	PLANTING NOTES AND LEGEND
L2.01	LAYOUT PLAN
L2.01A	LAYOUT PLAN - ADD ALT
L2.02	LAYOUT PLAN
L2.03	LAYOUT PLAN
L2.04	LAYOUT PLAN
L2.05	LAYOUT PLAN
L2.06	LAYOUT PLAN
L3.01	IRRIGATION PLAN
L3.02	IRRIGATION PLAN
L3.03	IRRIGATION PLAN
L3.04	IRRIGATION PLAN
L3.05	IRRIGATION PLAN
L3.06	IRRIGATION PLAN
L3.07	IRRIGATION NOTES AND LEGEND
L3.08	IRRIGATION DETAILS
L3.09	IRRIGATION DETAILS
L3.10	IRRIGATION WATER CALCULATIONS
L4.01	PLANTING PLAN
L4.02	PLANTING PLAN
L4.03	PLANTING PLAN
L4.04	PLANTING PLAN
L4.05	PLANTING PLAN
L4.06	PLANTING PLAN
L5.01	PLANTING DETAILS
L5.02	CONSTRUCTION DETAILS
L5.03	CONSTRUCTION DETAILS
L5.04	CONSTRUCTION DETAILS
L5.05	CONSTRUCTION DETAILS

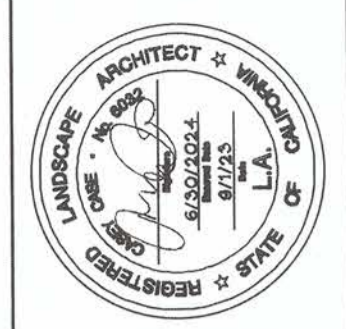

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 1821 MARKET STREET, SUITE 200, OAKLAND, CA 94612
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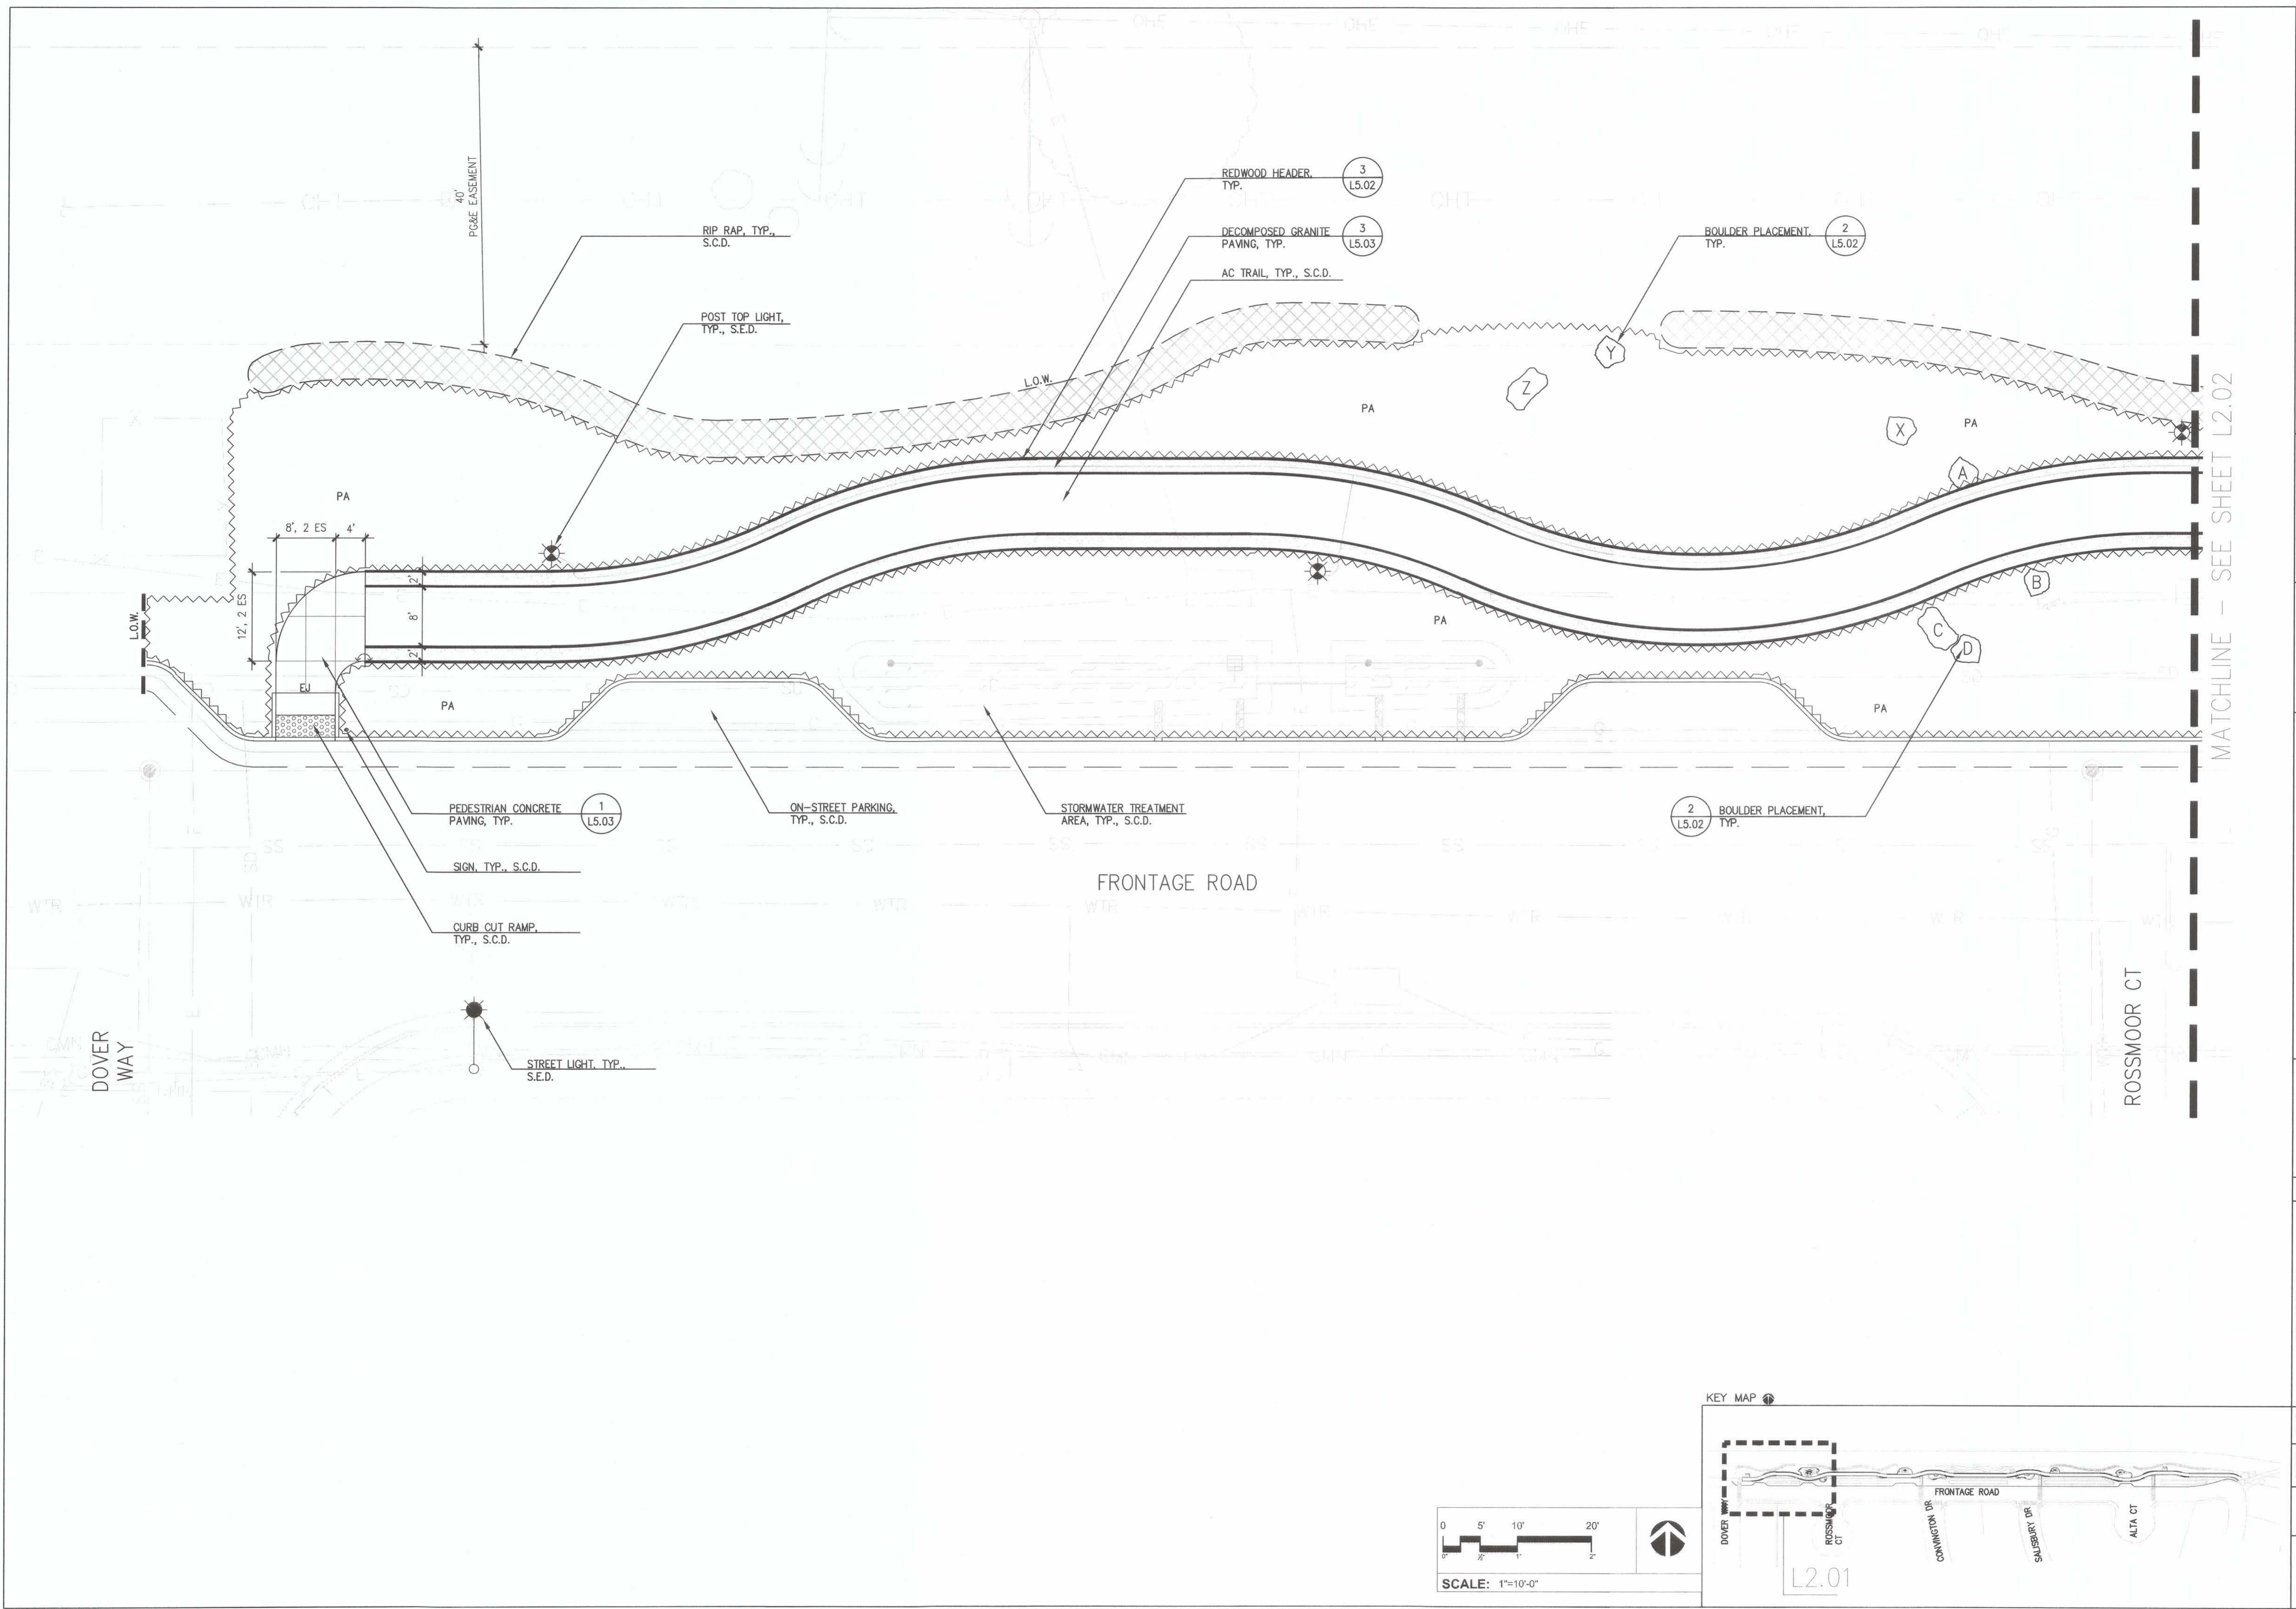
 JOHN SAMUELSON
 City Engineer
 Date: 9/24/23



FRONTAGE ROAD LIVING TRAIL
 NOTES AND LEGEND

BY	DATE	DESCRIPTION	REV	DATE	DESCRIPTION

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SHEET NO. 30 OF 59				
DWG. NO. L1.01				



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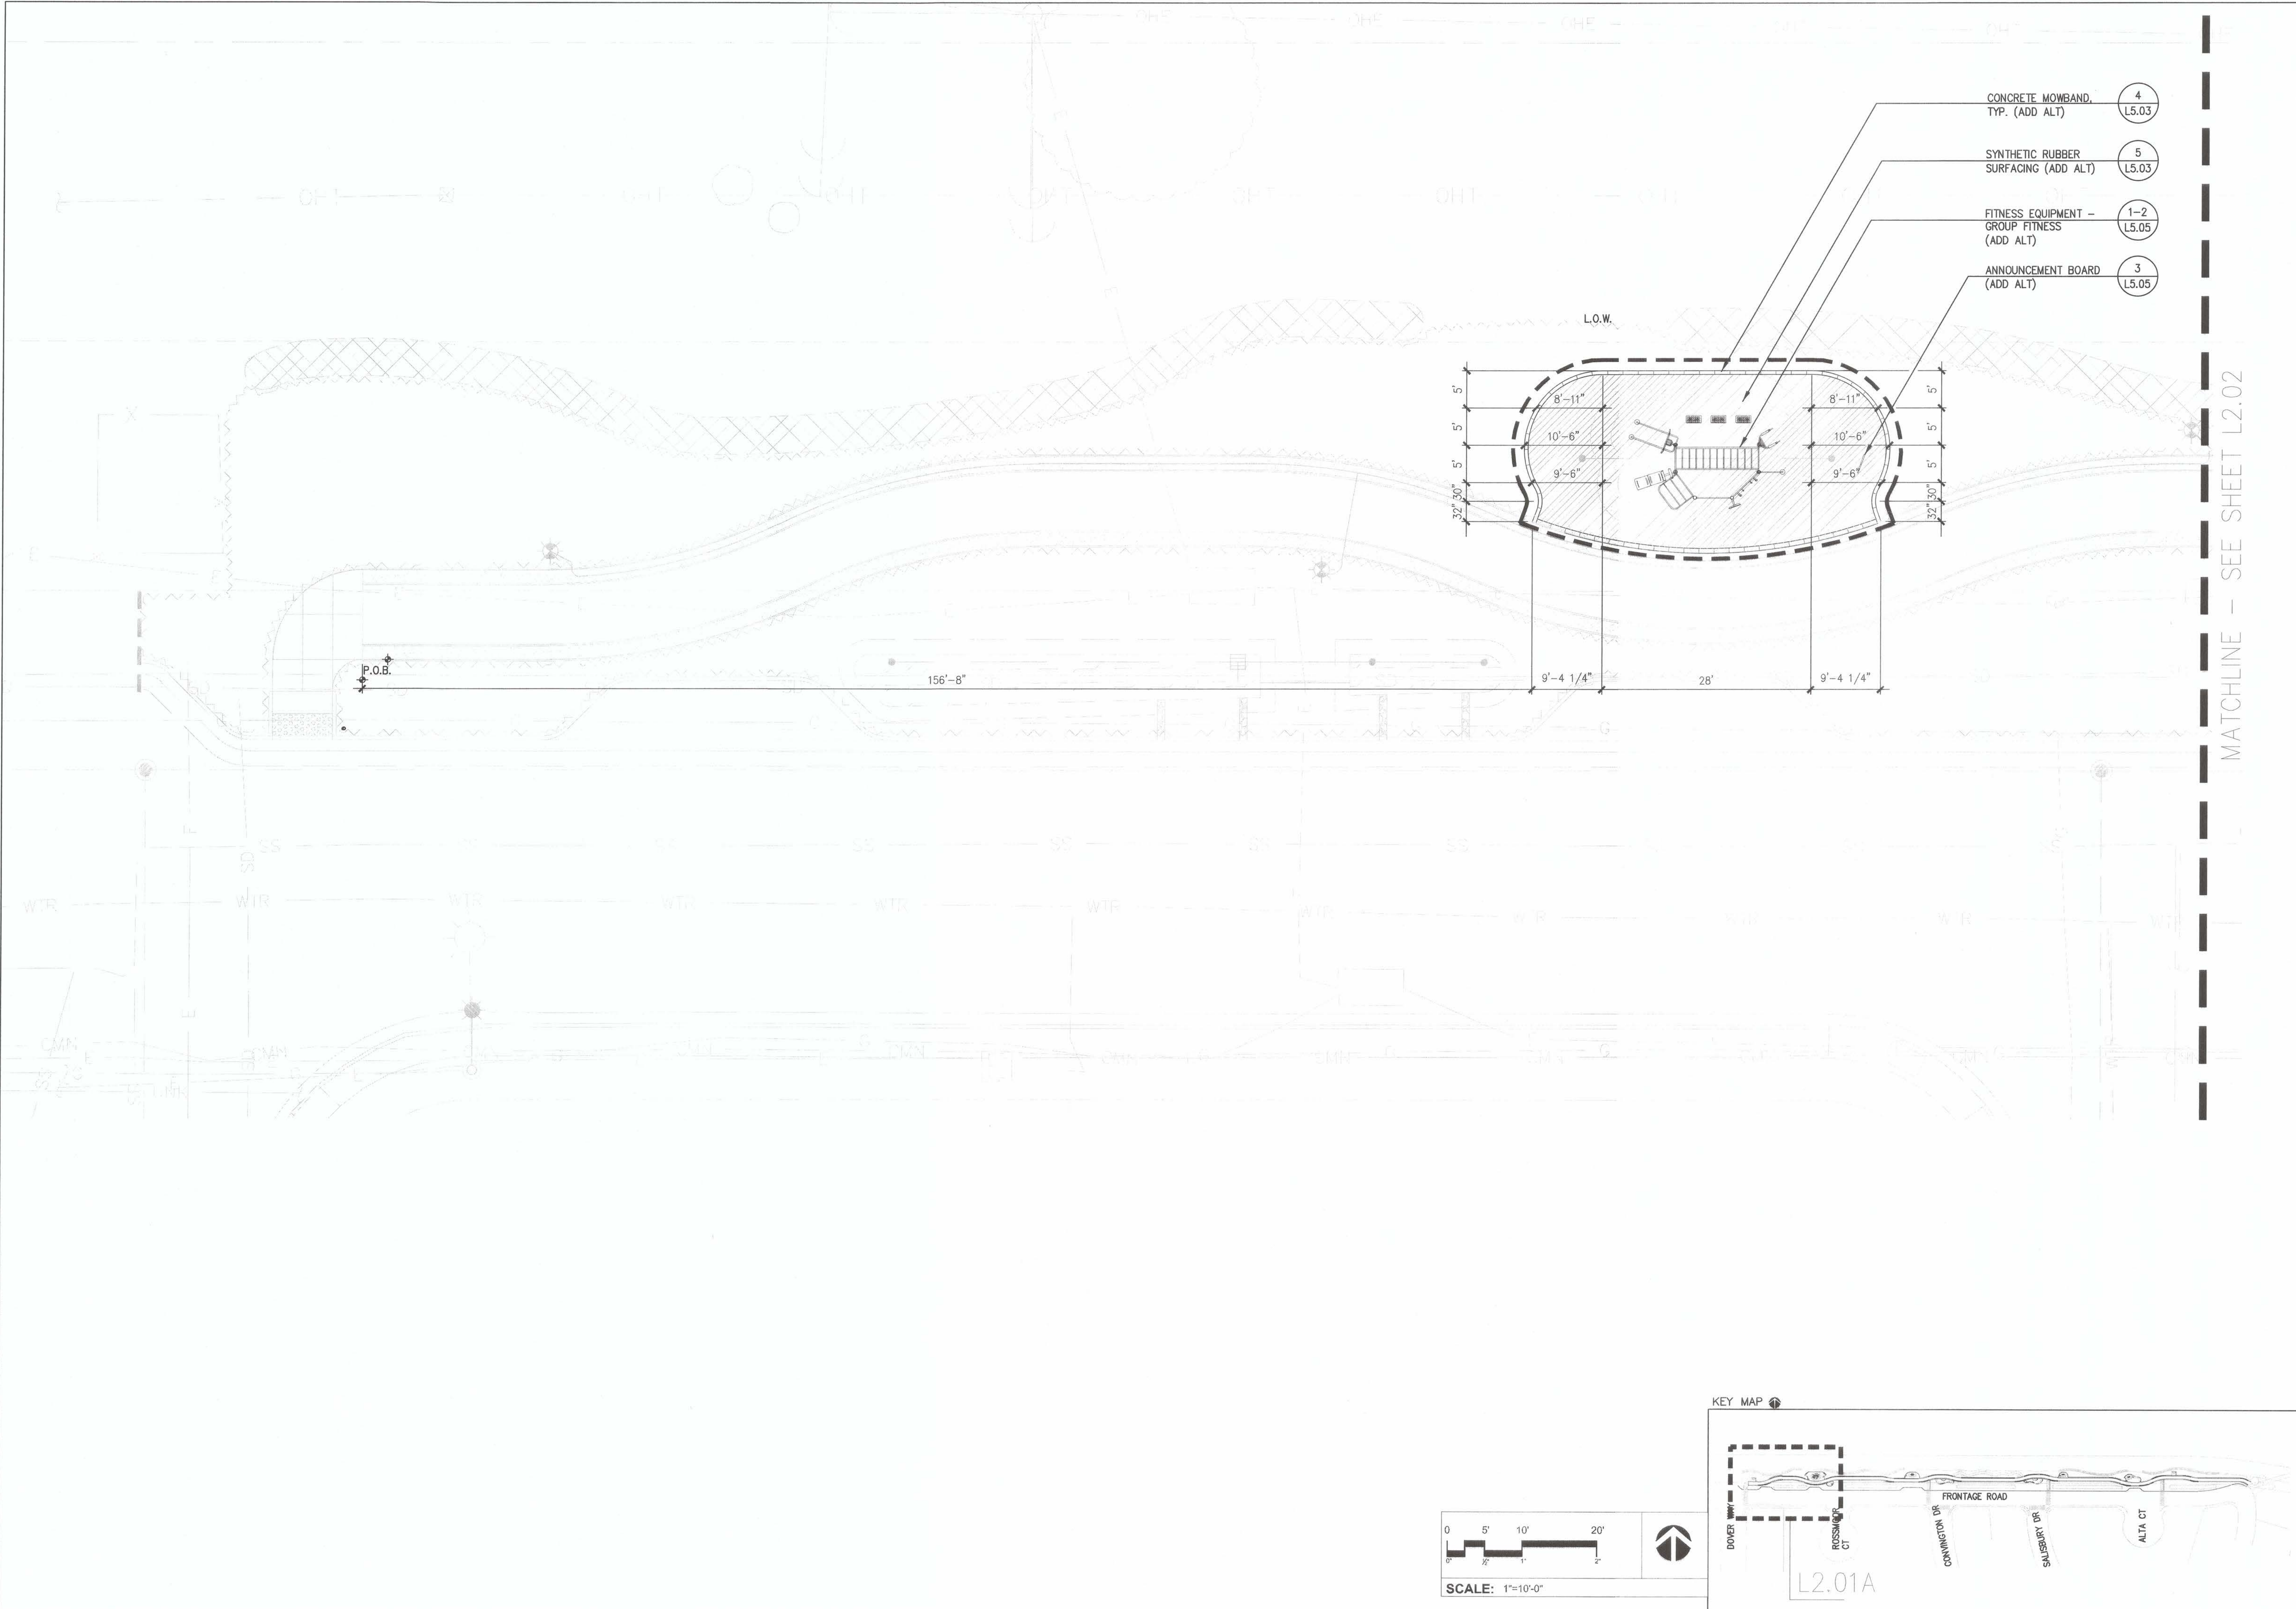


**FRONTAGE ROAD
 LIVING TRAIL**
 LAYOUT PLAN

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REV	REVIEWED: KC, TZ
DATE	DATE: 09/05/23
	SCALE: AS SHOWN



DATE	REV	DESCRIPTION

SHEET NO.
32 OF 59
 DWG. NO.
L2.01



- 4 CONCRETE MOWBAND, TYP. (ADD ALT) (L5.03)
- 5 SYNTHETIC RUBBER SURFACING (ADD ALT) (L5.03)
- 1-2 FITNESS EQUIPMENT - GROUP FITNESS (ADD ALT) (L5.05)
- 3 ANNOUNCEMENT BOARD (ADD ALT) (L5.05)

MATCHLINE - SEE SHEET L2.02

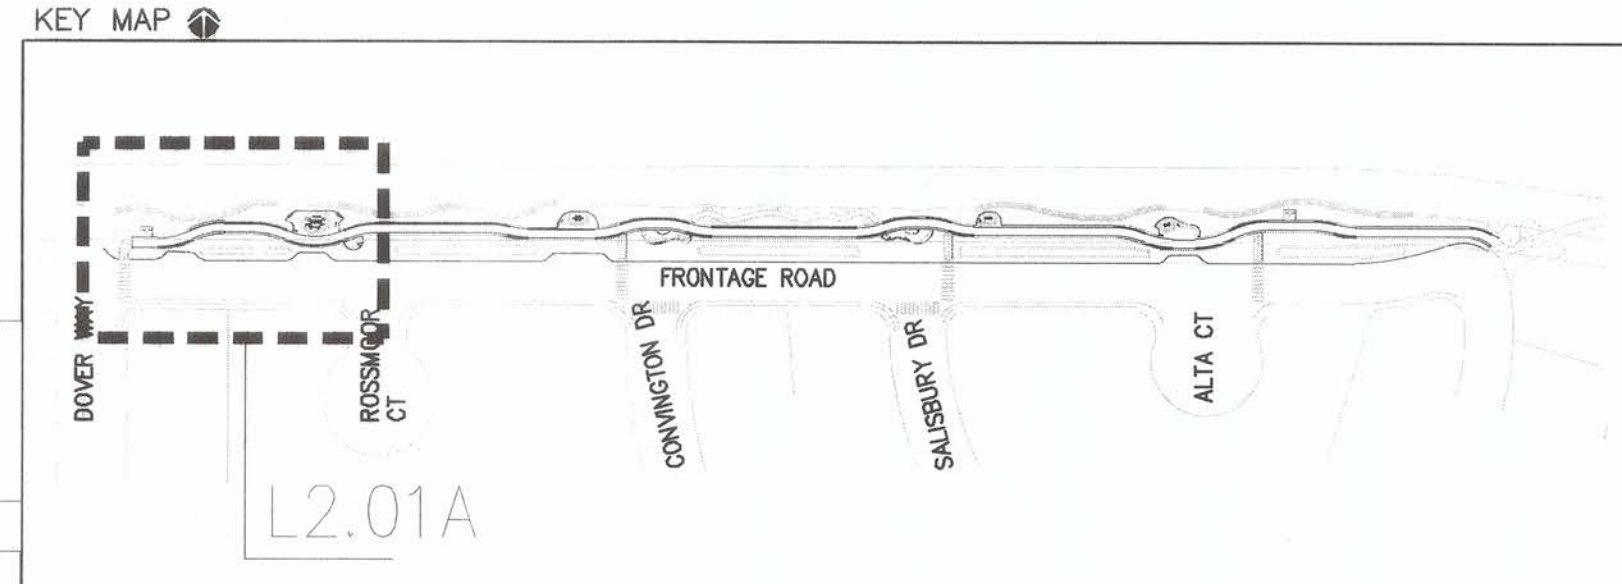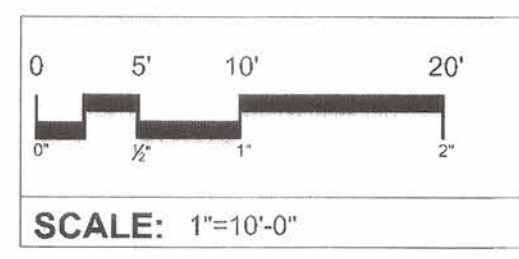

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City of Pittsburg





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 LAYOUT PLAN - ADD ALT

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	DATE: 09/05/23
	SCALE: AS SHOWN

SHEET NO.
33 OF 59
 DWG. NO.
L2.01A

MATCHLINE - SEE SHEET L2.01

MATCHLINE - SEE SHEET L2.03

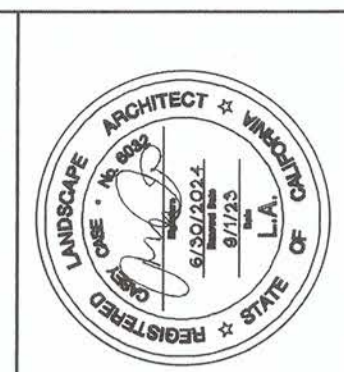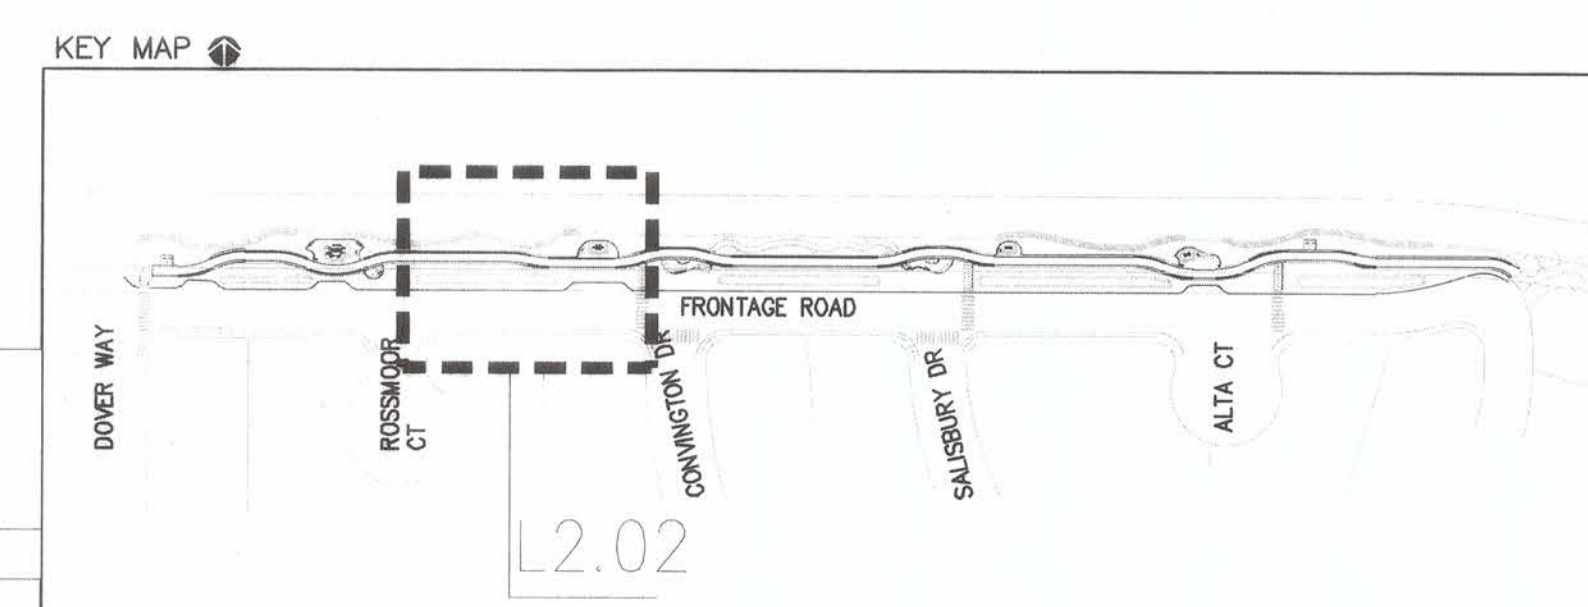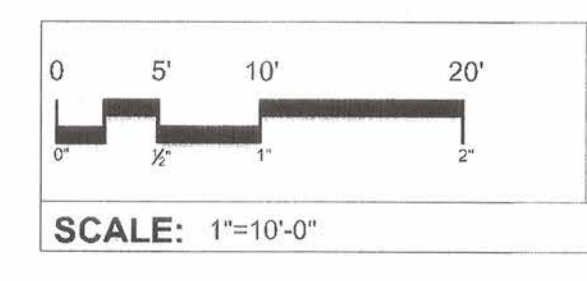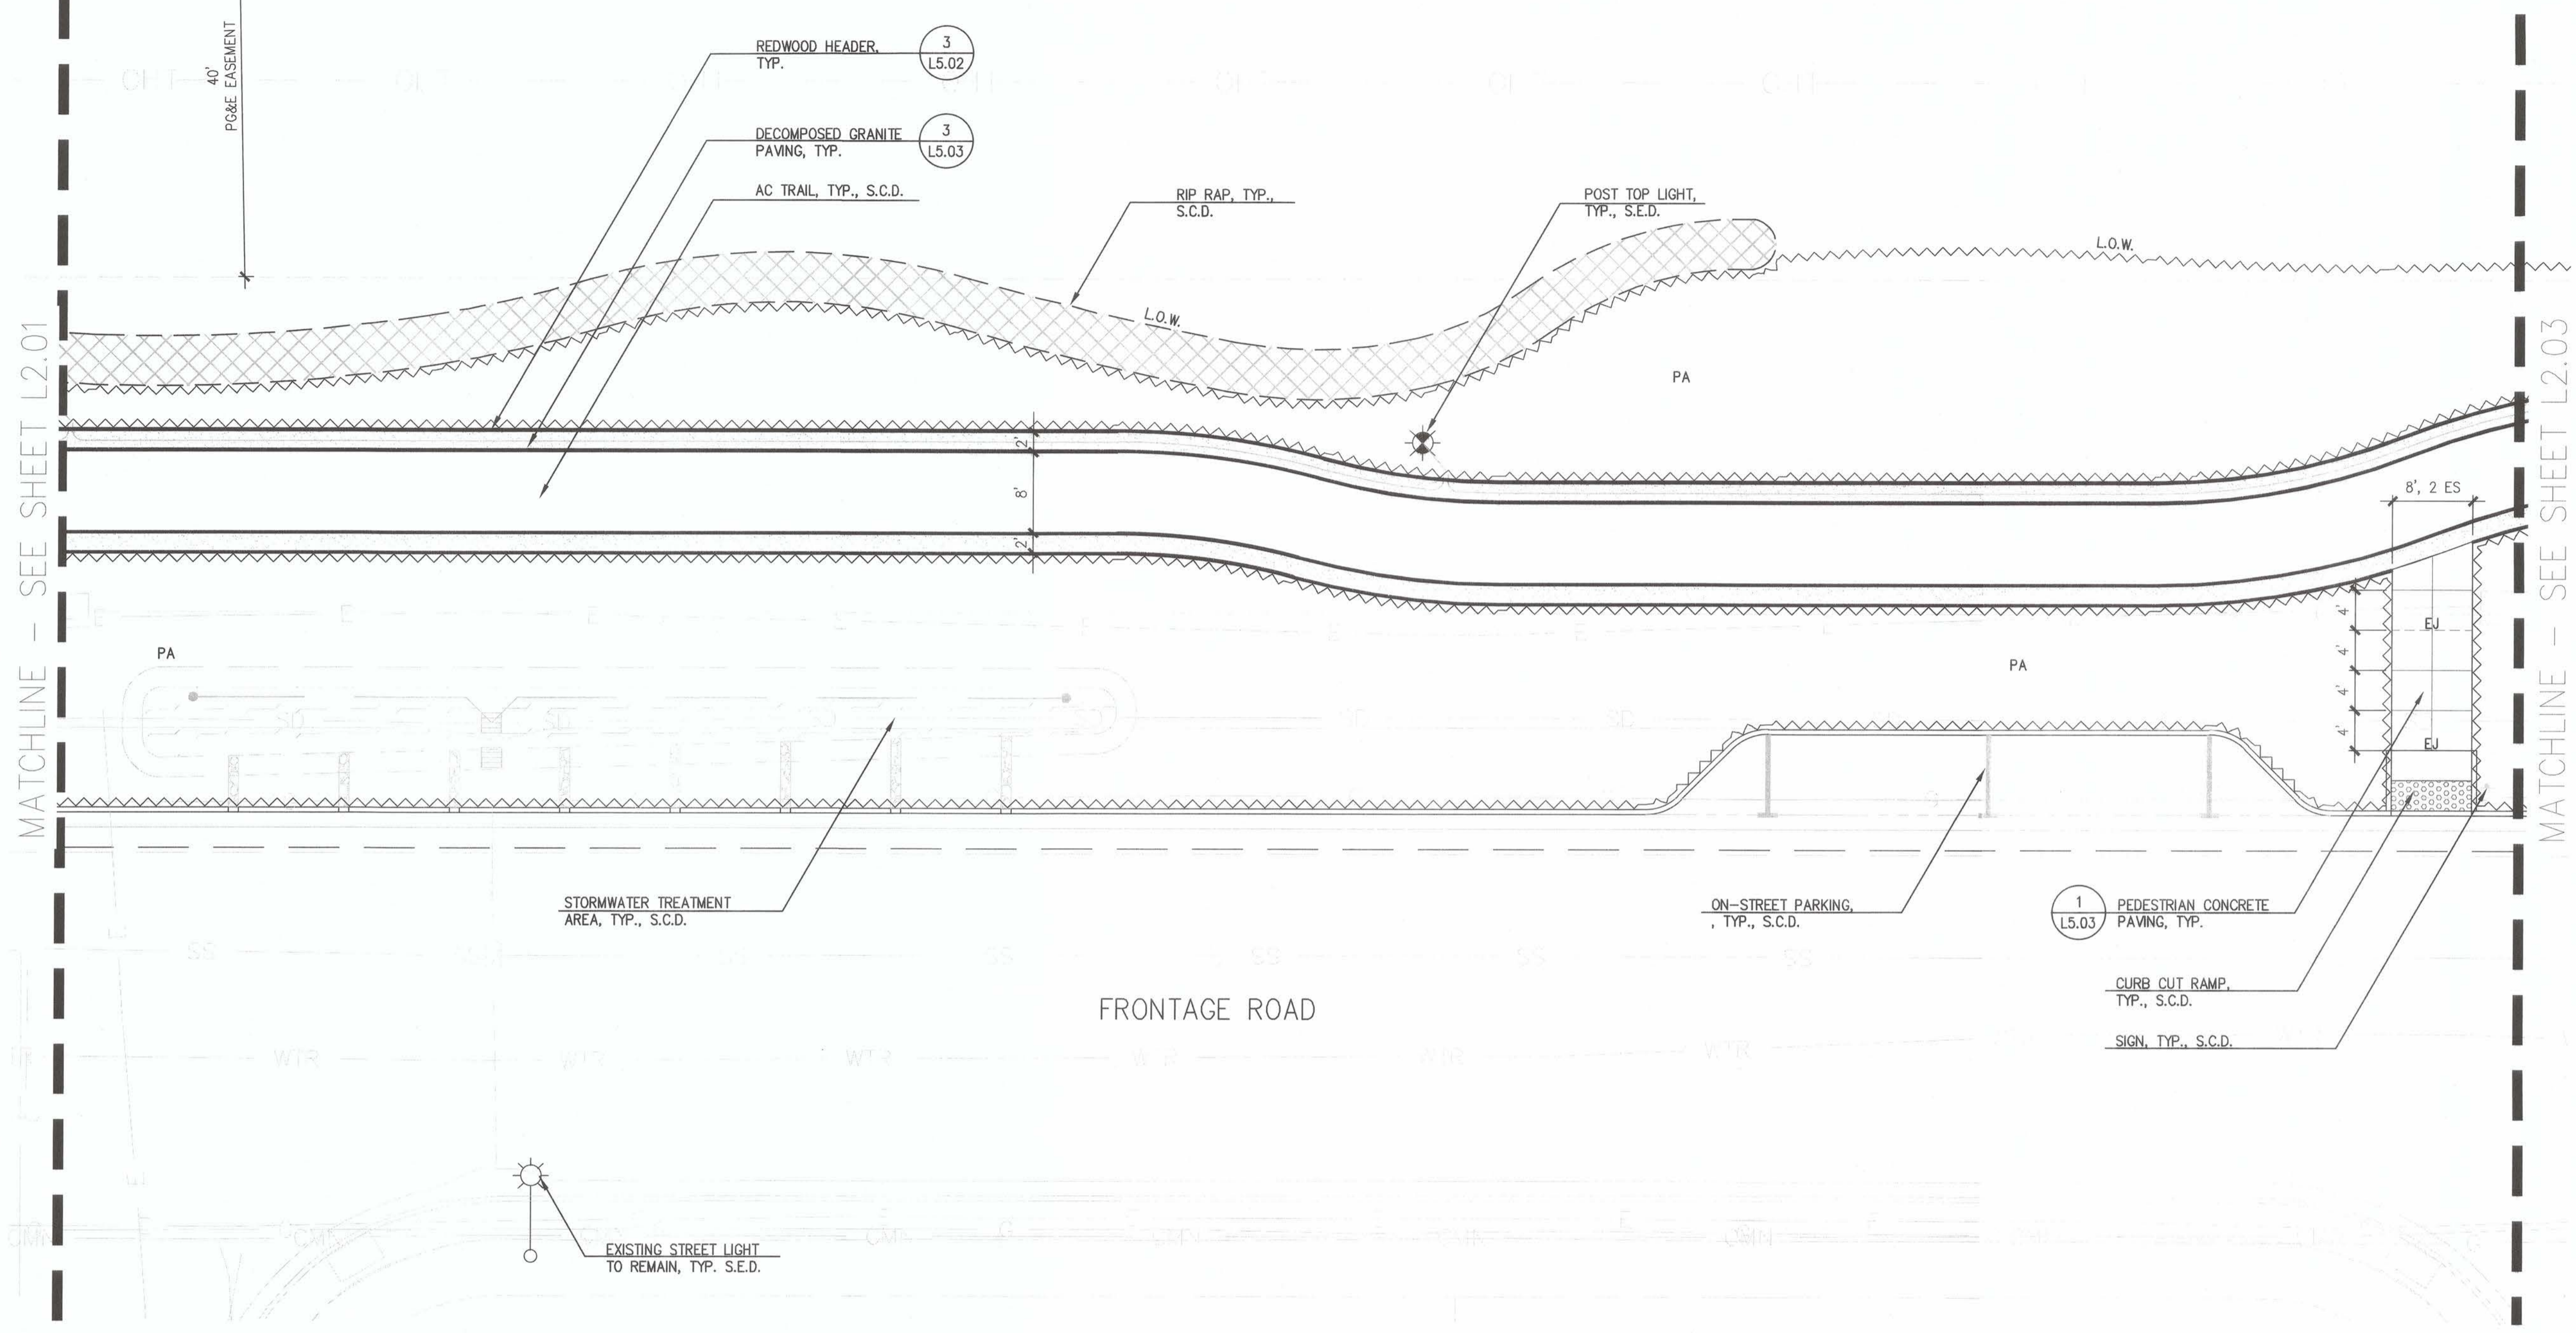

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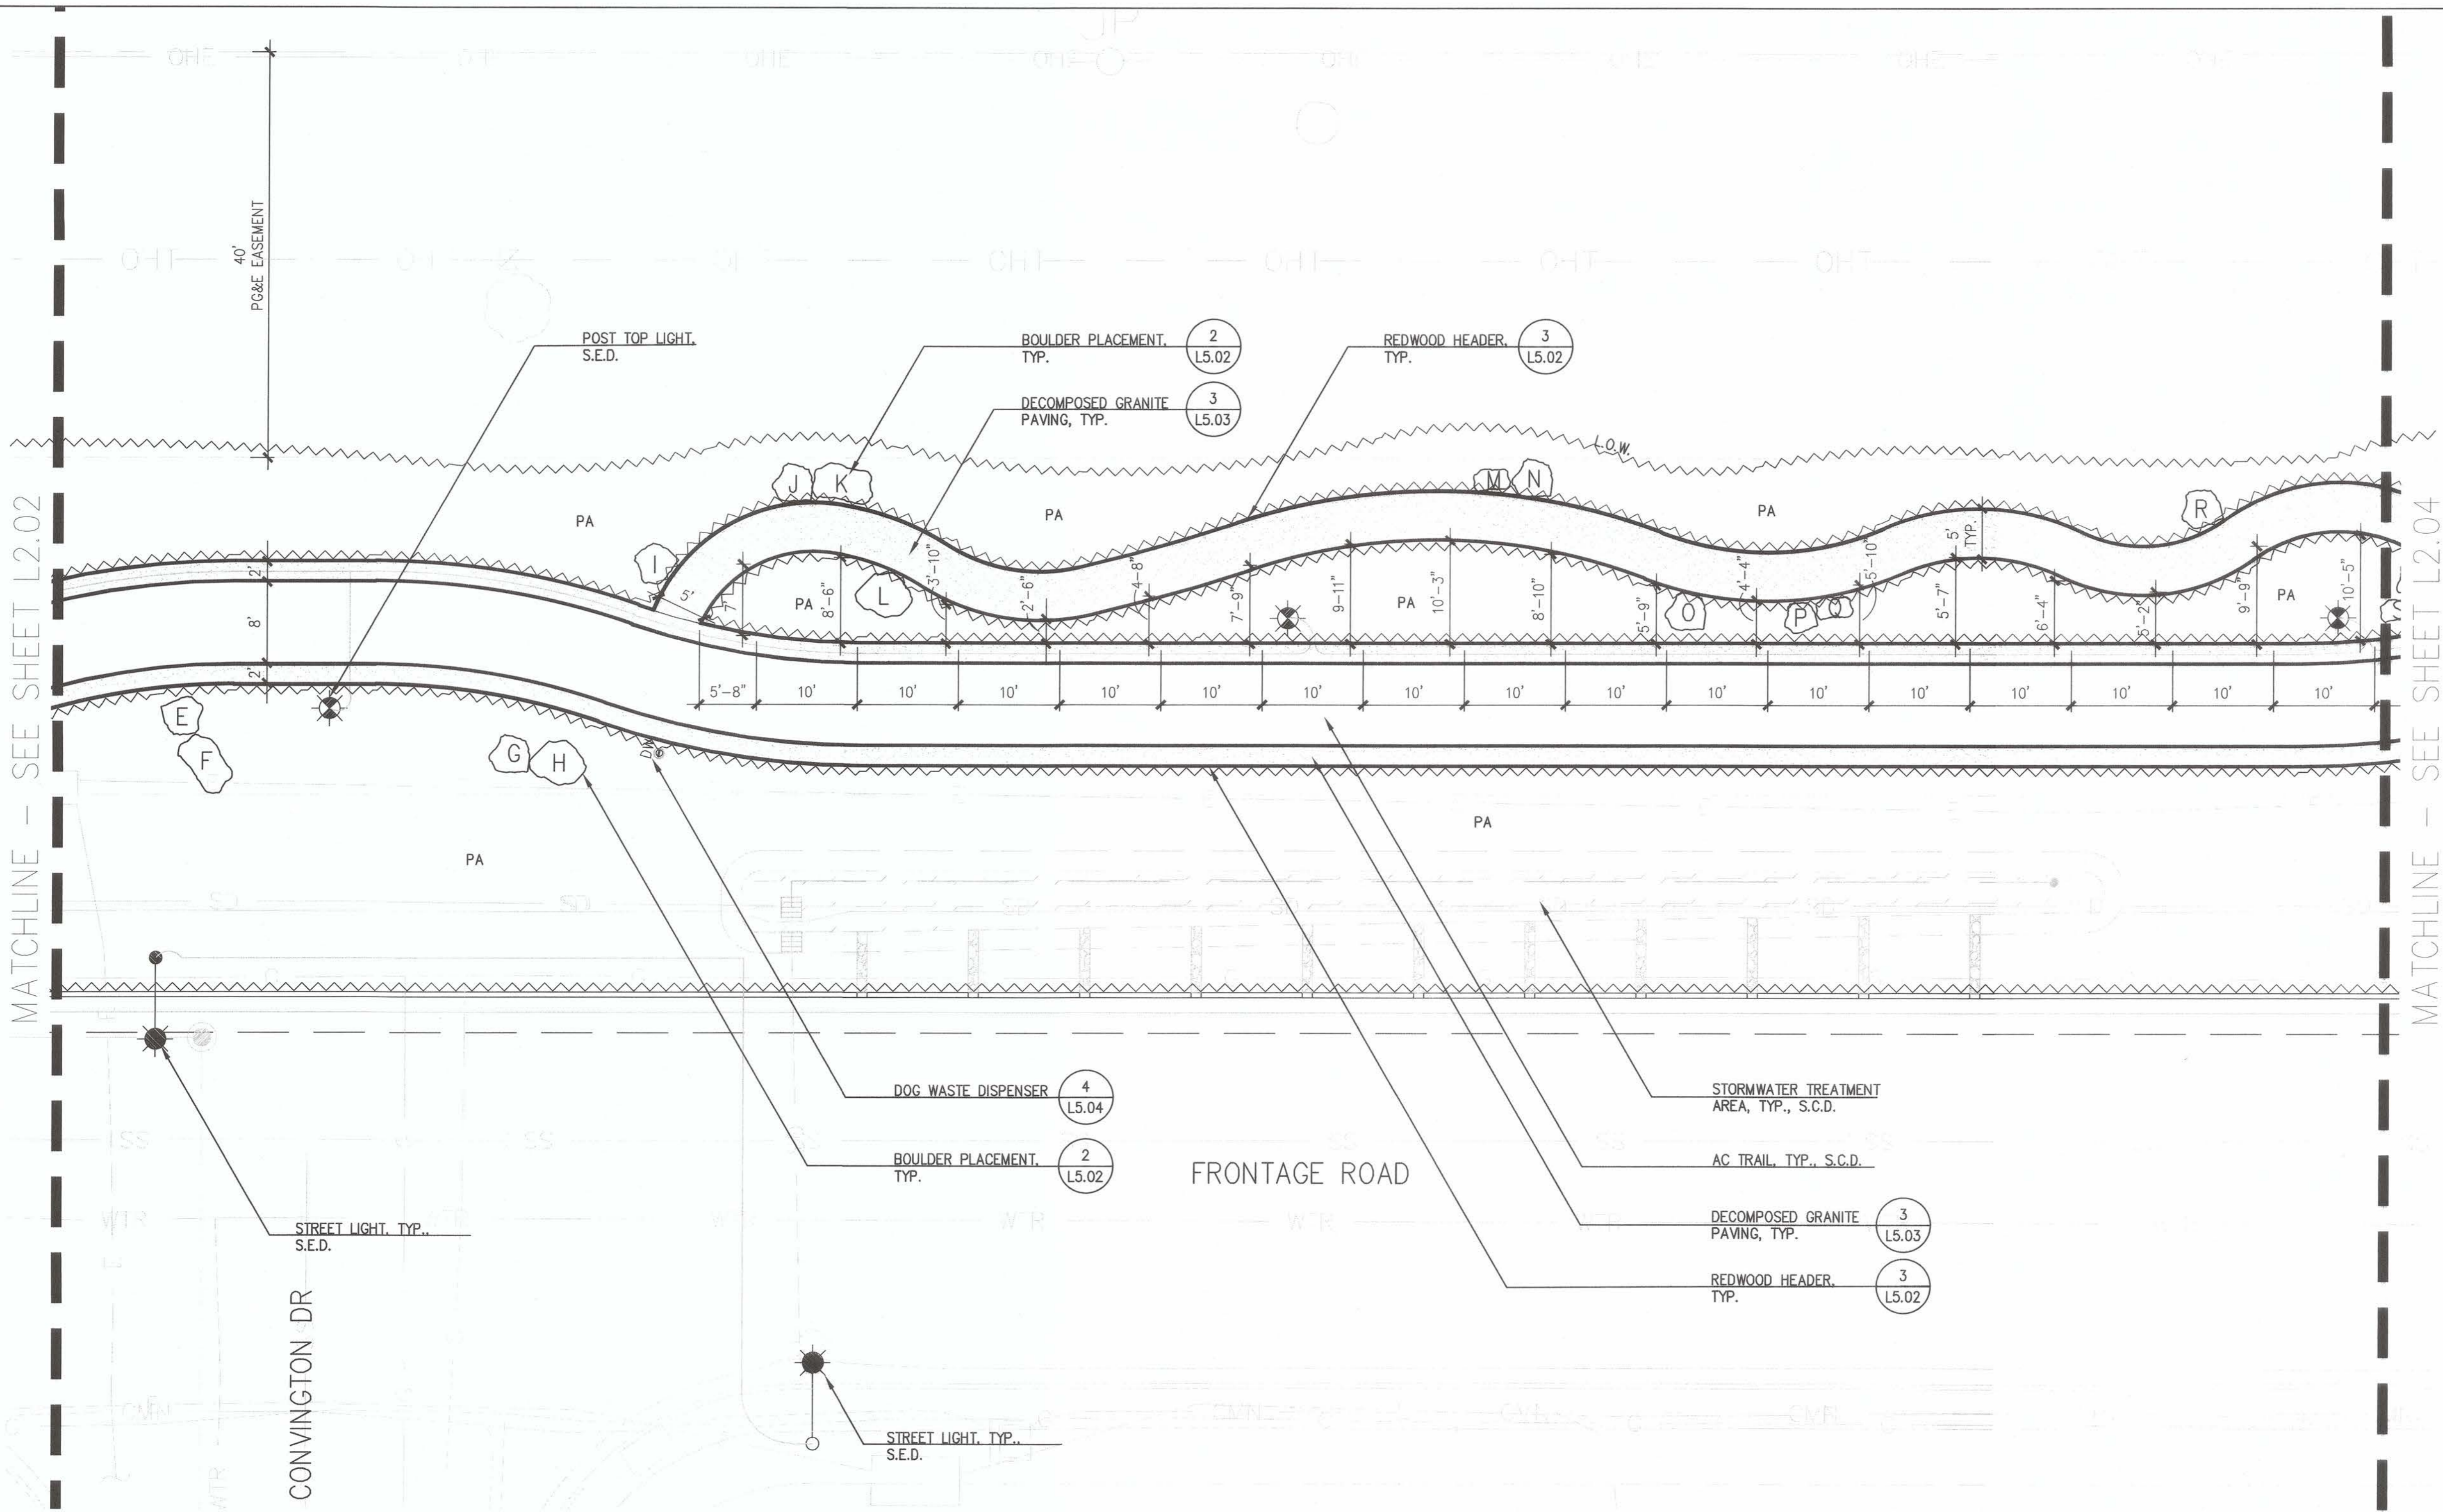
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 LAYOUT PLAN

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DATE	REV	DESCRIPTION

SHEET NO.
34 OF 59

DWG. NO.
L2.02





MATCHLINE - SEE SHEET L2.02

MATCHLINE - SEE SHEET L2.04

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FRONTAGE ROAD

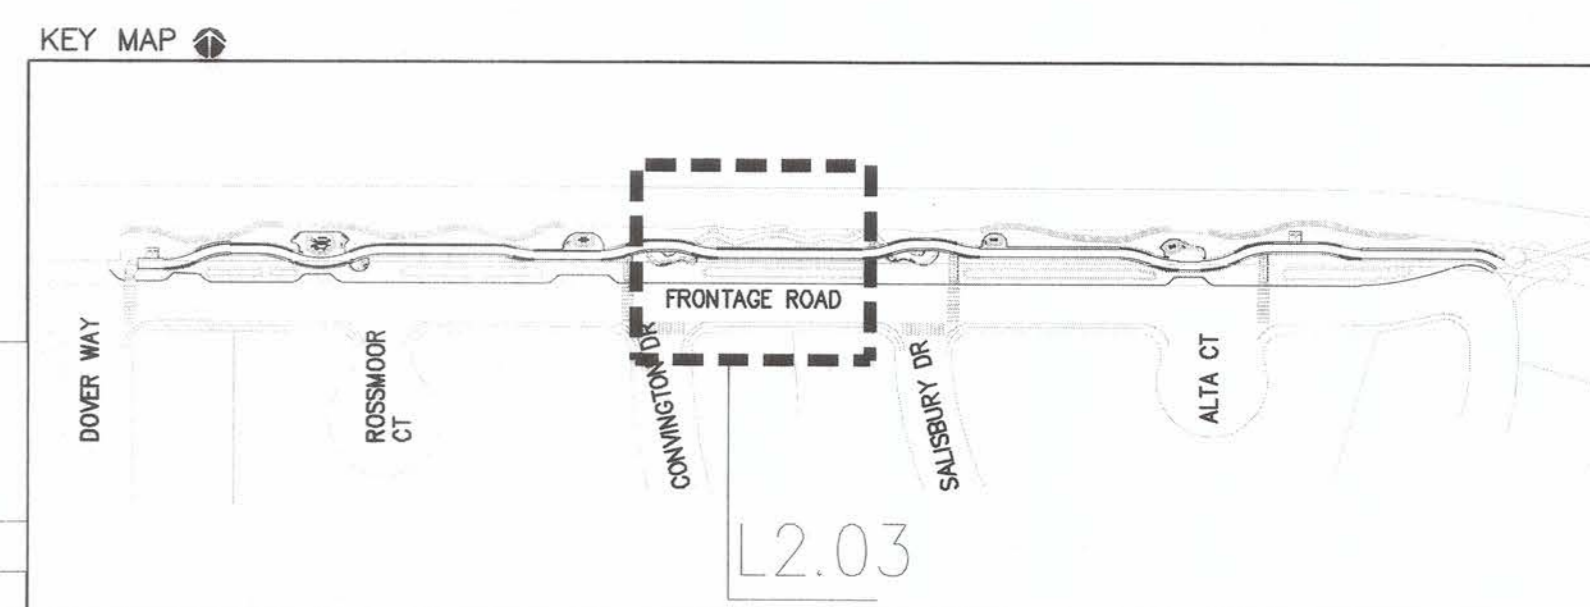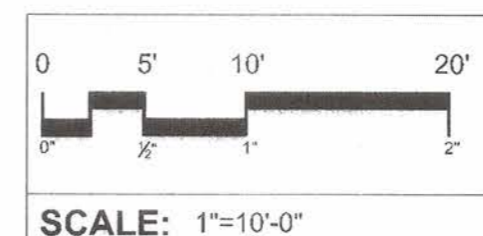

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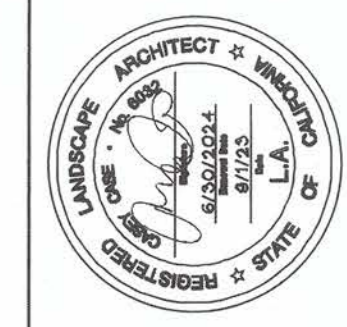
ACCEPTED FOR USE:
 JOHN SAMUELSON
 City Engineer
 Date: 9/26/23



**FRONTAGE ROAD
 LIVING TRAIL**
 LAYOUT PLAN

BY	DRAWN: TZ
DESCRIPTION	CHECKED: KC
REV	REVIEWED: KC, TZ
DATE	DATE: 09/05/23
	SCALE: AS SHOWN

SHEET NO.
 35 OF 59
 DWG. NO.
L2.03



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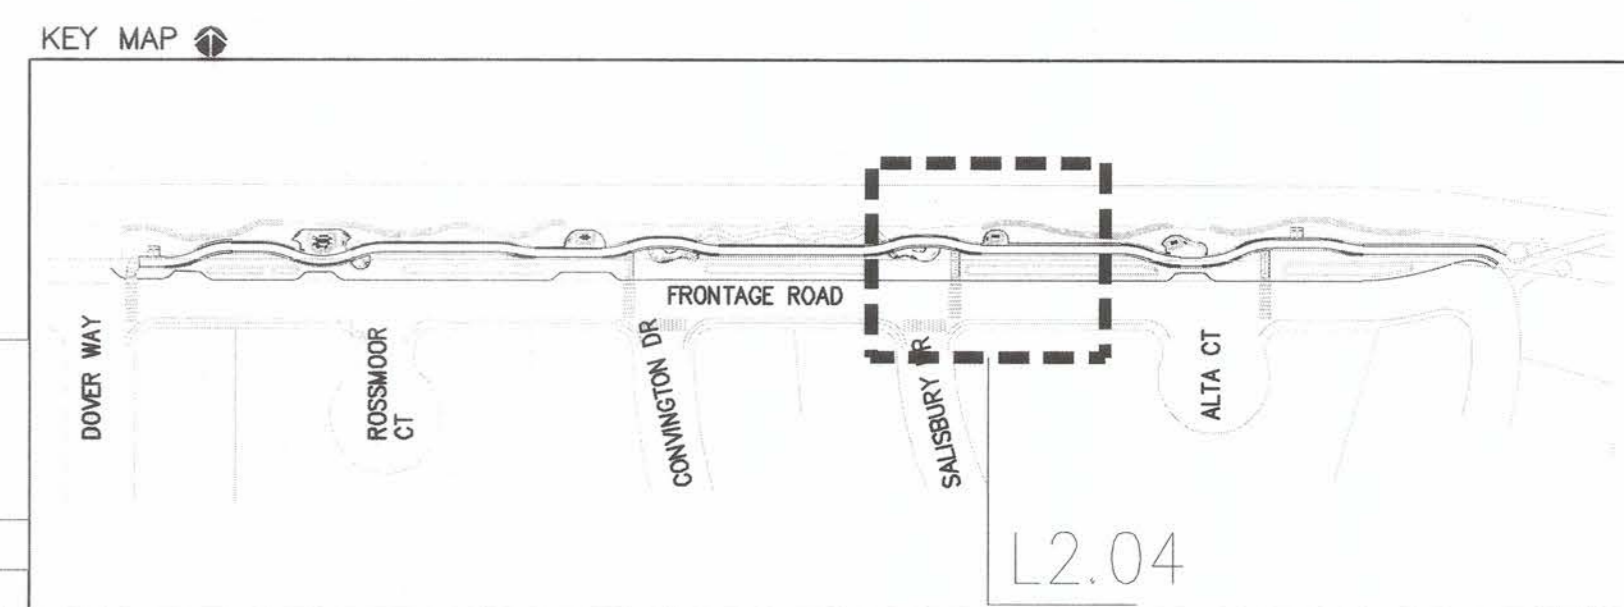
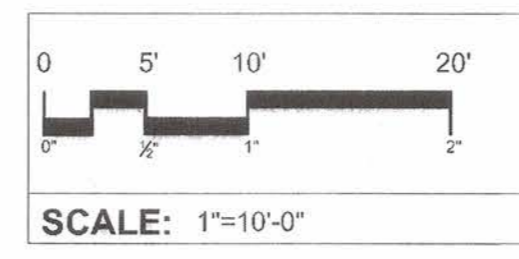
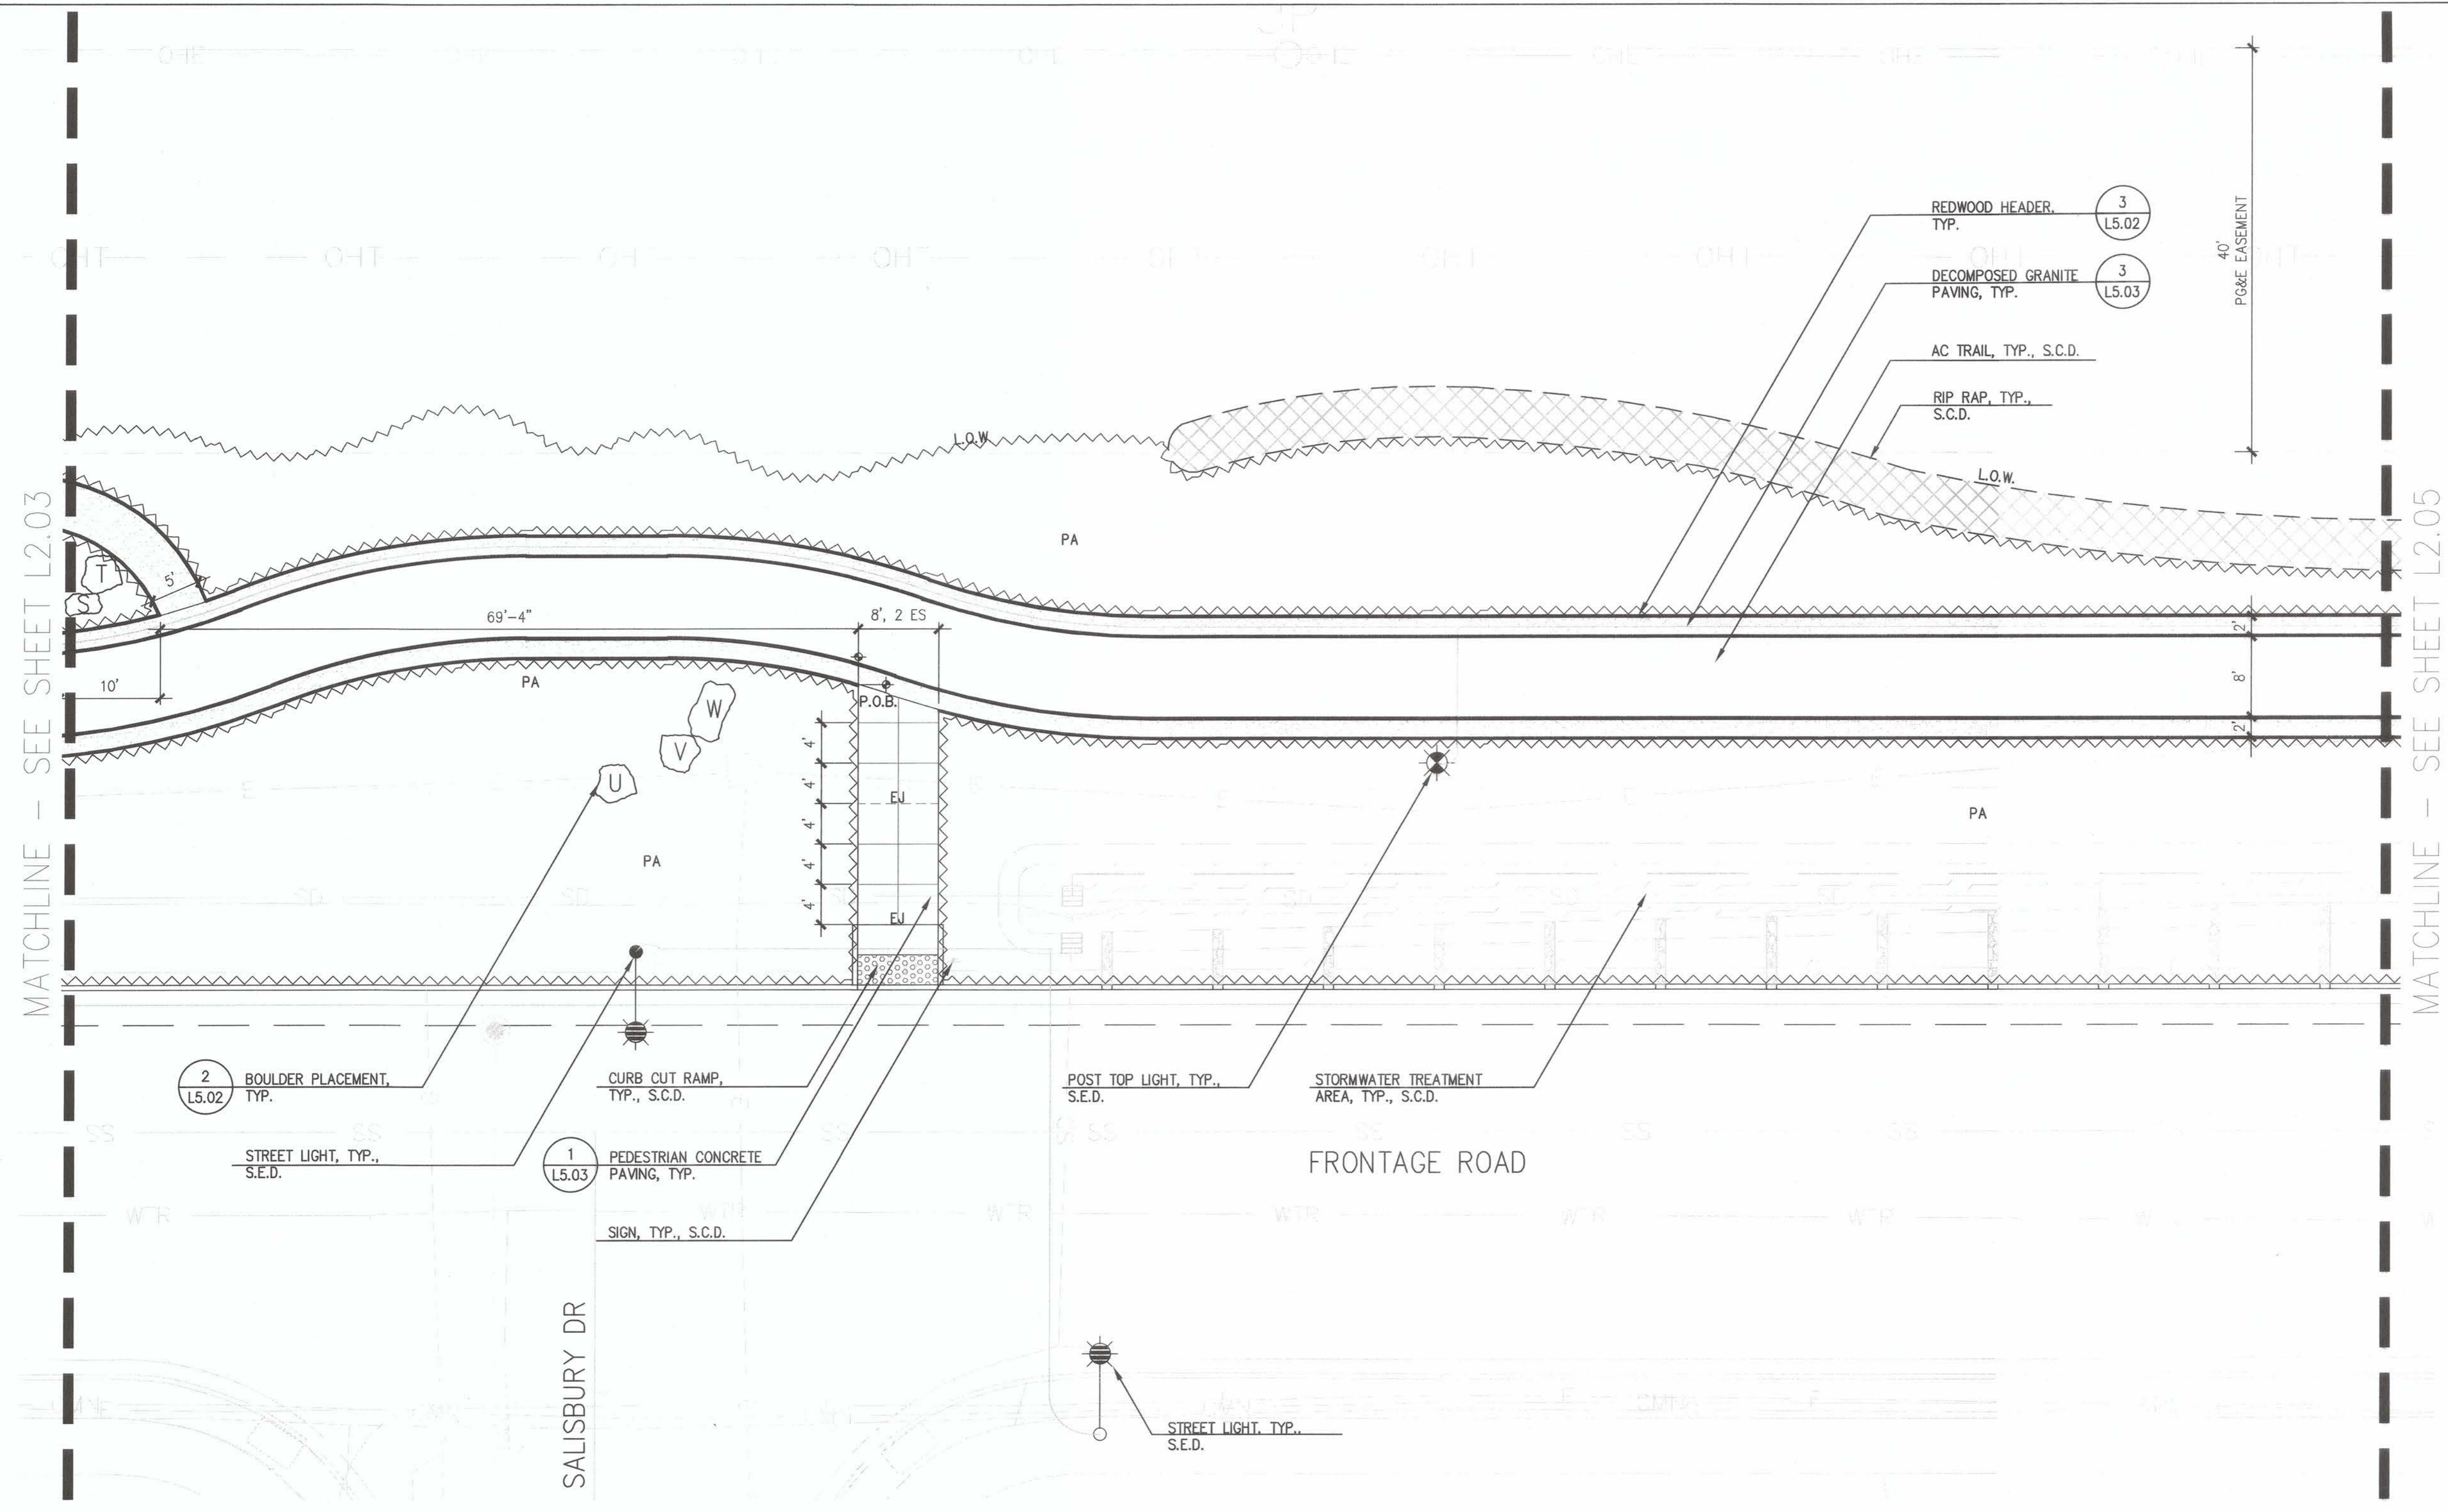



**FRONTAGE ROAD
 LIVING TRAIL**
 LAYOUT PLAN

BY: DRAWN: TZ
 CHECKED: KC
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 DATE: 09/05/23
 SCALE: AS SHOWN

DATE	REV	DESCRIPTION

SHEET NO.
36 OF 59
 DWG. NO.
L2.04



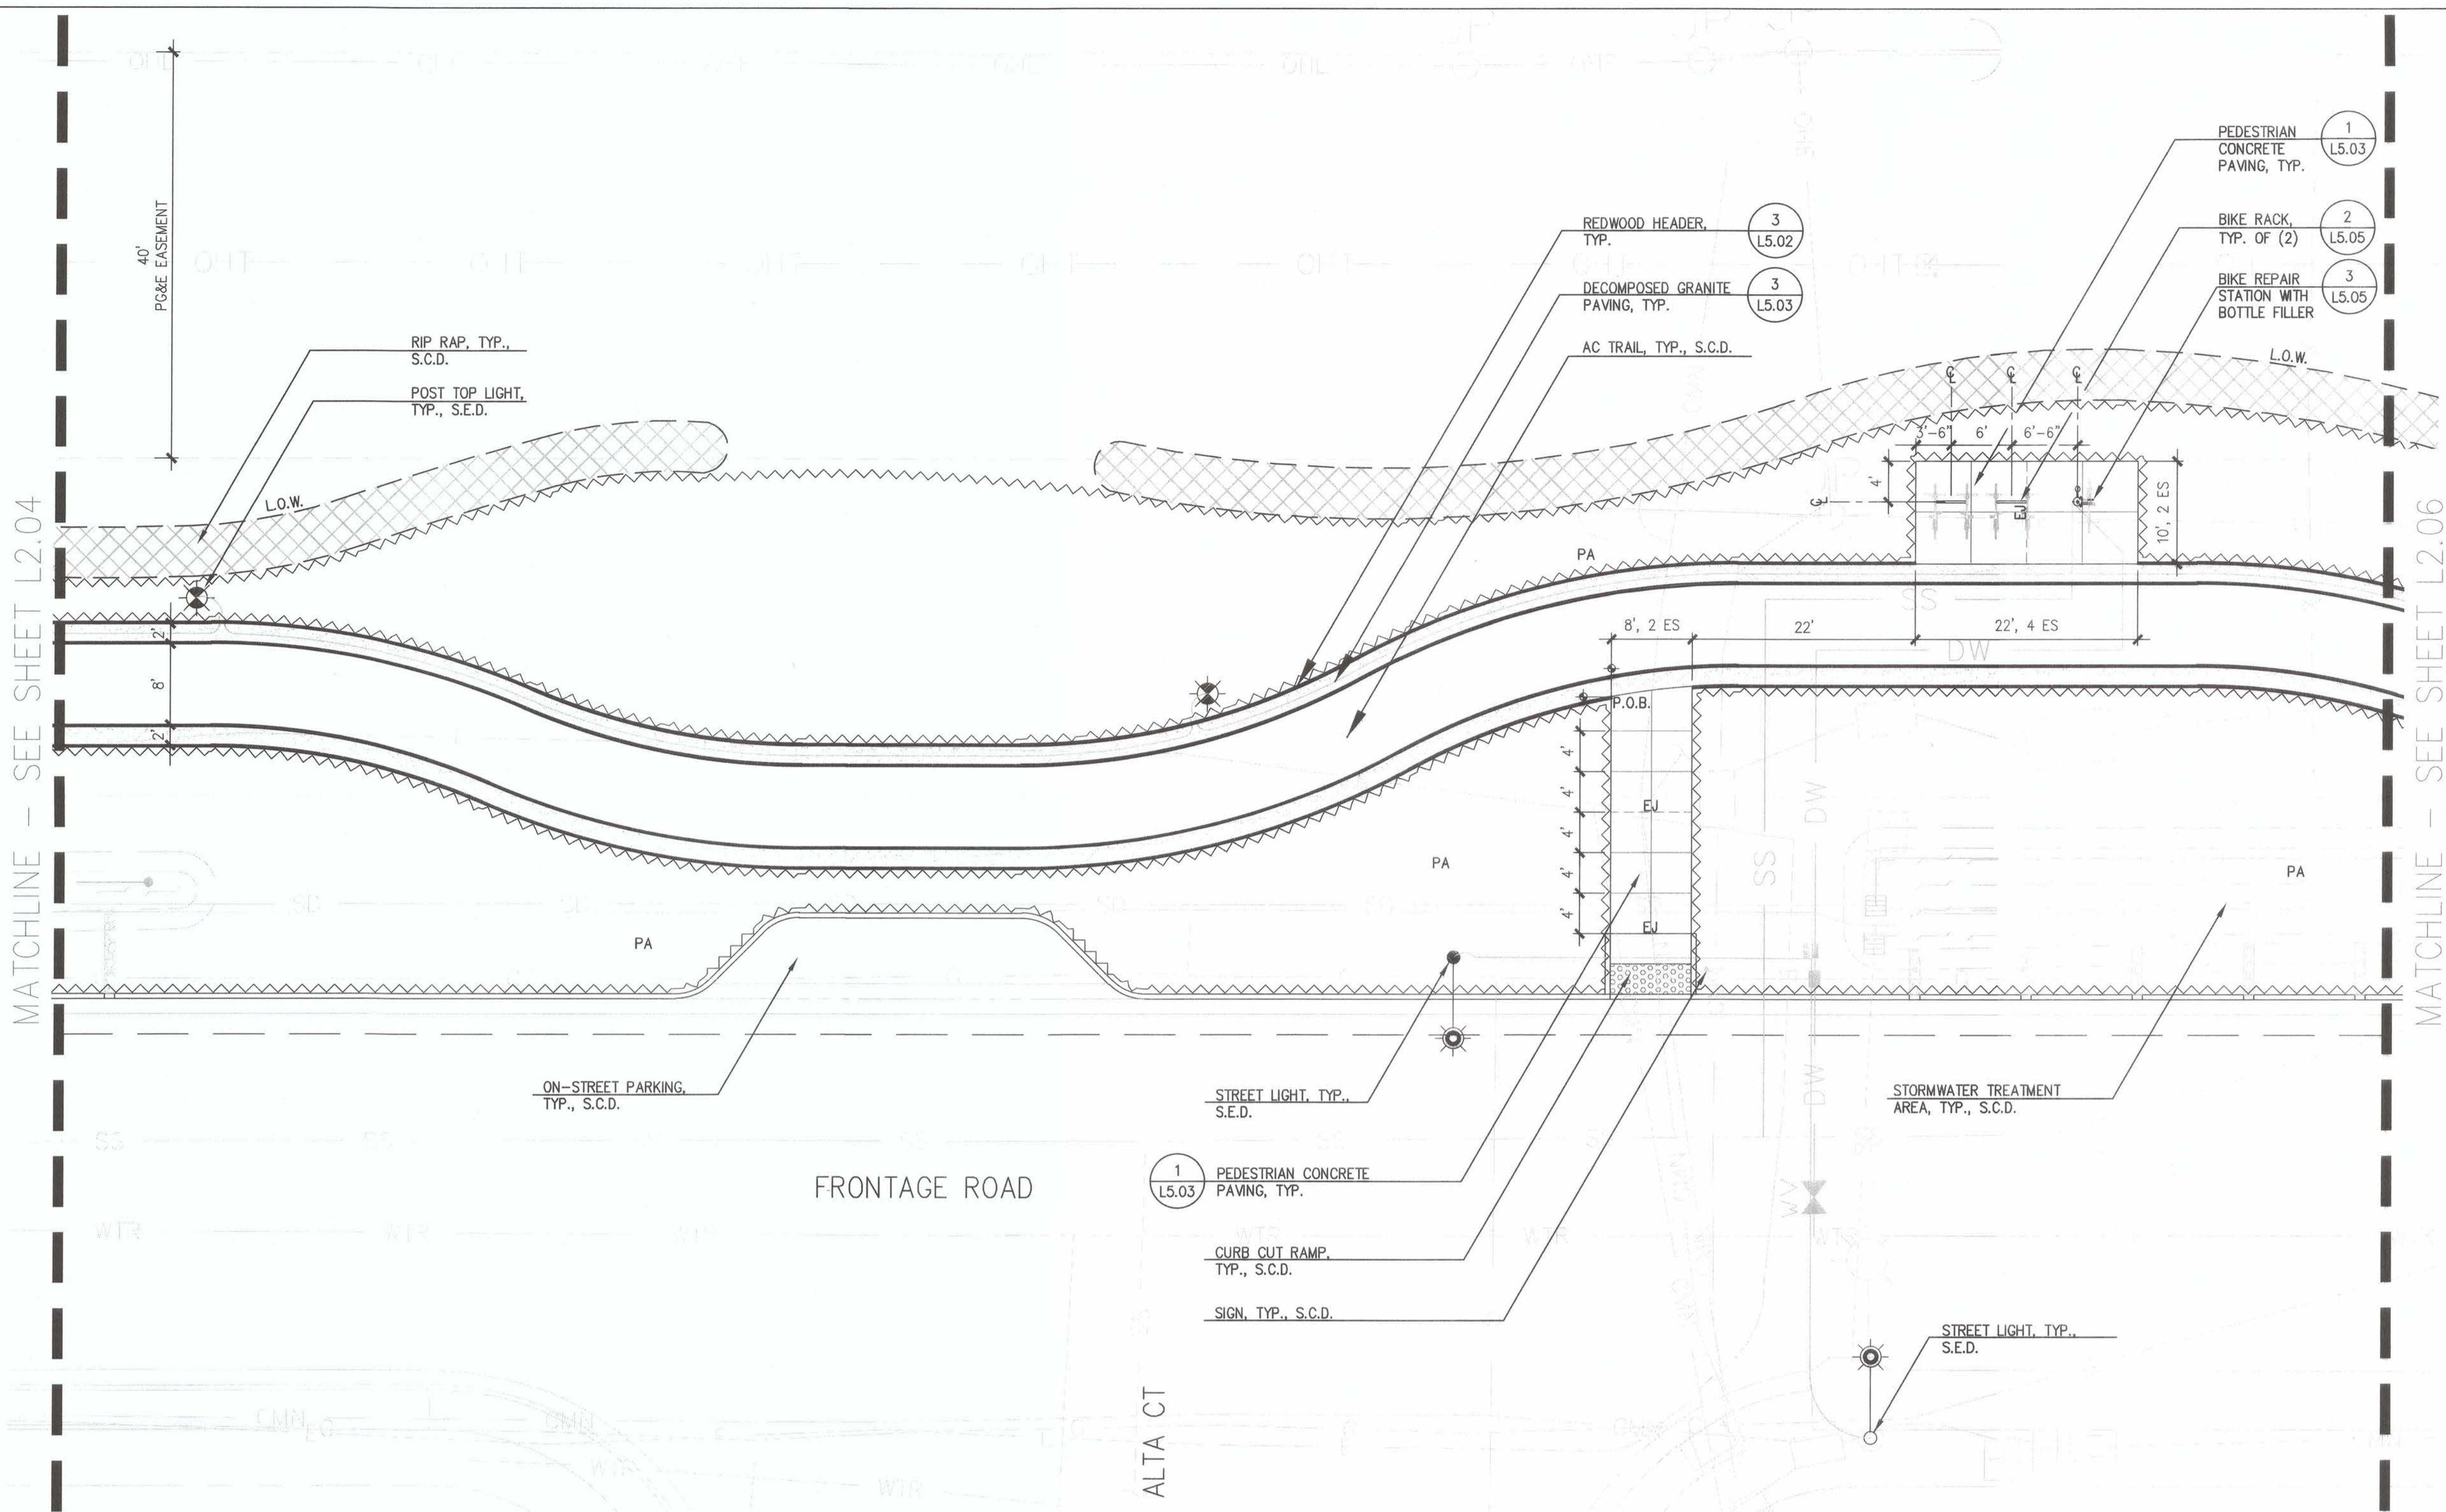


MATCHLINE - SEE SHEET L2.04


MATCHLINE - SEE SHEET L2.06

ALTA CT

FRONTAGE ROAD

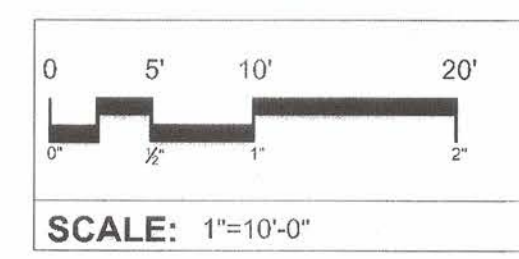

KEY MAP

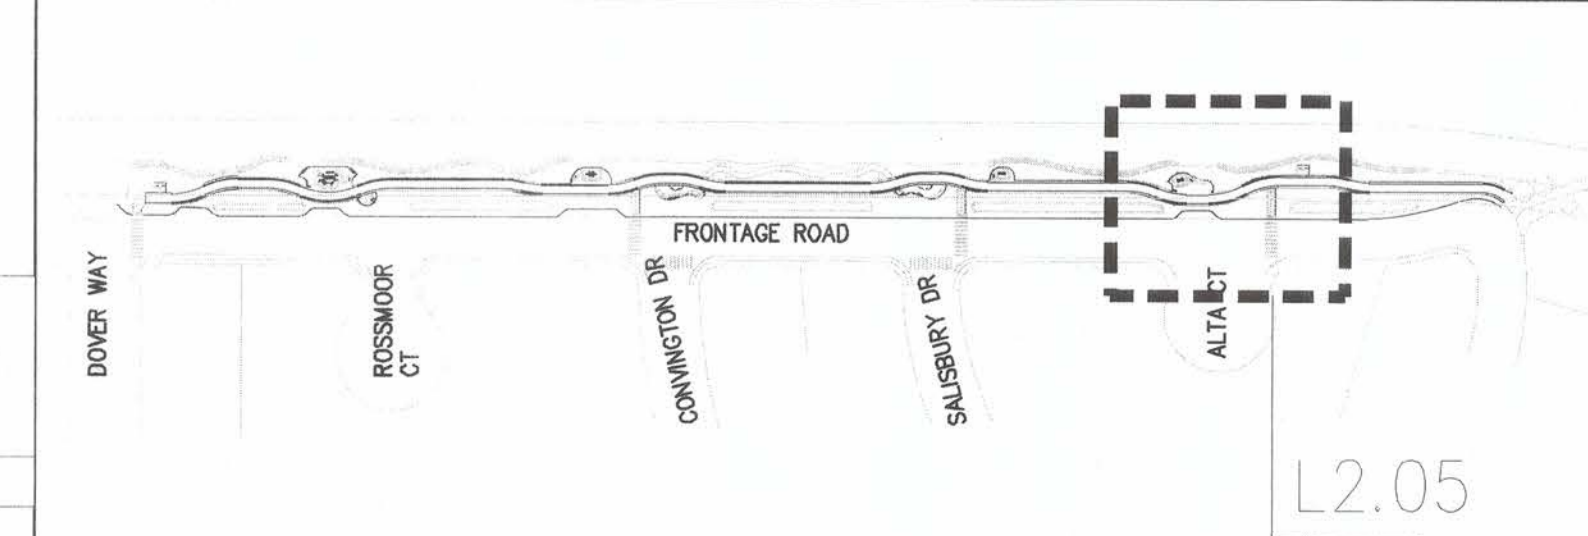

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**FRONTAGE ROAD
 LIVING TRAIL**
 LAYOUT PLAN


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CHECKED: KC	
REVIEWED: KC, TZ	
DATE: 09/05/23	
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DATE	REV	DESCRIPTION



SHEET NO.
37 OF 59
 DWG. NO.
L2.05

1
5.03
2
5.05
3
5.05

MATCHLINE - SEE SHEET L2.05

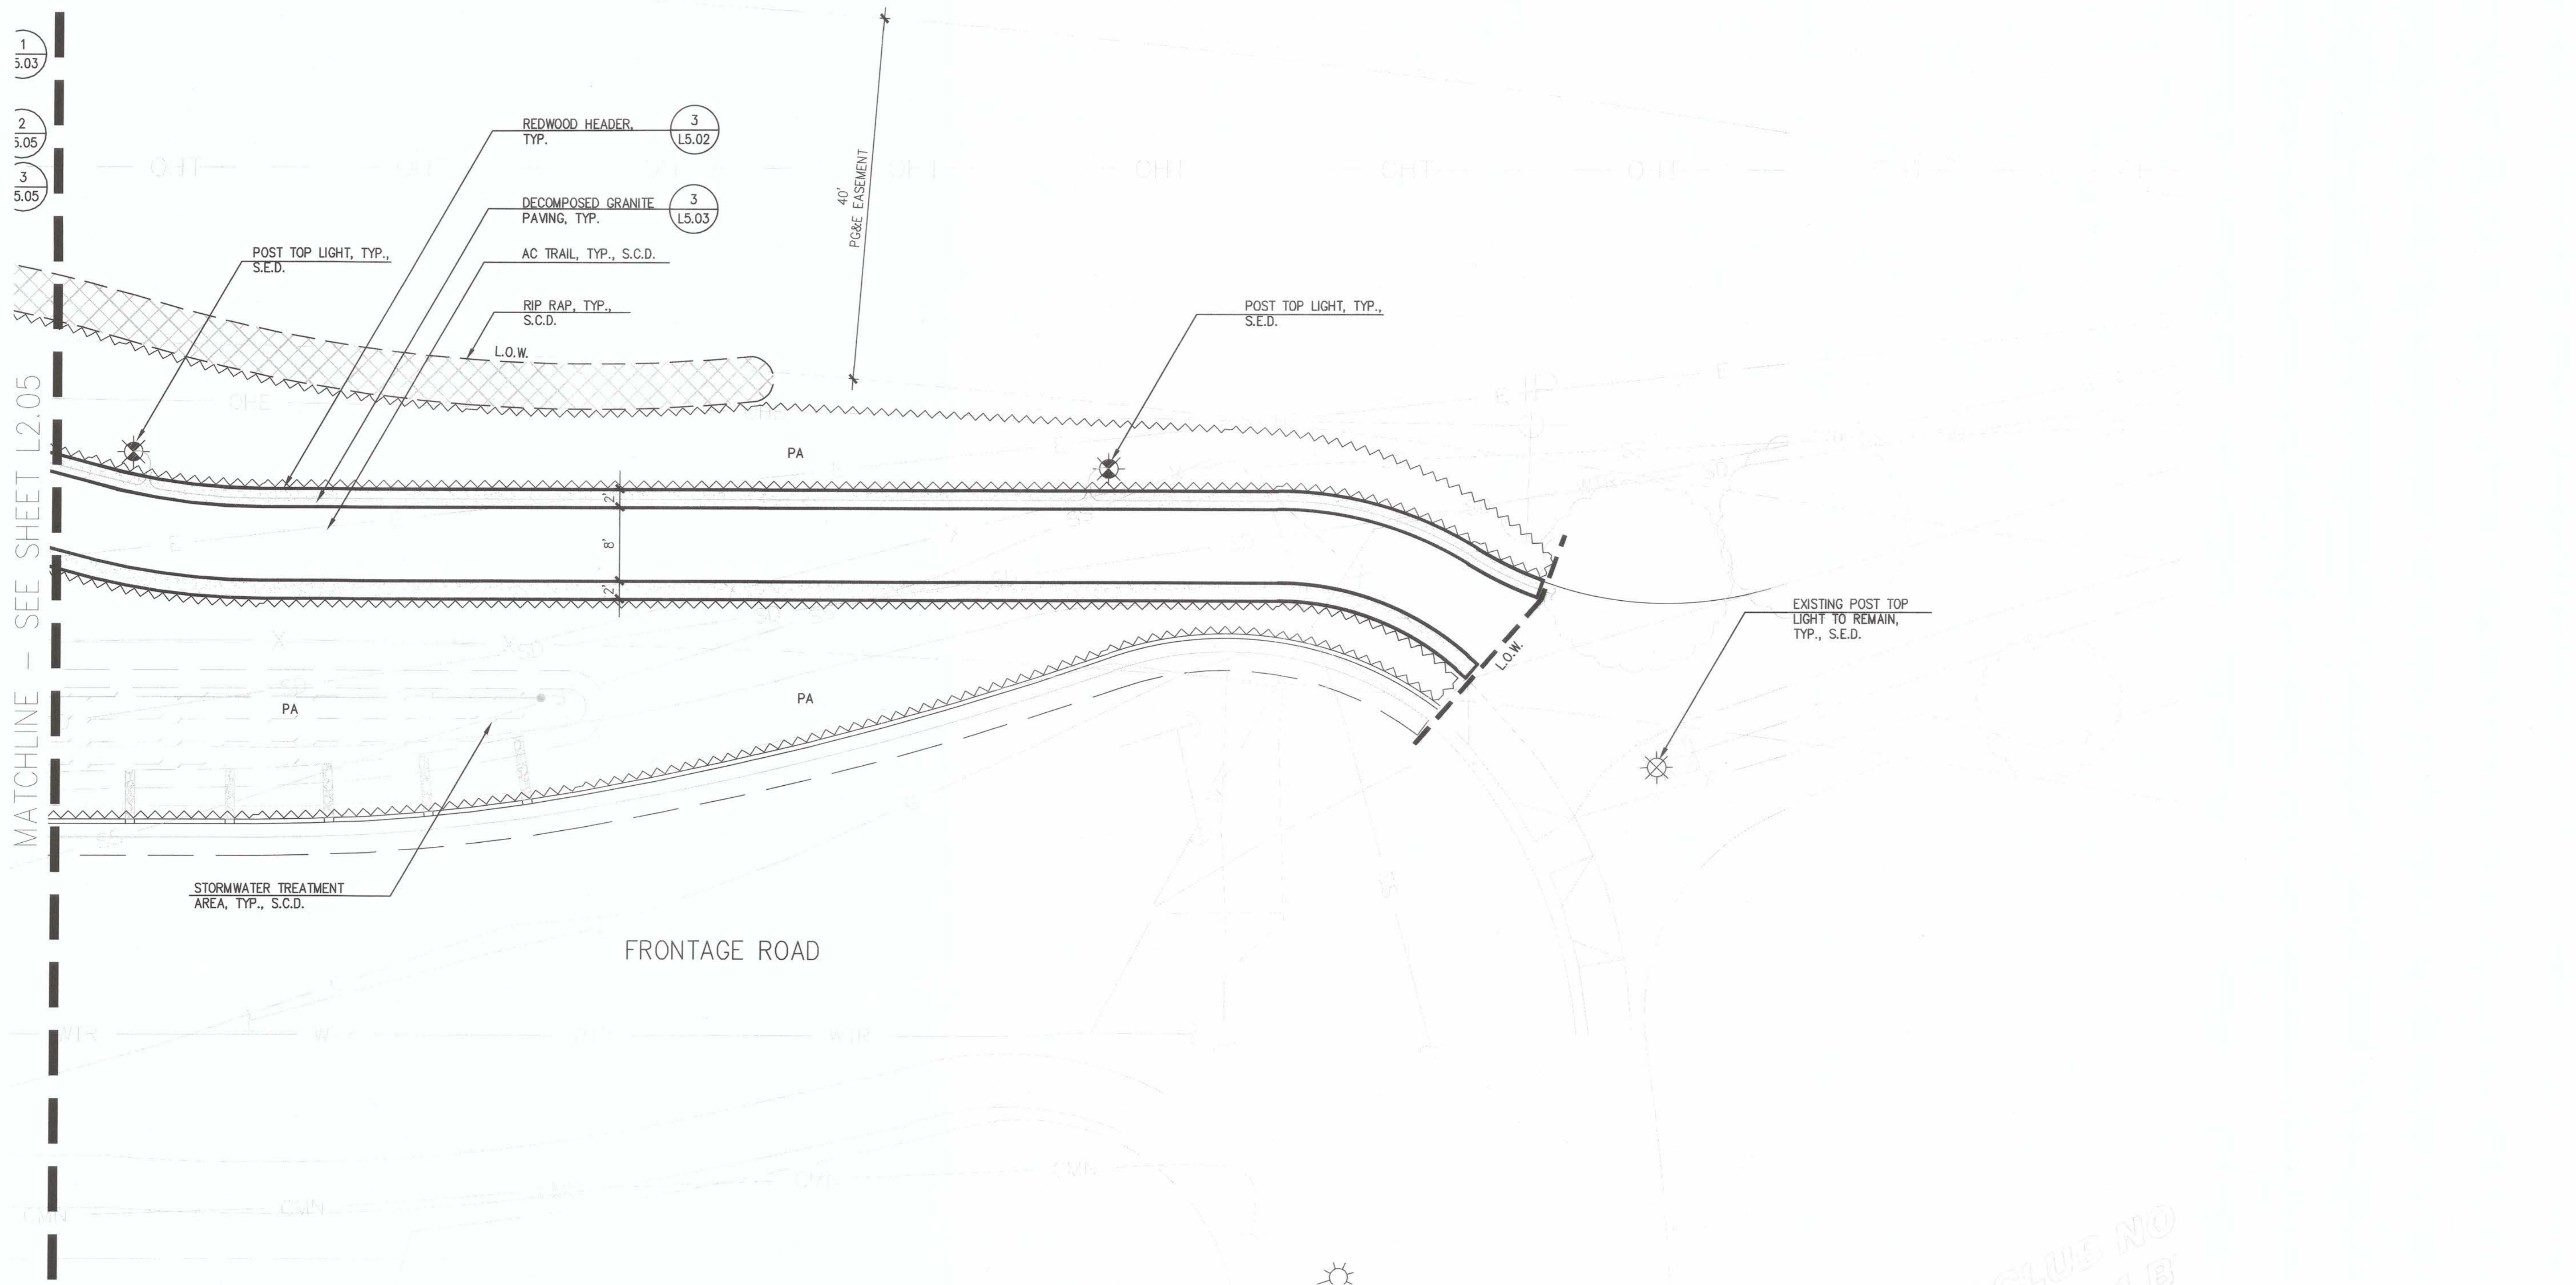

PLUS NO 1 B

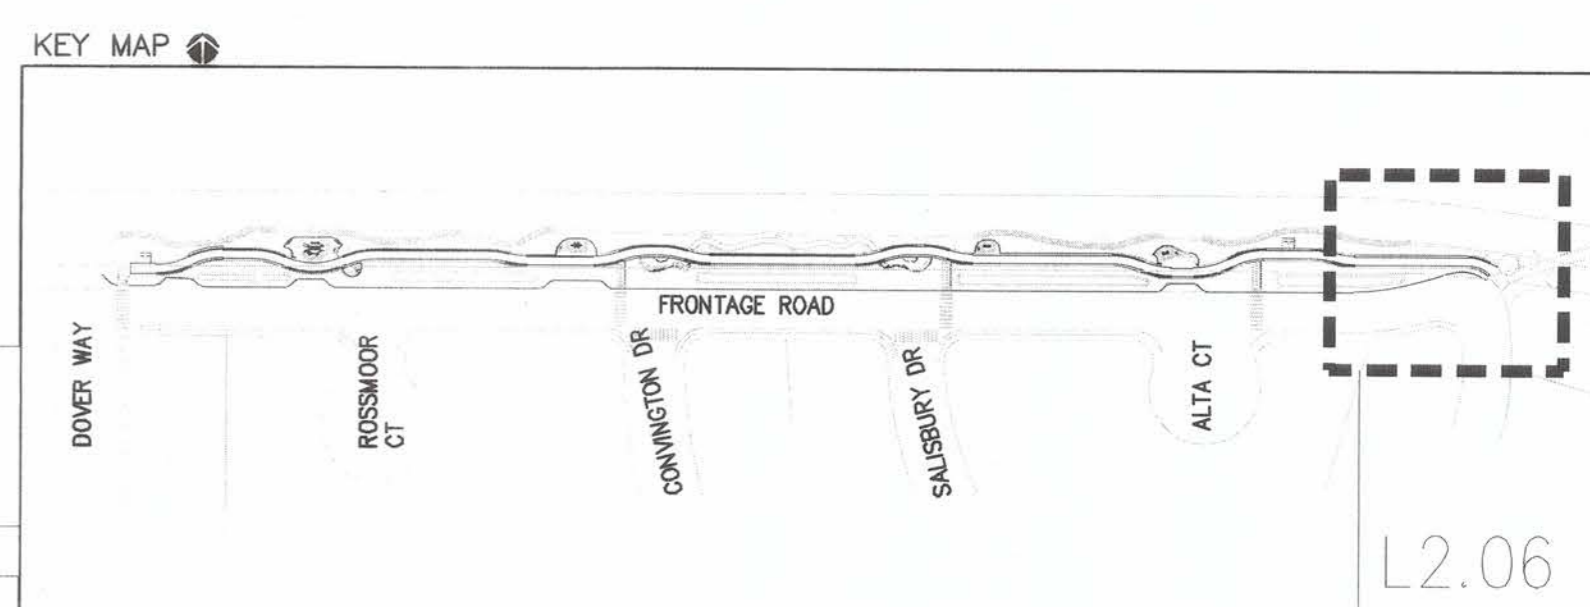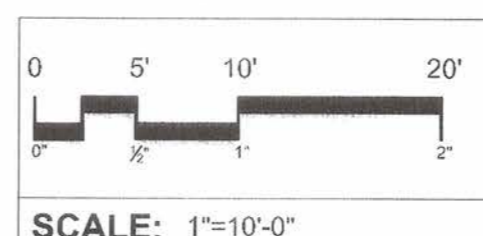

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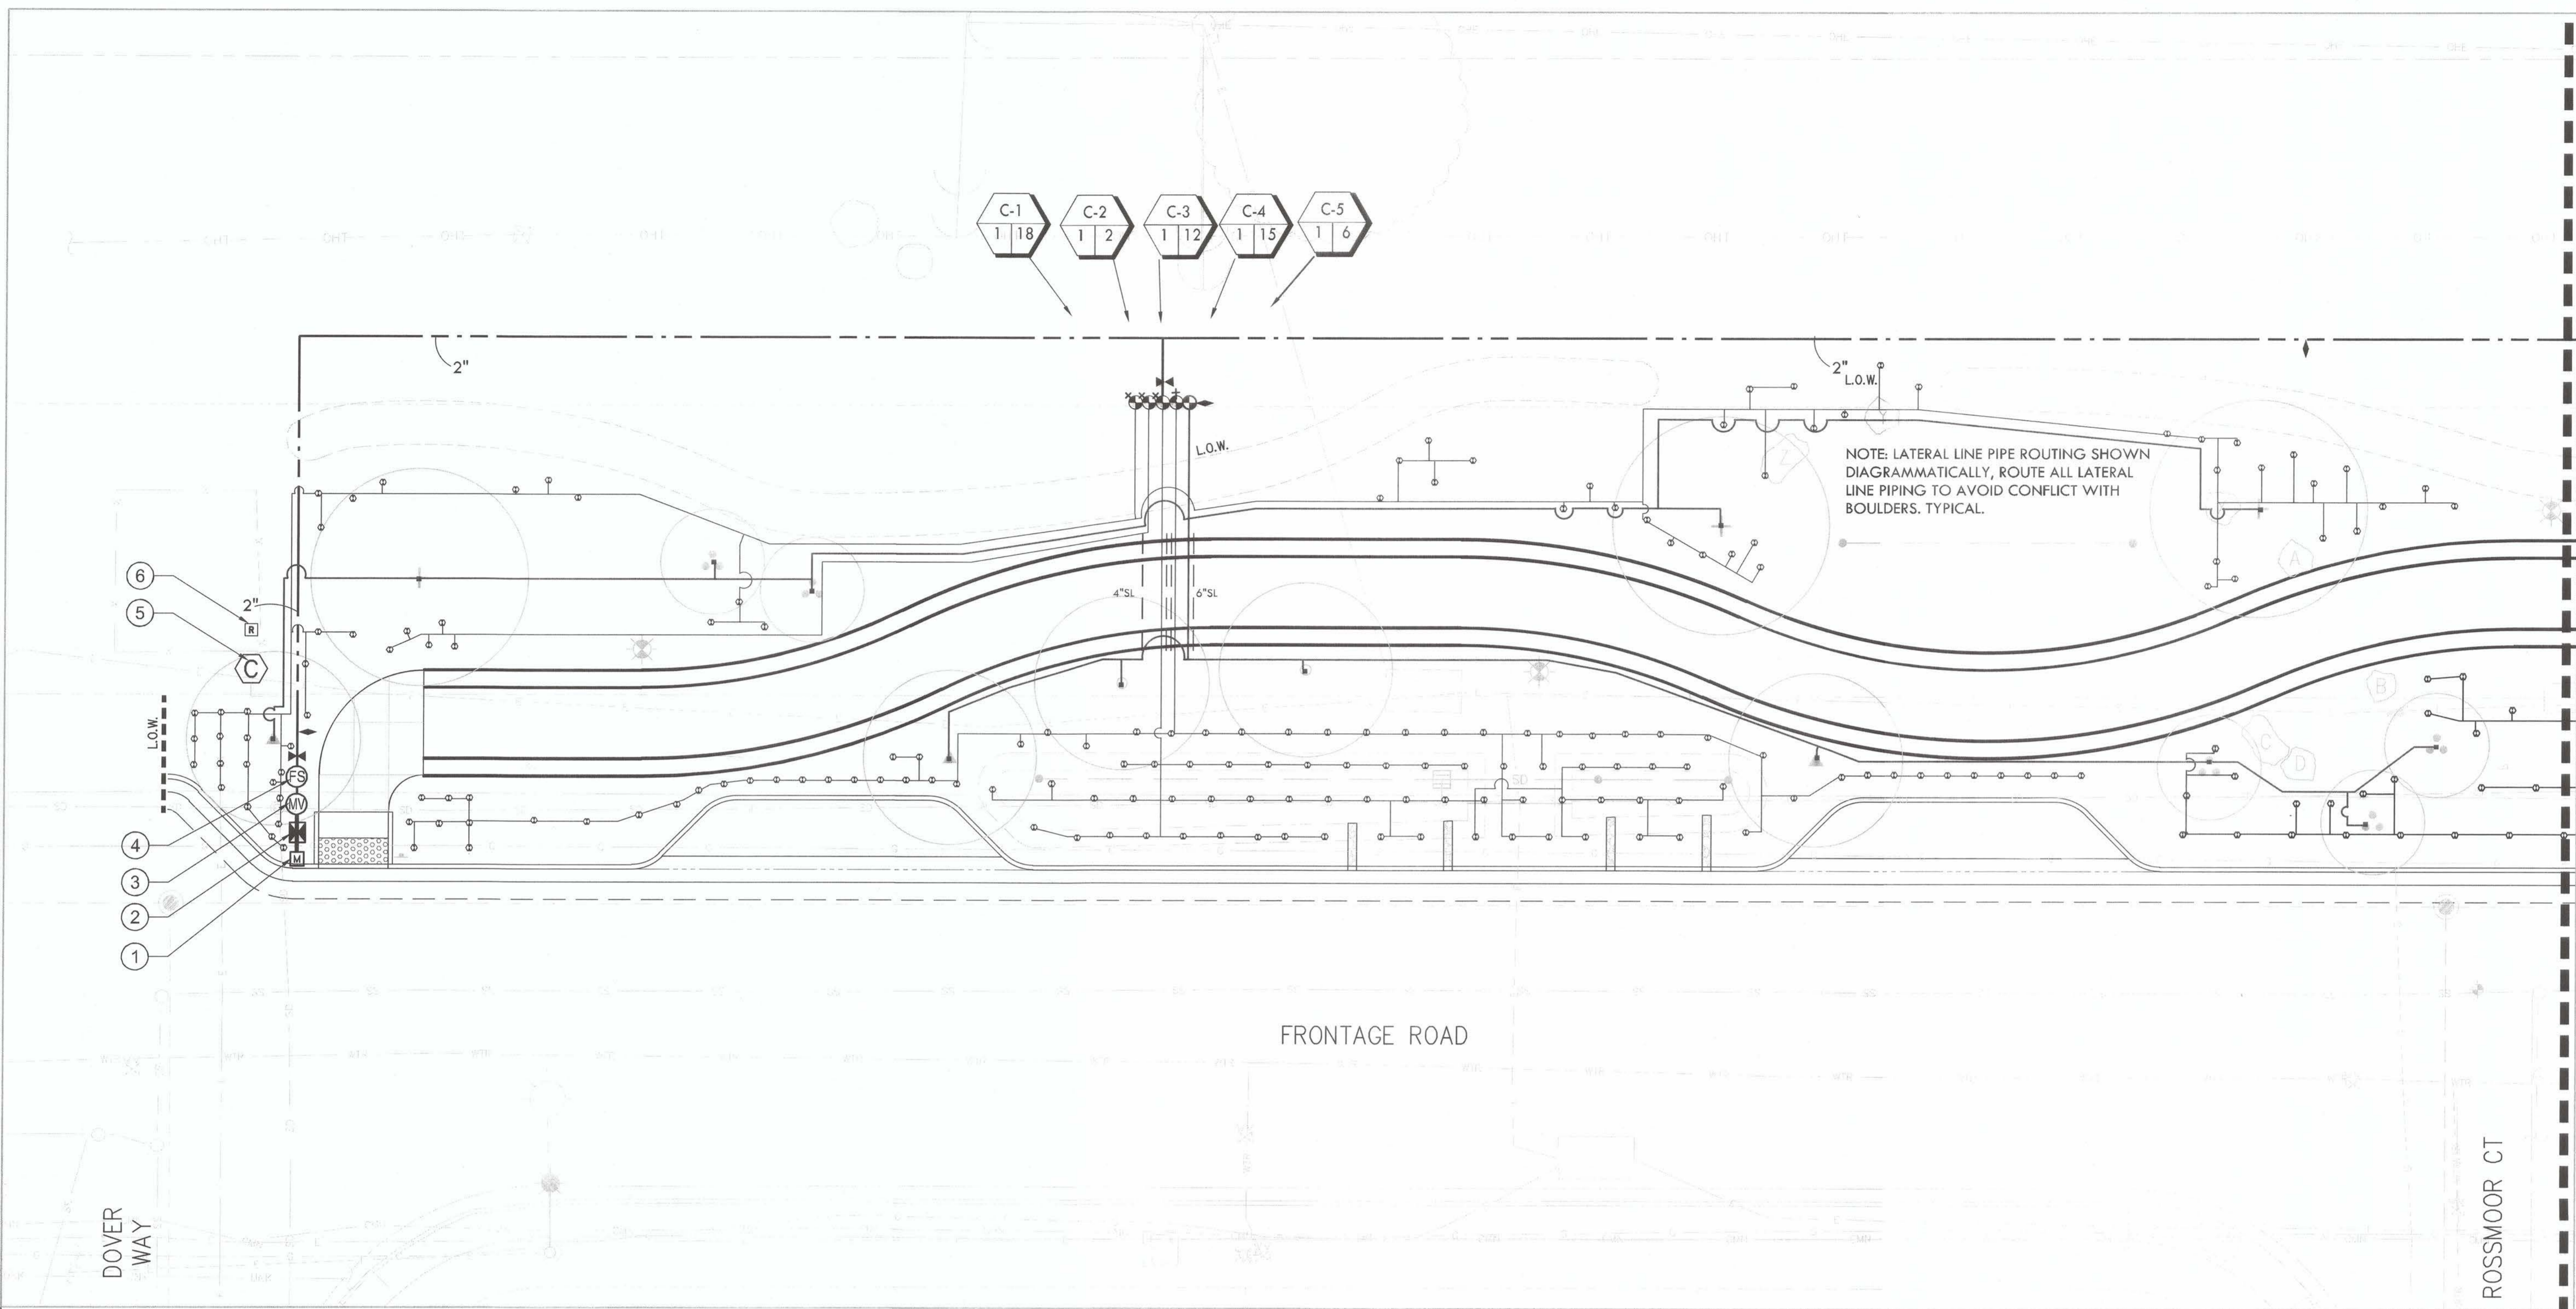
**FRONTAGE ROAD
 LIVING TRAIL**
 LAYOUT PLAN

BY	DRAWN: TZ
	CHECKED: KC
	REVIEWED: KC, TZ
	DATE: 09/05/23
	SCALE: AS SHOWN

DATE	REV	DESCRIPTION

SHEET NO.
38 OF 59

DWG. NO.
L2.06



MATCHLINE - SEE SHEET L3.02

PLAN NOTES LEGEND

- ① 1" WATER METER WITH 1" SERVICE LINE FOR IRRIGATION. REFER TO CIVIL PLANS. MAXIMUM IRRIGATION DEMAND: 30 GPM AT APPROXIMATELY 60 PSI STATIC PRESSURE AT WATER METER LOCATION.
- ② BACKFLOW PREVENTOR FOR IRRIGATION INSTALLED INSIDE ENCLOSURE PER CITY STANDARDS.
- ③ MASTER VALVE.
- ④ FLOW SENSOR. INSTALL PAIGE #18 GAUGE SENSOR CABLE WITHIN 1" PVC CONDUIT BETWEEN FLOW SENSOR AND CONTROLLER.
- ⑤ IRRIGATION CONTROLLER "C" MOUNT ON PEDESTAL AT THIS LOCATION AS DETAILED AND AS DIRECTED BY ARCHITECT. CONNECT TO 120 VOLT A.C. ELECTRICAL SERVICE INSTALLED AT THIS LOCATION UNDER ELECTRICAL CONTRACT. IRRIGATION CONTRACTOR SHALL COORDINATE LOCATION OF ELECTRICAL SERVICE PRIOR TO CONSTRUCTION.
- ⑥ WIRELESS RAIN SENSOR MOUNTED TO BUILDING ROOF EDGE.

NOTES:



1. ONE BUBBLER SYMBOL IS SHOWN AT TREES FOR GRAPHIC CLARITY ONLY. INSTALL MINIMUM TWO BUBBLERS AT EACH TREE. INSTALL REQUIRED NUMBER OF BUBBLERS AS DETAILED.
2. IRRIGATION EQUIPMENT MAY BE SHOWN WITHIN HARDSCAPE FOR GRAPHIC CLARITY ONLY. INSTALL ALL IRRIGATION EQUIPMENT WITHIN PLANTED AREAS. IRRIGATION PIPE AND WIRE CROSSING BENEATH HARDSCAPE SURFACES SHALL BE CONTAINED WITHIN SLEEVING OR SCHEDULE 40 PVC CONDUIT. SLEEVING SIZE SHALL BE A MINIMUM OF TWO TIMES THE AGGREGATE DIAMETER OF ALL PIPES CONTAINED WITH SLEEVE. PROVIDE VERTICAL SWEEP FOR ALL ELECTRICAL CONDUIT ON EACH SIDE OF HARDSCAPE AND TERMINATE ENDS AT 12" MINIMUM DEPTH AND 12" FROM HARDSCAPE SURFACE.
3. UNSIZED LATERAL LINE PIPING LOCATED DOWN STREAM OF 1" PIPING SHALL BE 3/4" IN SIZE (TYPICAL).
4. SIZING OF LATERAL PIPE SHALL BE AS FOLLOWS:

0.75"	0-6 GPM
1"	7-12 GPM
1.25"	13-20 GPM
1.5"	21-32 GPM

NOTE: LATERAL LINE PIPE ROUTING SHOWN DIAGRAMMATICALLY, ROUTE ALL LATERAL LINE PIPING TO AVOID CONFLICT WITH BOULDERS. TYPICAL.

Irrigation Consultant:
Russell D. Mitchell Associates, Inc.
 2760 Camino Diablo
 Walnut Creek, CA 94597
 tel 925.939.3985 ♦ fax 925.932.5671
 www.rmairrigation.com

KEY MAP

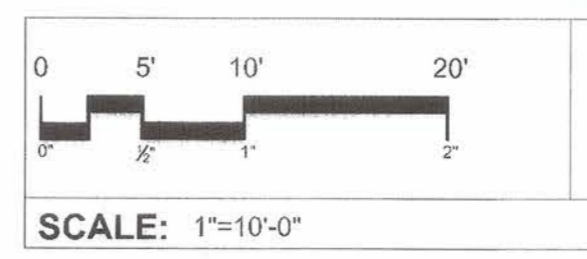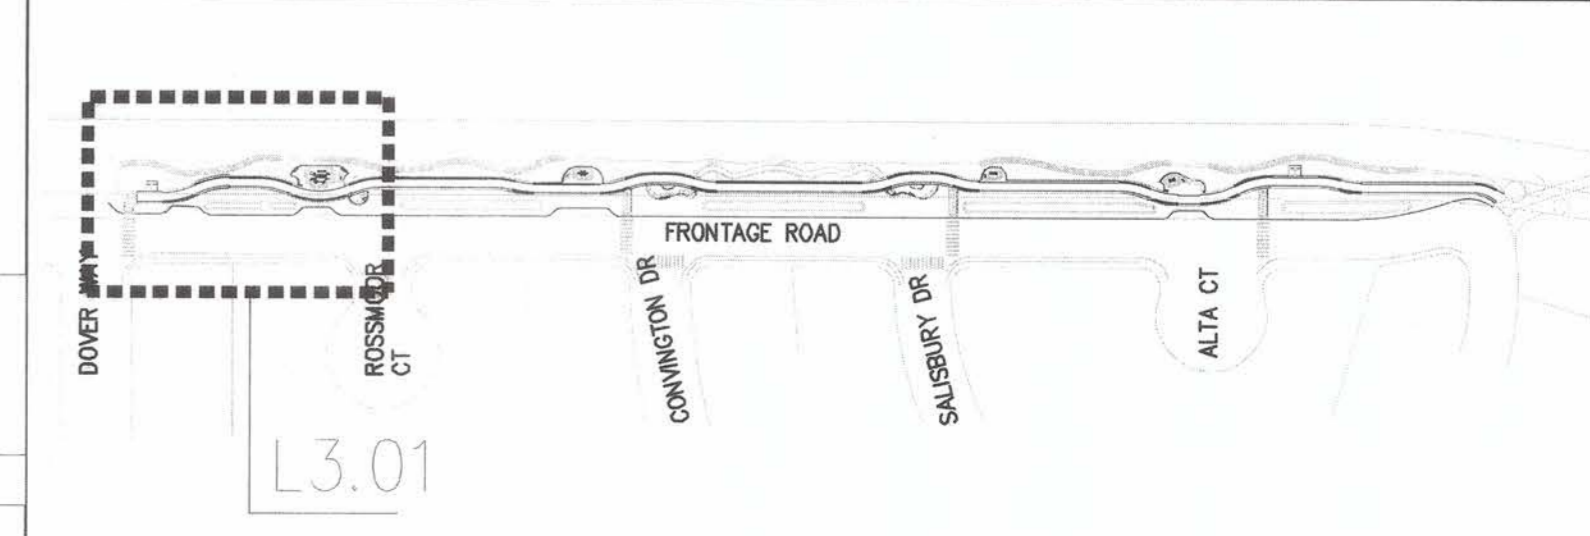

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 PITTSBURGH, PA 15222

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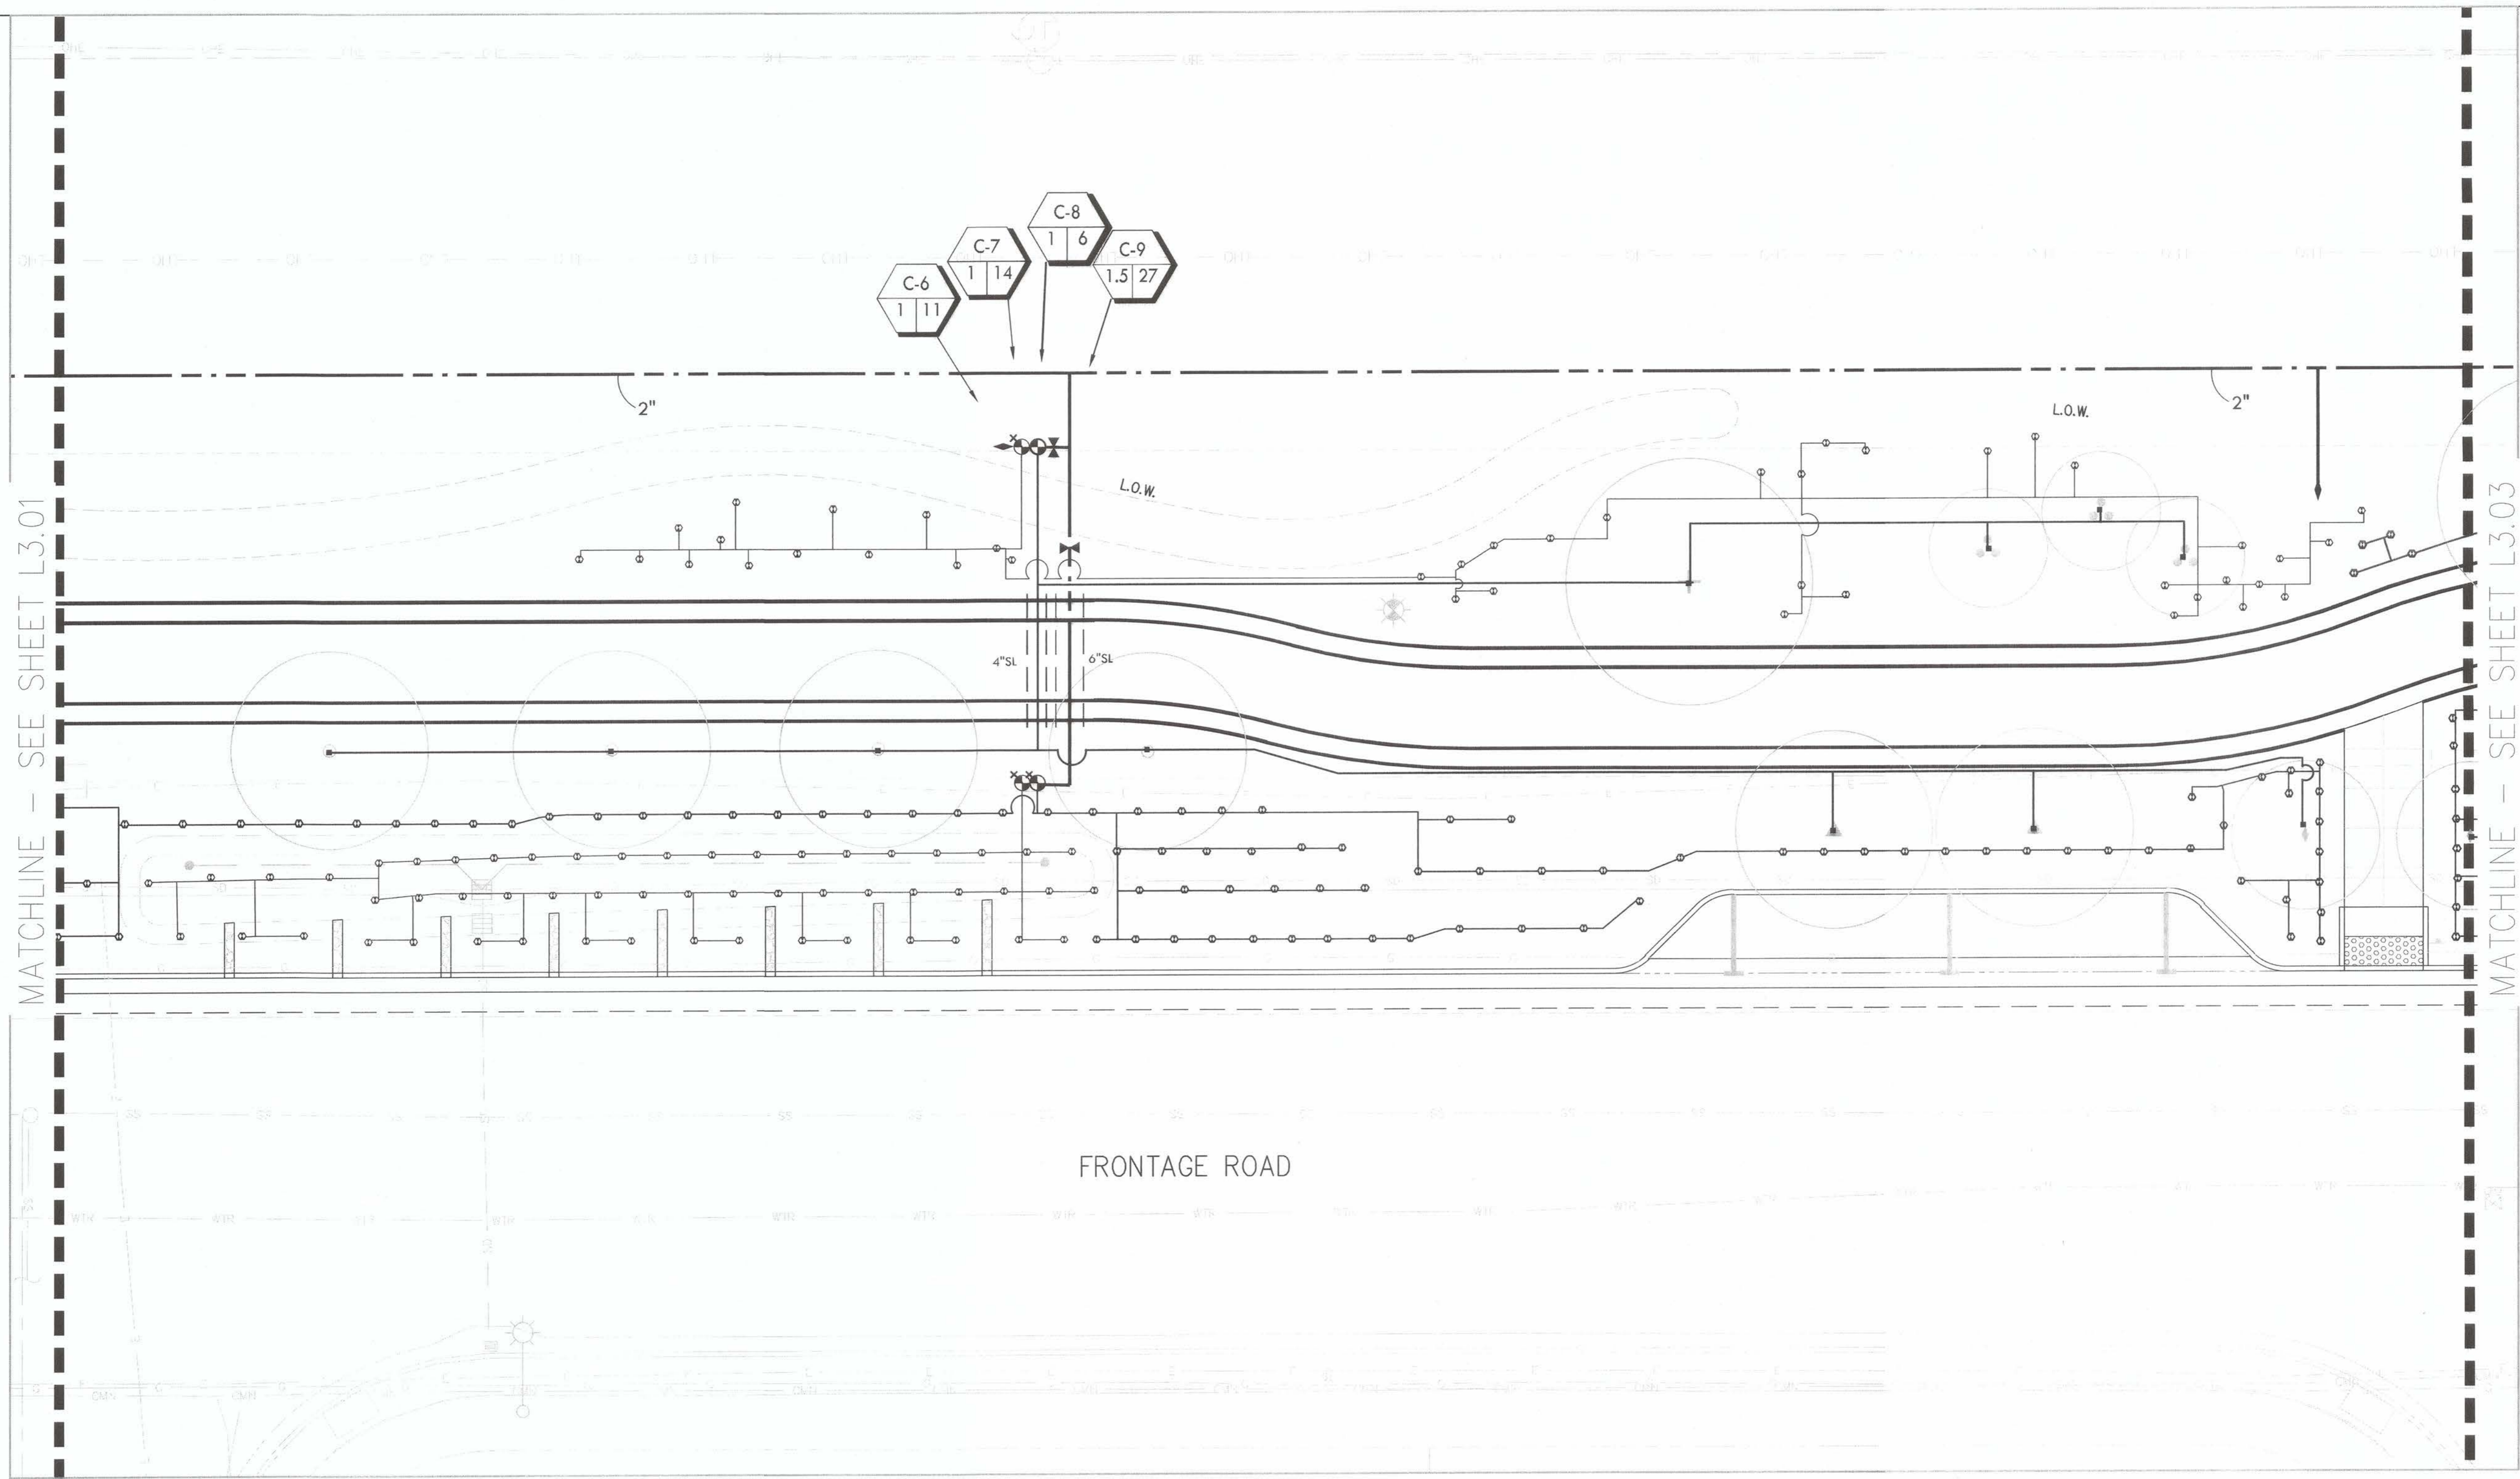
 JOHN SAMUELSON
 City Engineer
 Date: 9/26/23



FRONTAGE ROAD LIVING TRAIL
 IRRIGATION PLAN

BY	DESCRIPTION	DATE	REV
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			SCALE: AS SHOWN


SHEET NO.
39 OF 59
 DWG. NO.
L3.01




MATCHLINE - SEE SHEET L3.01

MATCHLINE - SEE SHEET L3.03

FRONTAGE ROAD

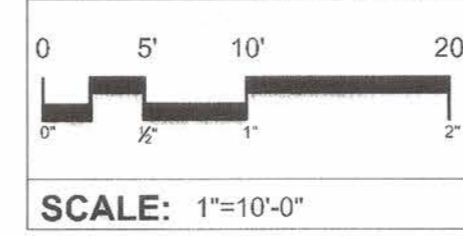

KEY MAP

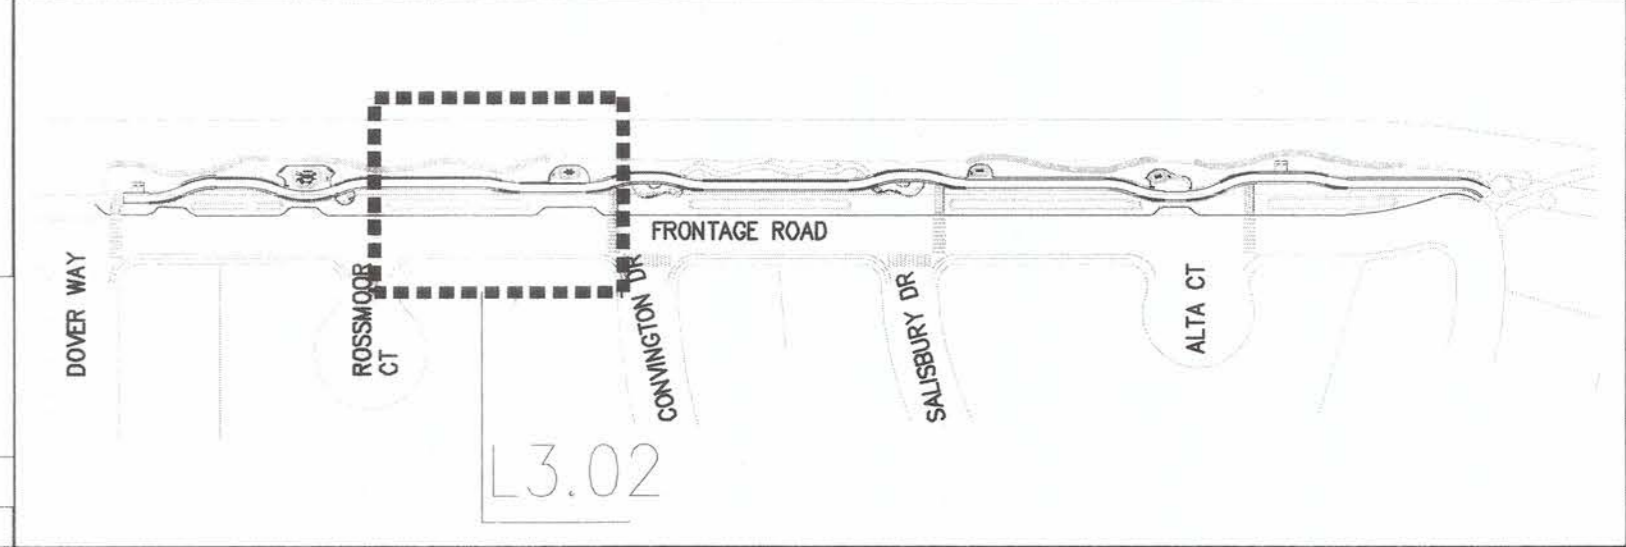

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 2760 Camino Diablo
 Walnut Creek, CA 94597
 tel 925.939.3985 ♦ fax 925.932.5671
 www.rmairrigation.com



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 1800 W. HUNT STREET, WILMINGTON, CA 94096
 TEL: 925.735.8775 WWW: GATES.COM

ACCEPTED FOR USE:

JOHN SAMUELSON
 City Engineer
 Date: 9/24/23



**FRONTAGE ROAD
 LIVING TRAIL**
 IRRIGATION PLAN


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DATE	REV	DESCRIPTION

SHEET NO.
40 OF 59
 DWG. NO.
L3.02

MATCHLINE - SEE SHEET L3.02



MATCHLINE - SEE SHEET L3.04

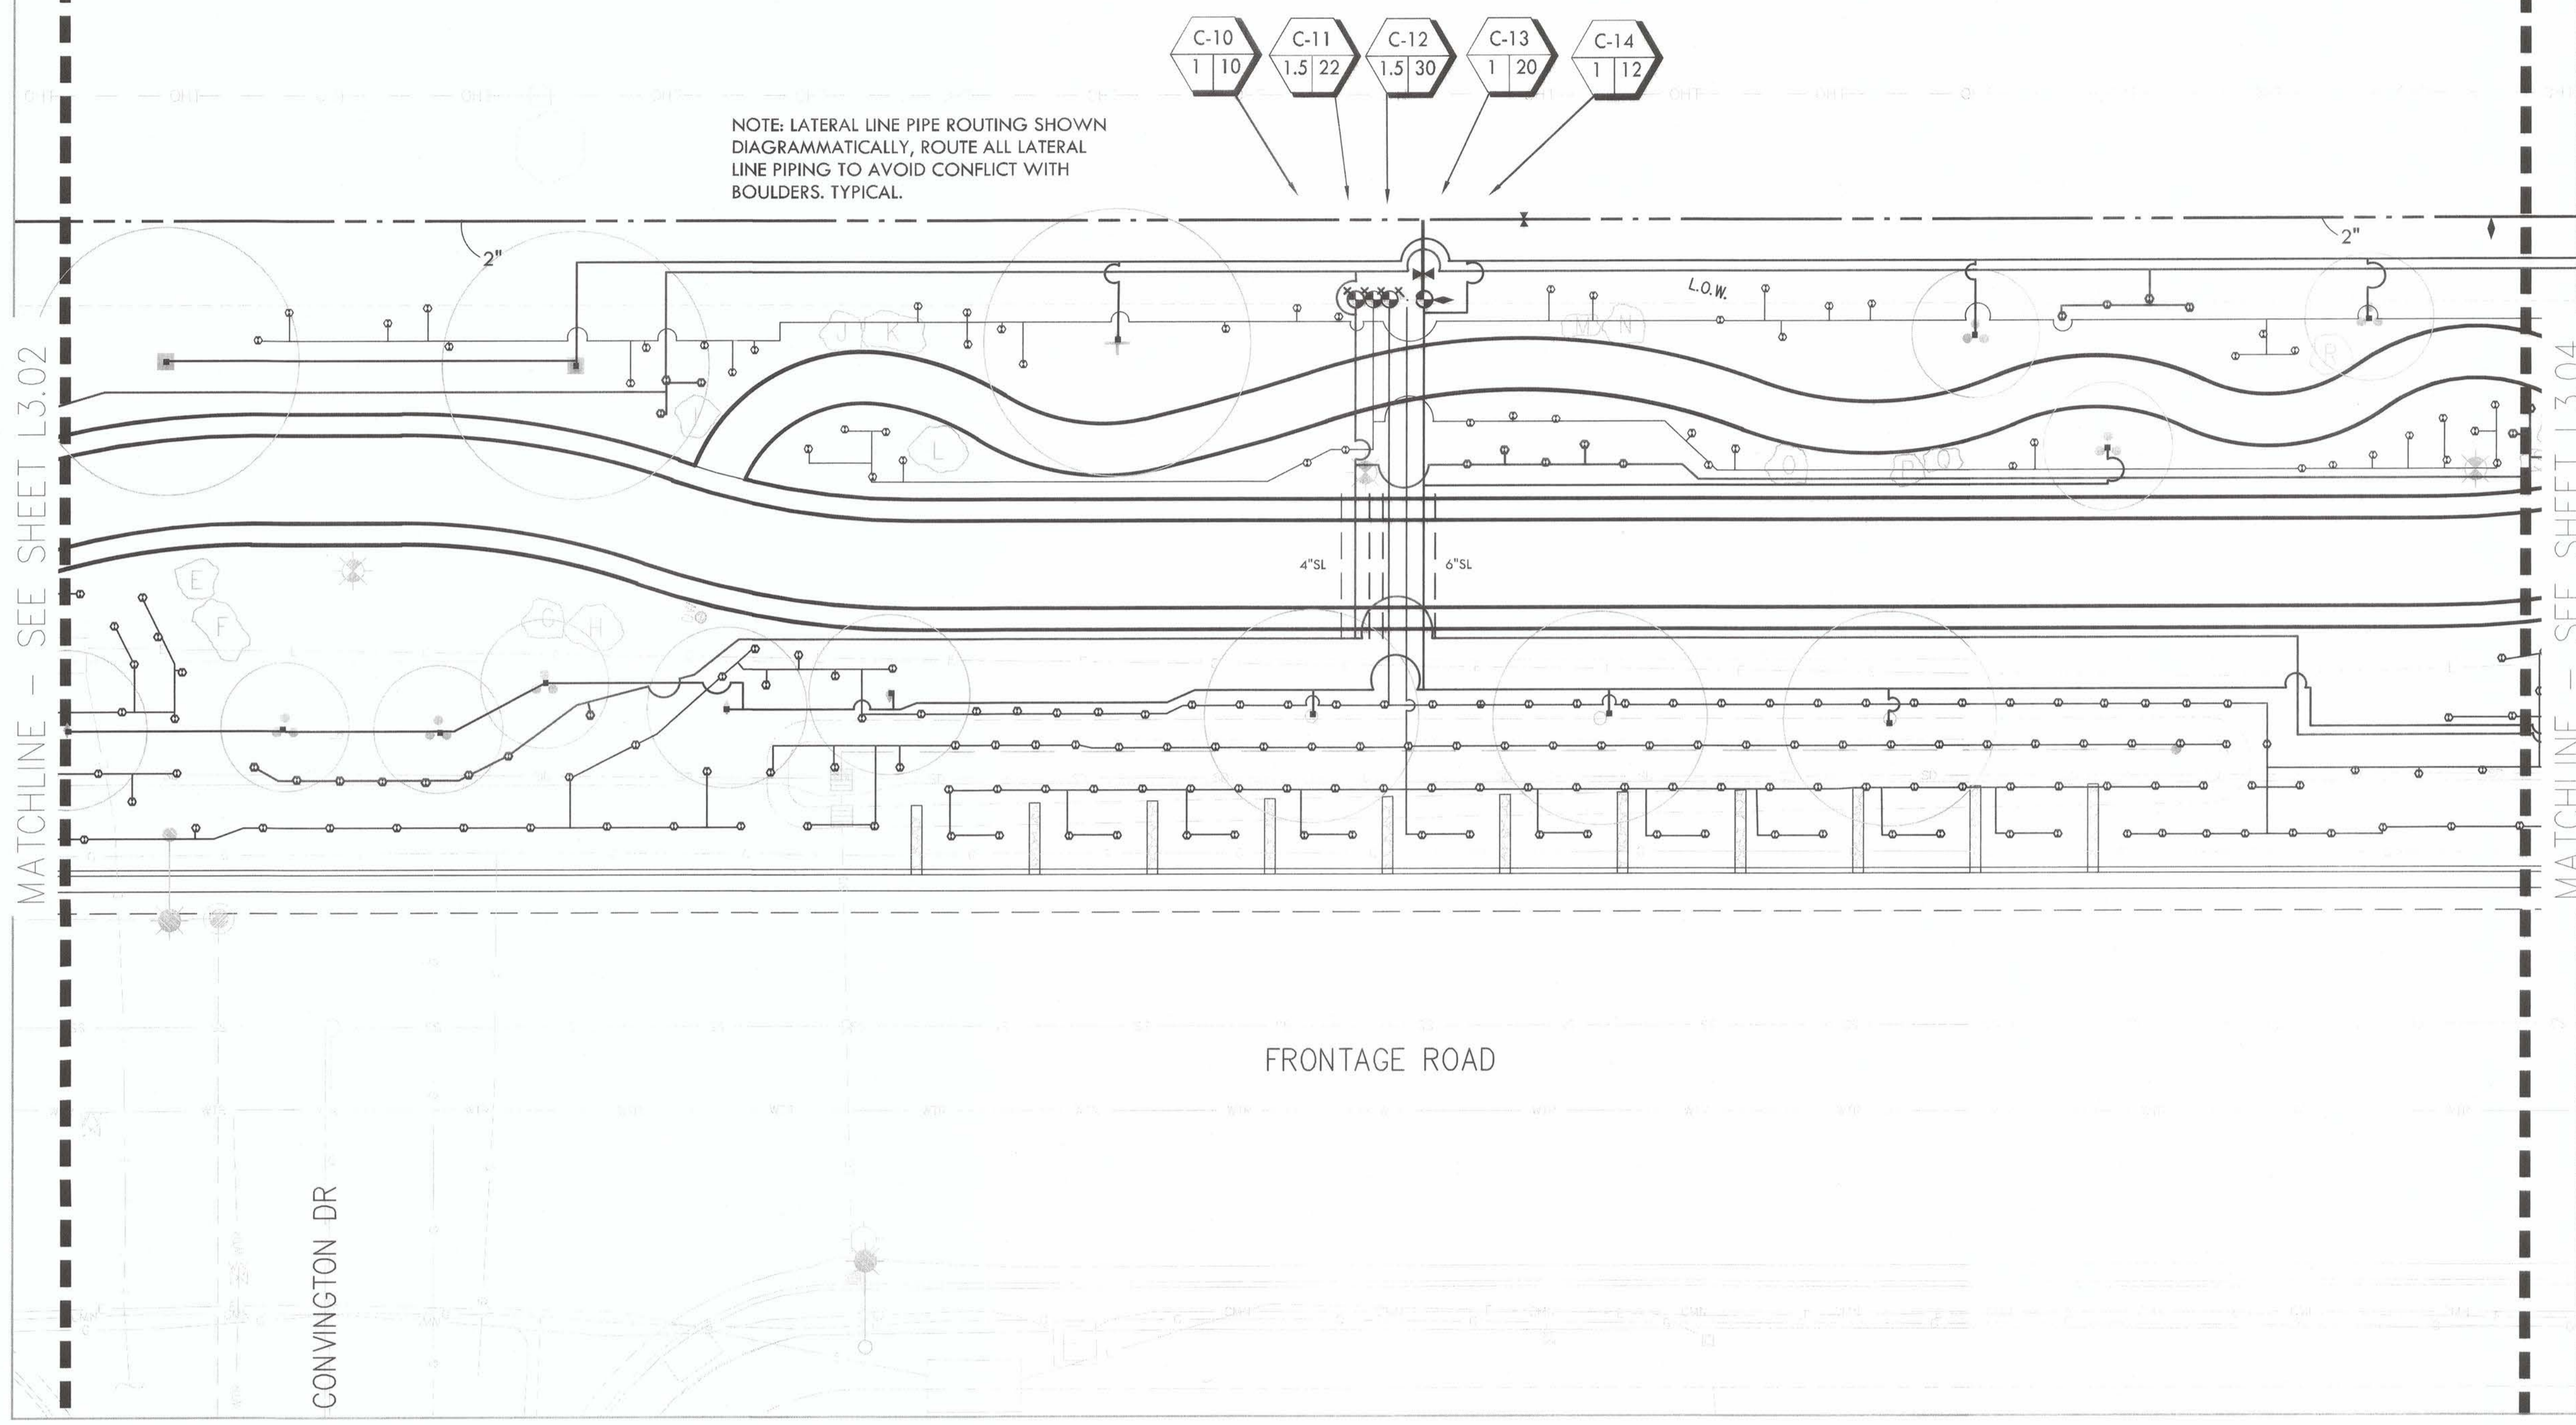

NOTE: LATERAL LINE PIPE ROUTING SHOWN
 DIAGRAMMATICALLY, ROUTE ALL LATERAL
 LINE PIPING TO AVOID CONFLICT WITH
 BOULDERS. TYPICAL.

FRONTAGE ROAD

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SHEET NO.
41 OF 59
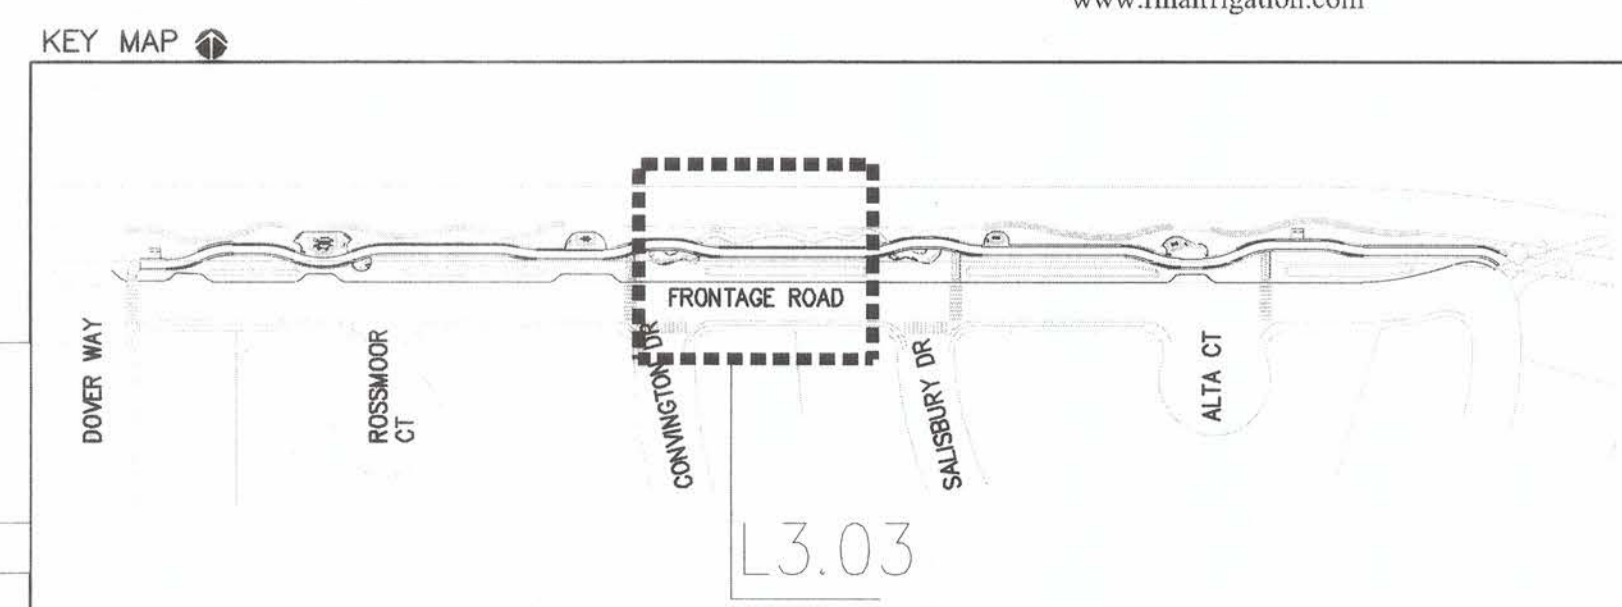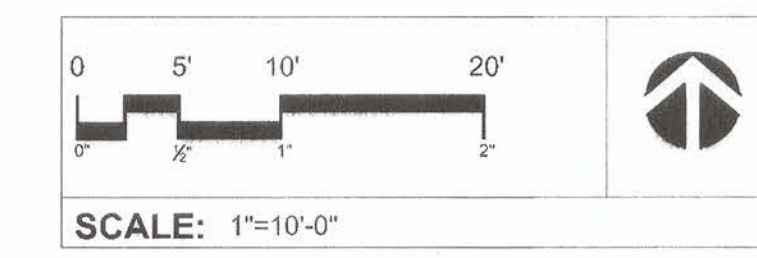
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**FRONTAGE ROAD
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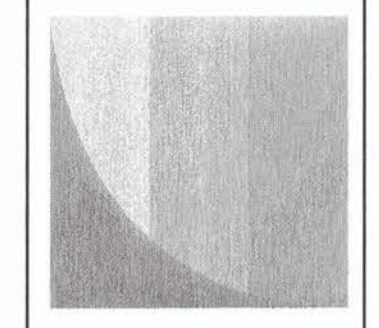
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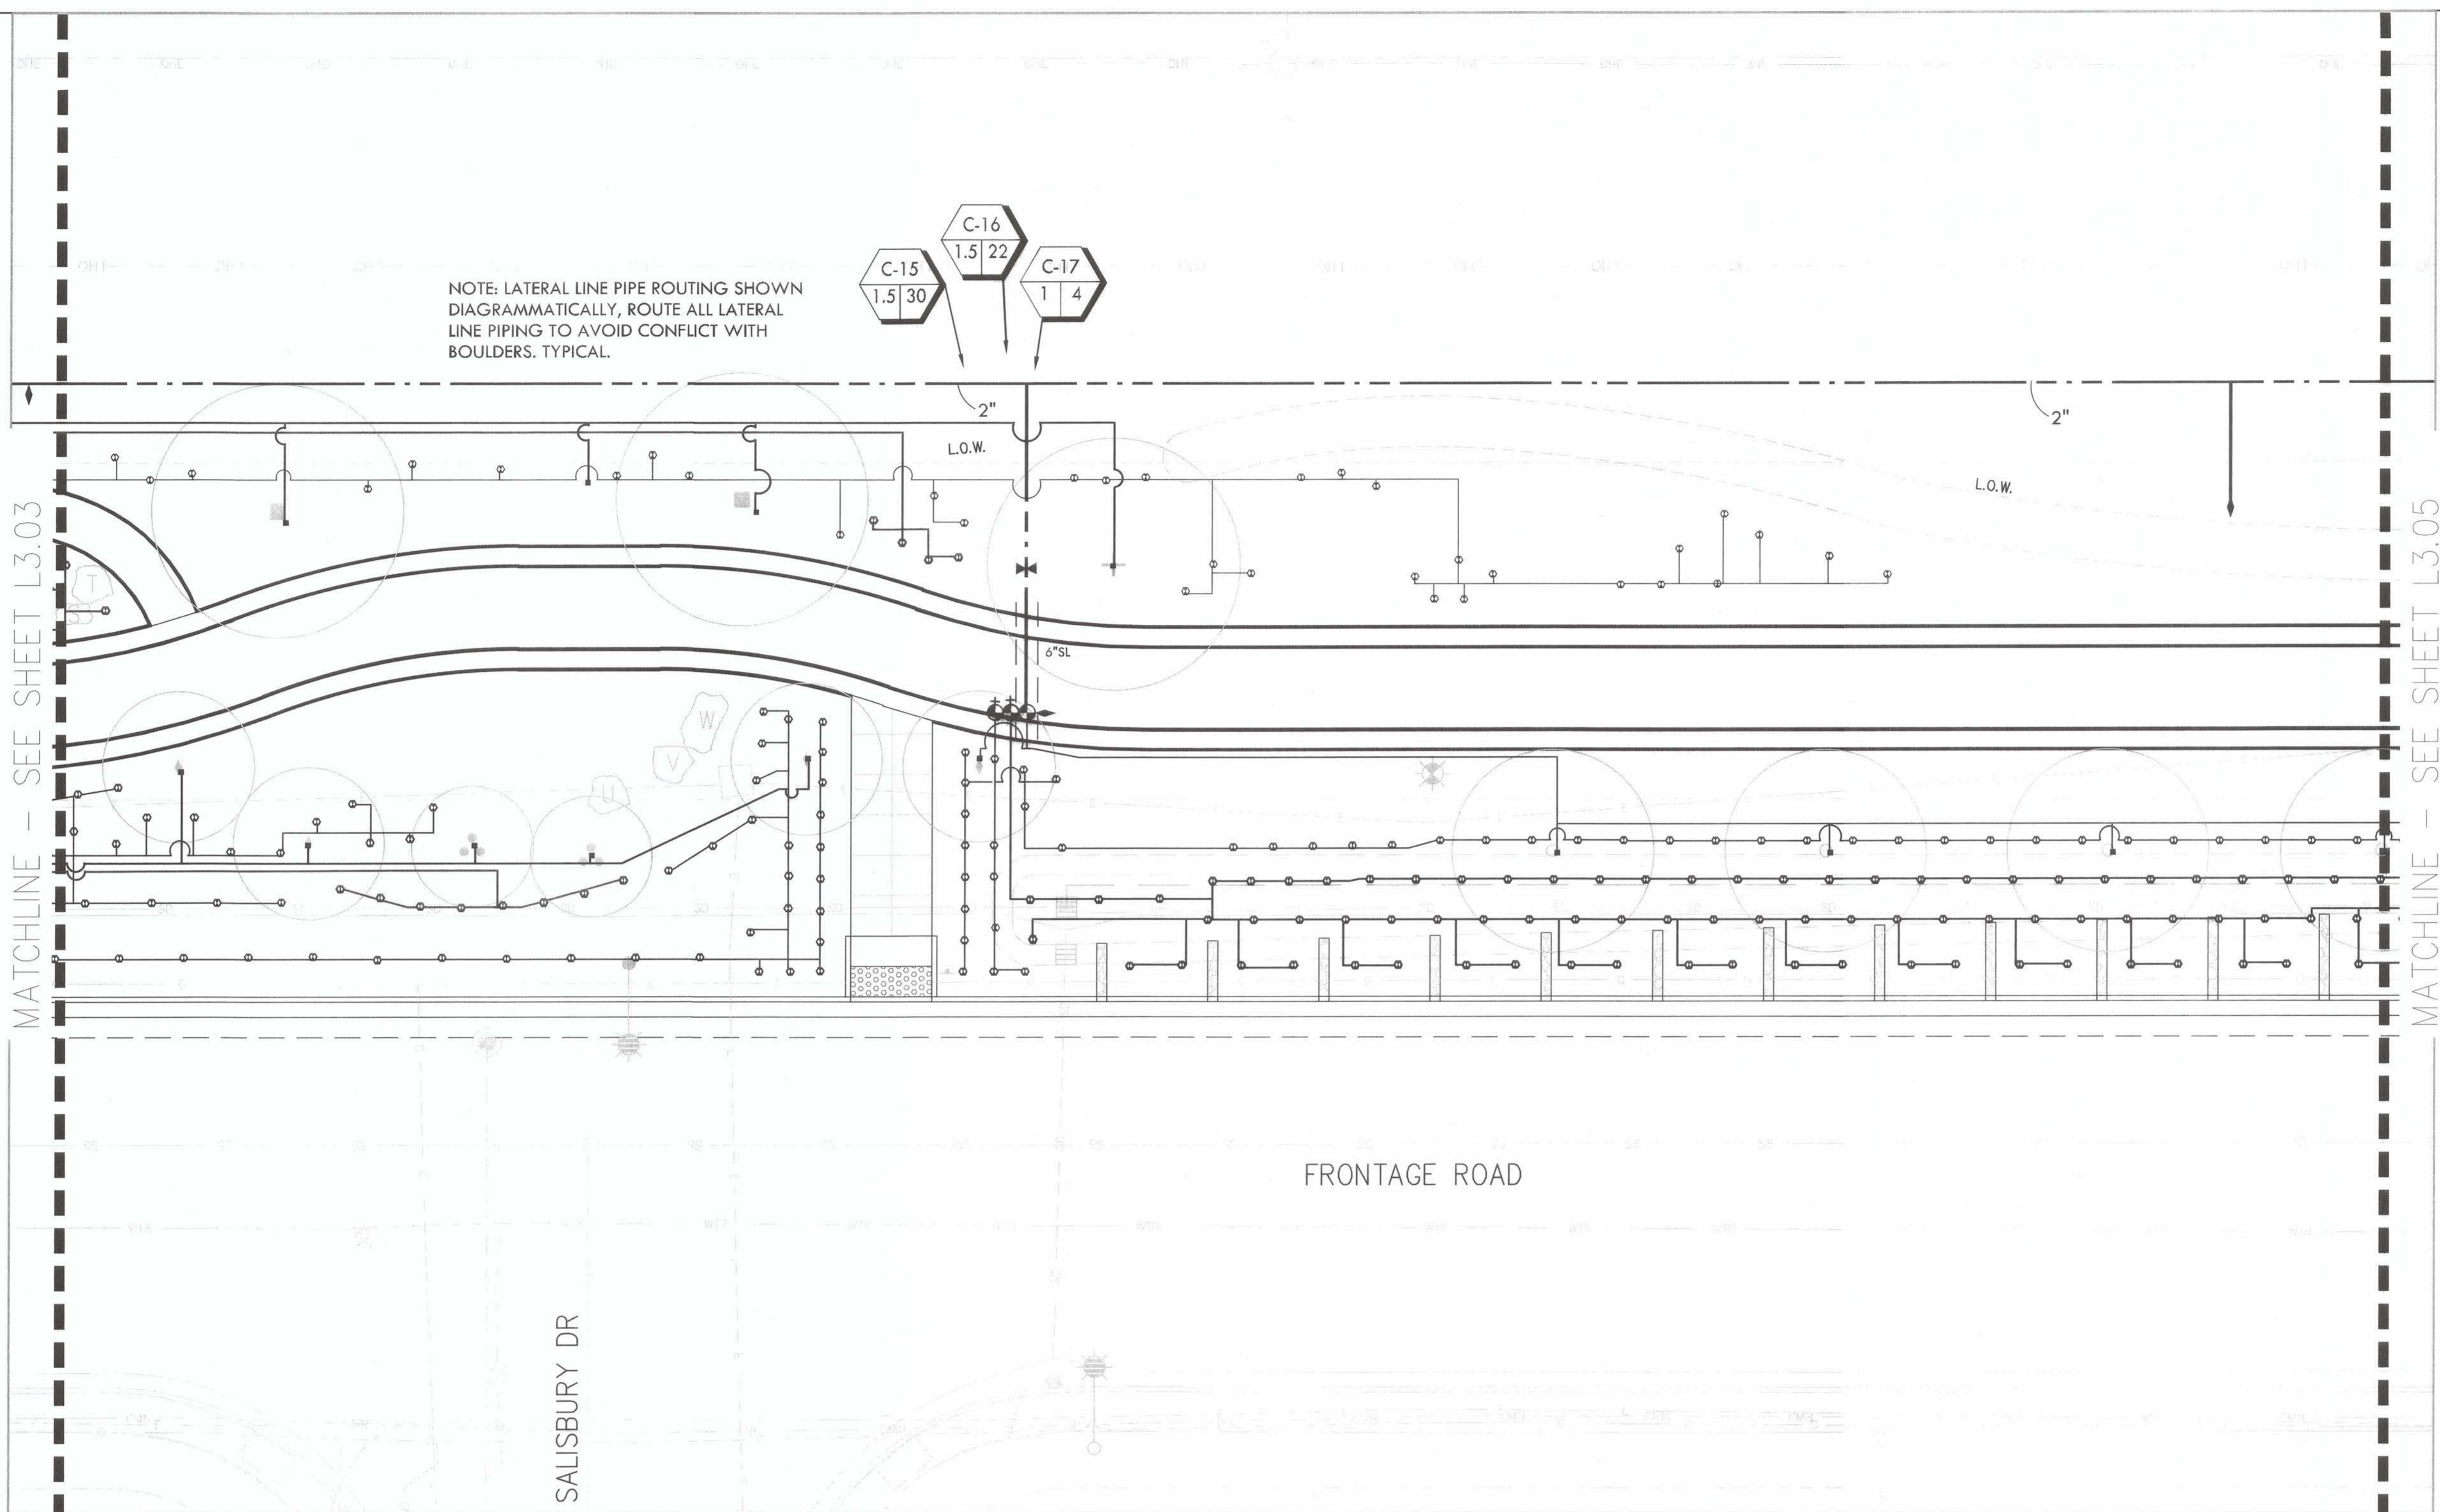


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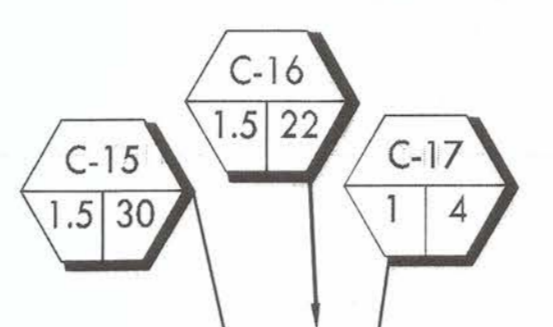
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NOTE: LATERAL LINE PIPE ROUTING SHOWN
DIAGRAMMATICALLY, ROUTE ALL LATERAL
LINE PIPING TO AVOID CONFLICT WITH
BOULDERS, TYPICAL.





MATCHLINE - SEE SHEET L3.03

MATCHLINE - SEE SHEET L3.05

FRONTAGE ROAD

SALISBURY DR

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L3.04

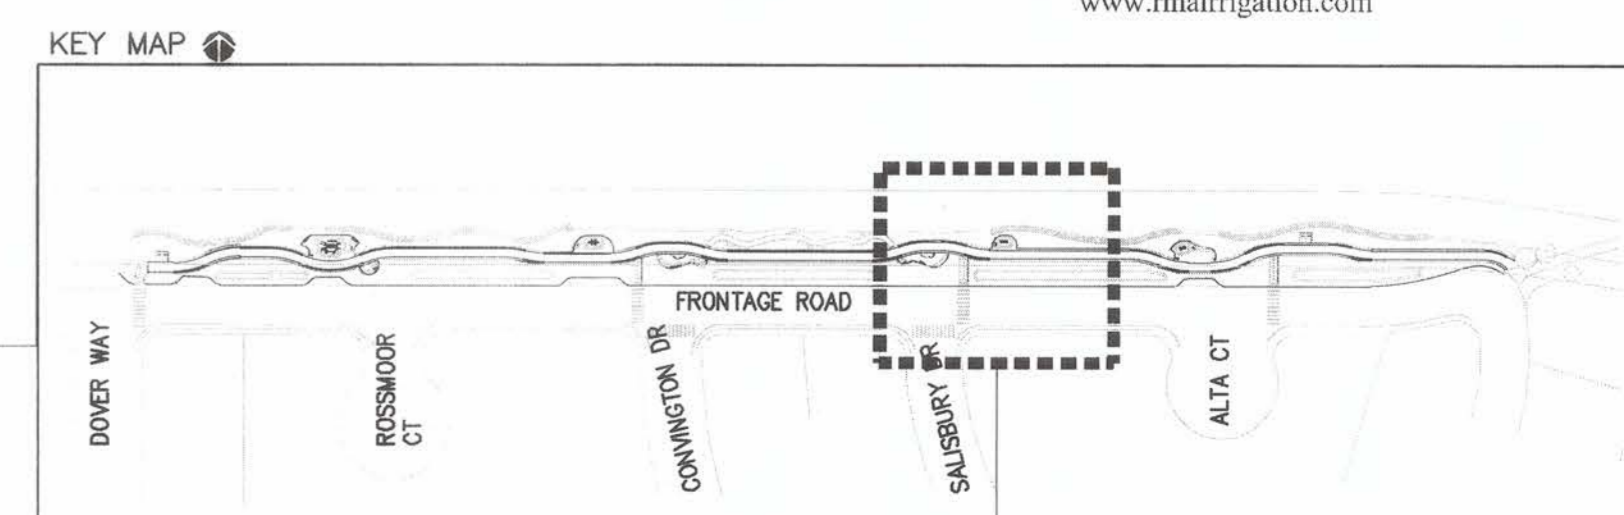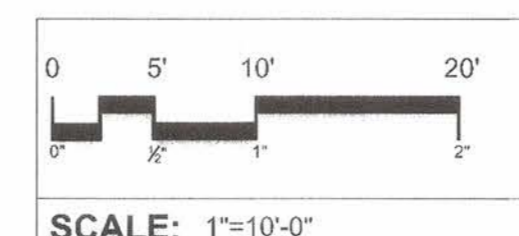

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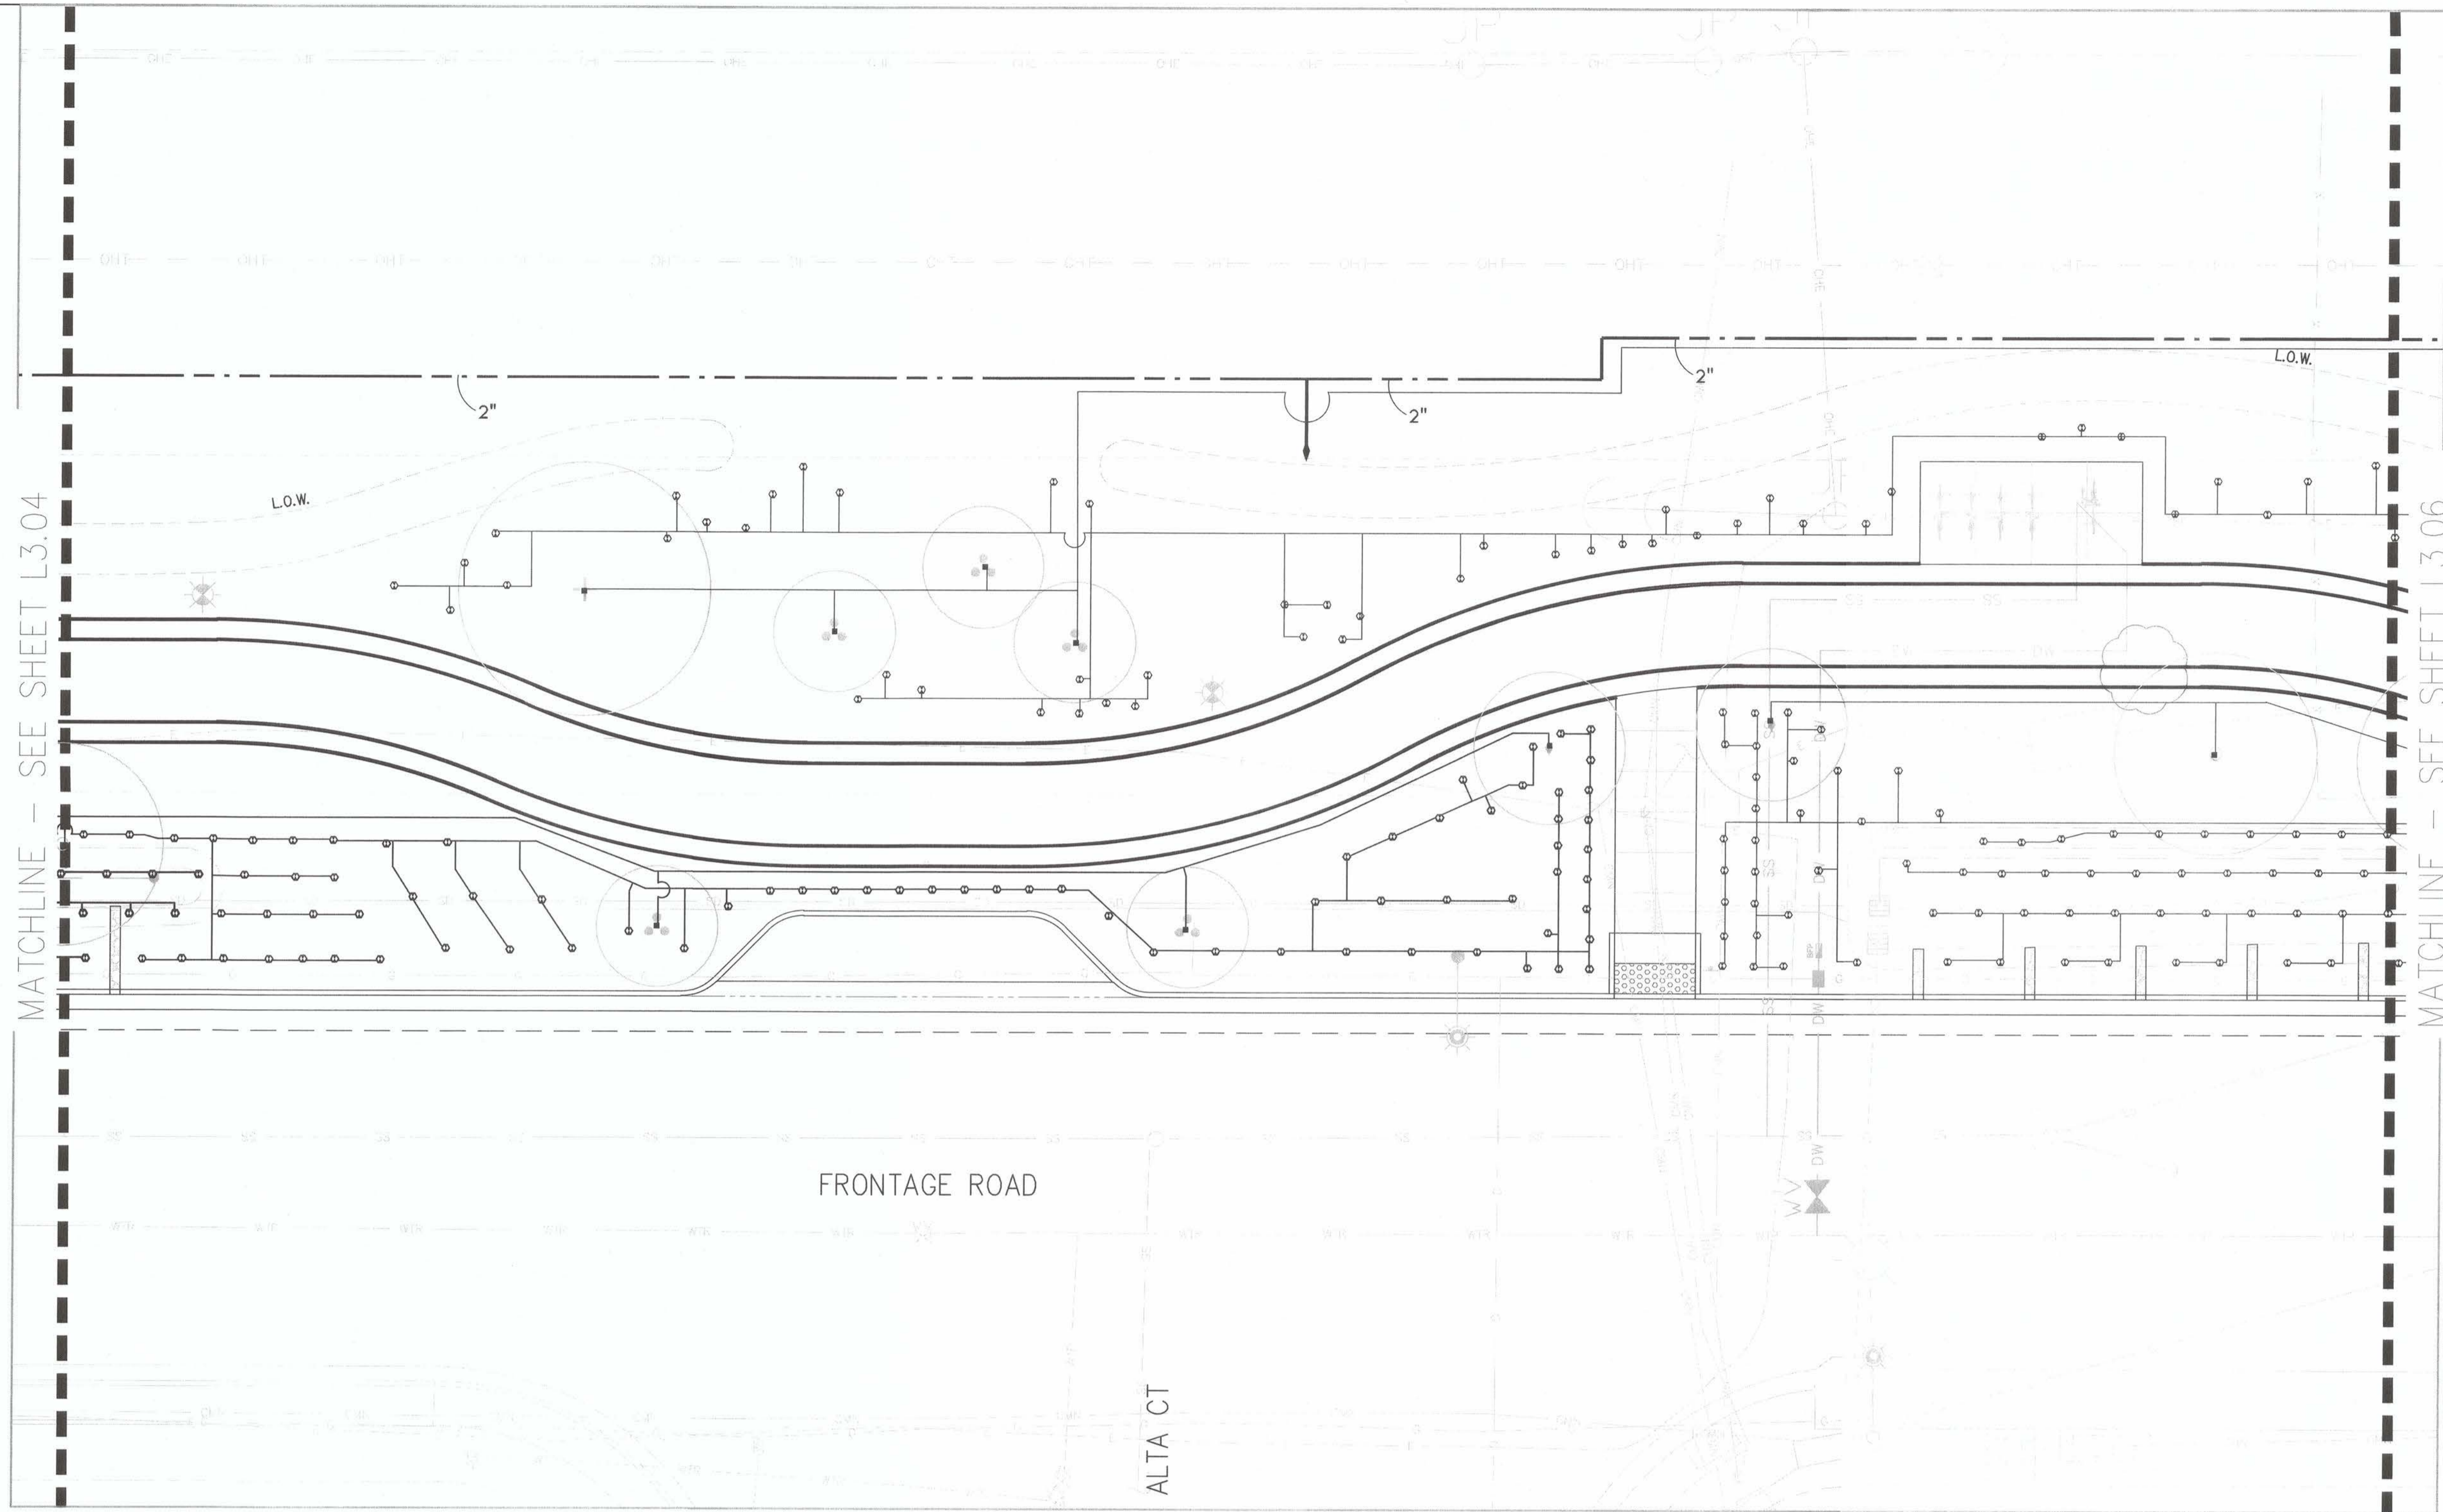


**FRONTAGE ROAD
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IRRIGATION PLAN

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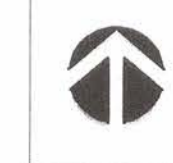
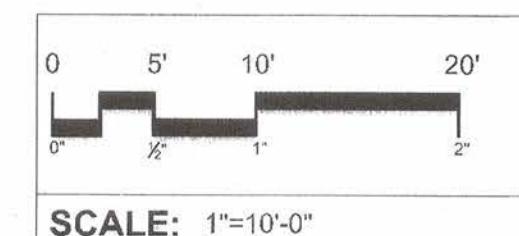


MATCHLINE - SEE SHEET L3.04


MATCHLINE - SEE SHEET L3.06

FRONTAGE ROAD

ALTA CT



KEY MAP

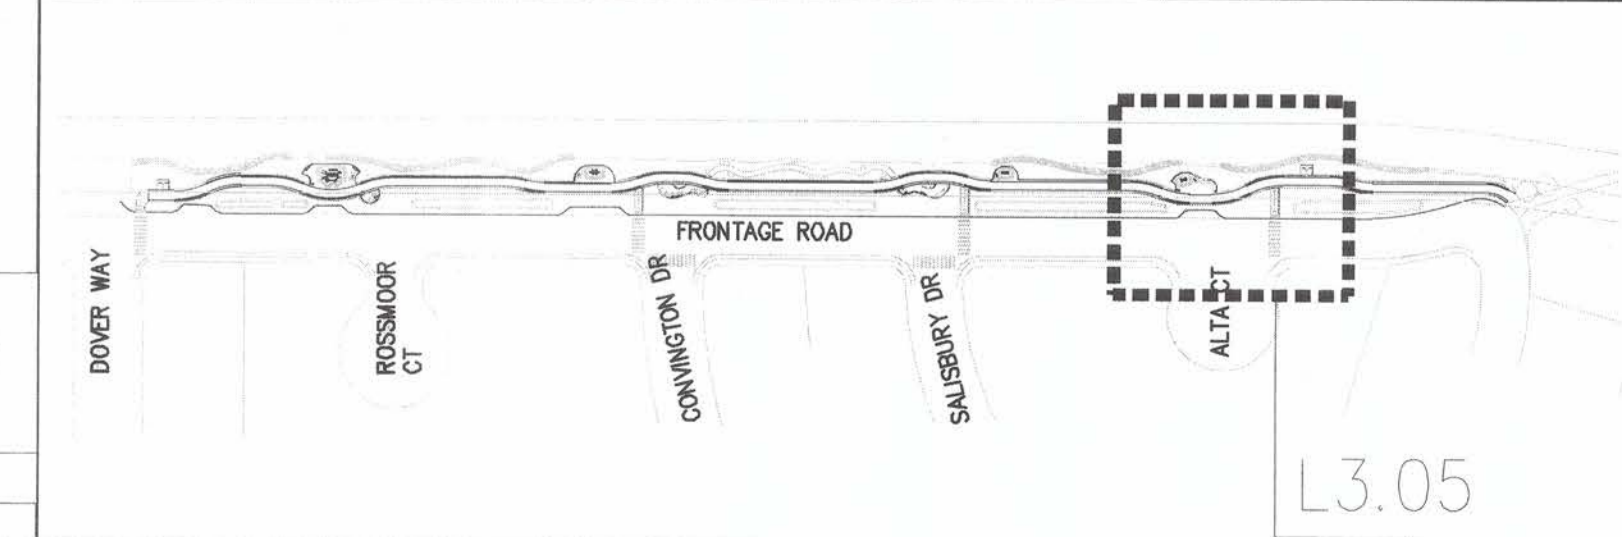

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L3-05


**FRONTAGE ROAD
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IRRIGATION PLAN




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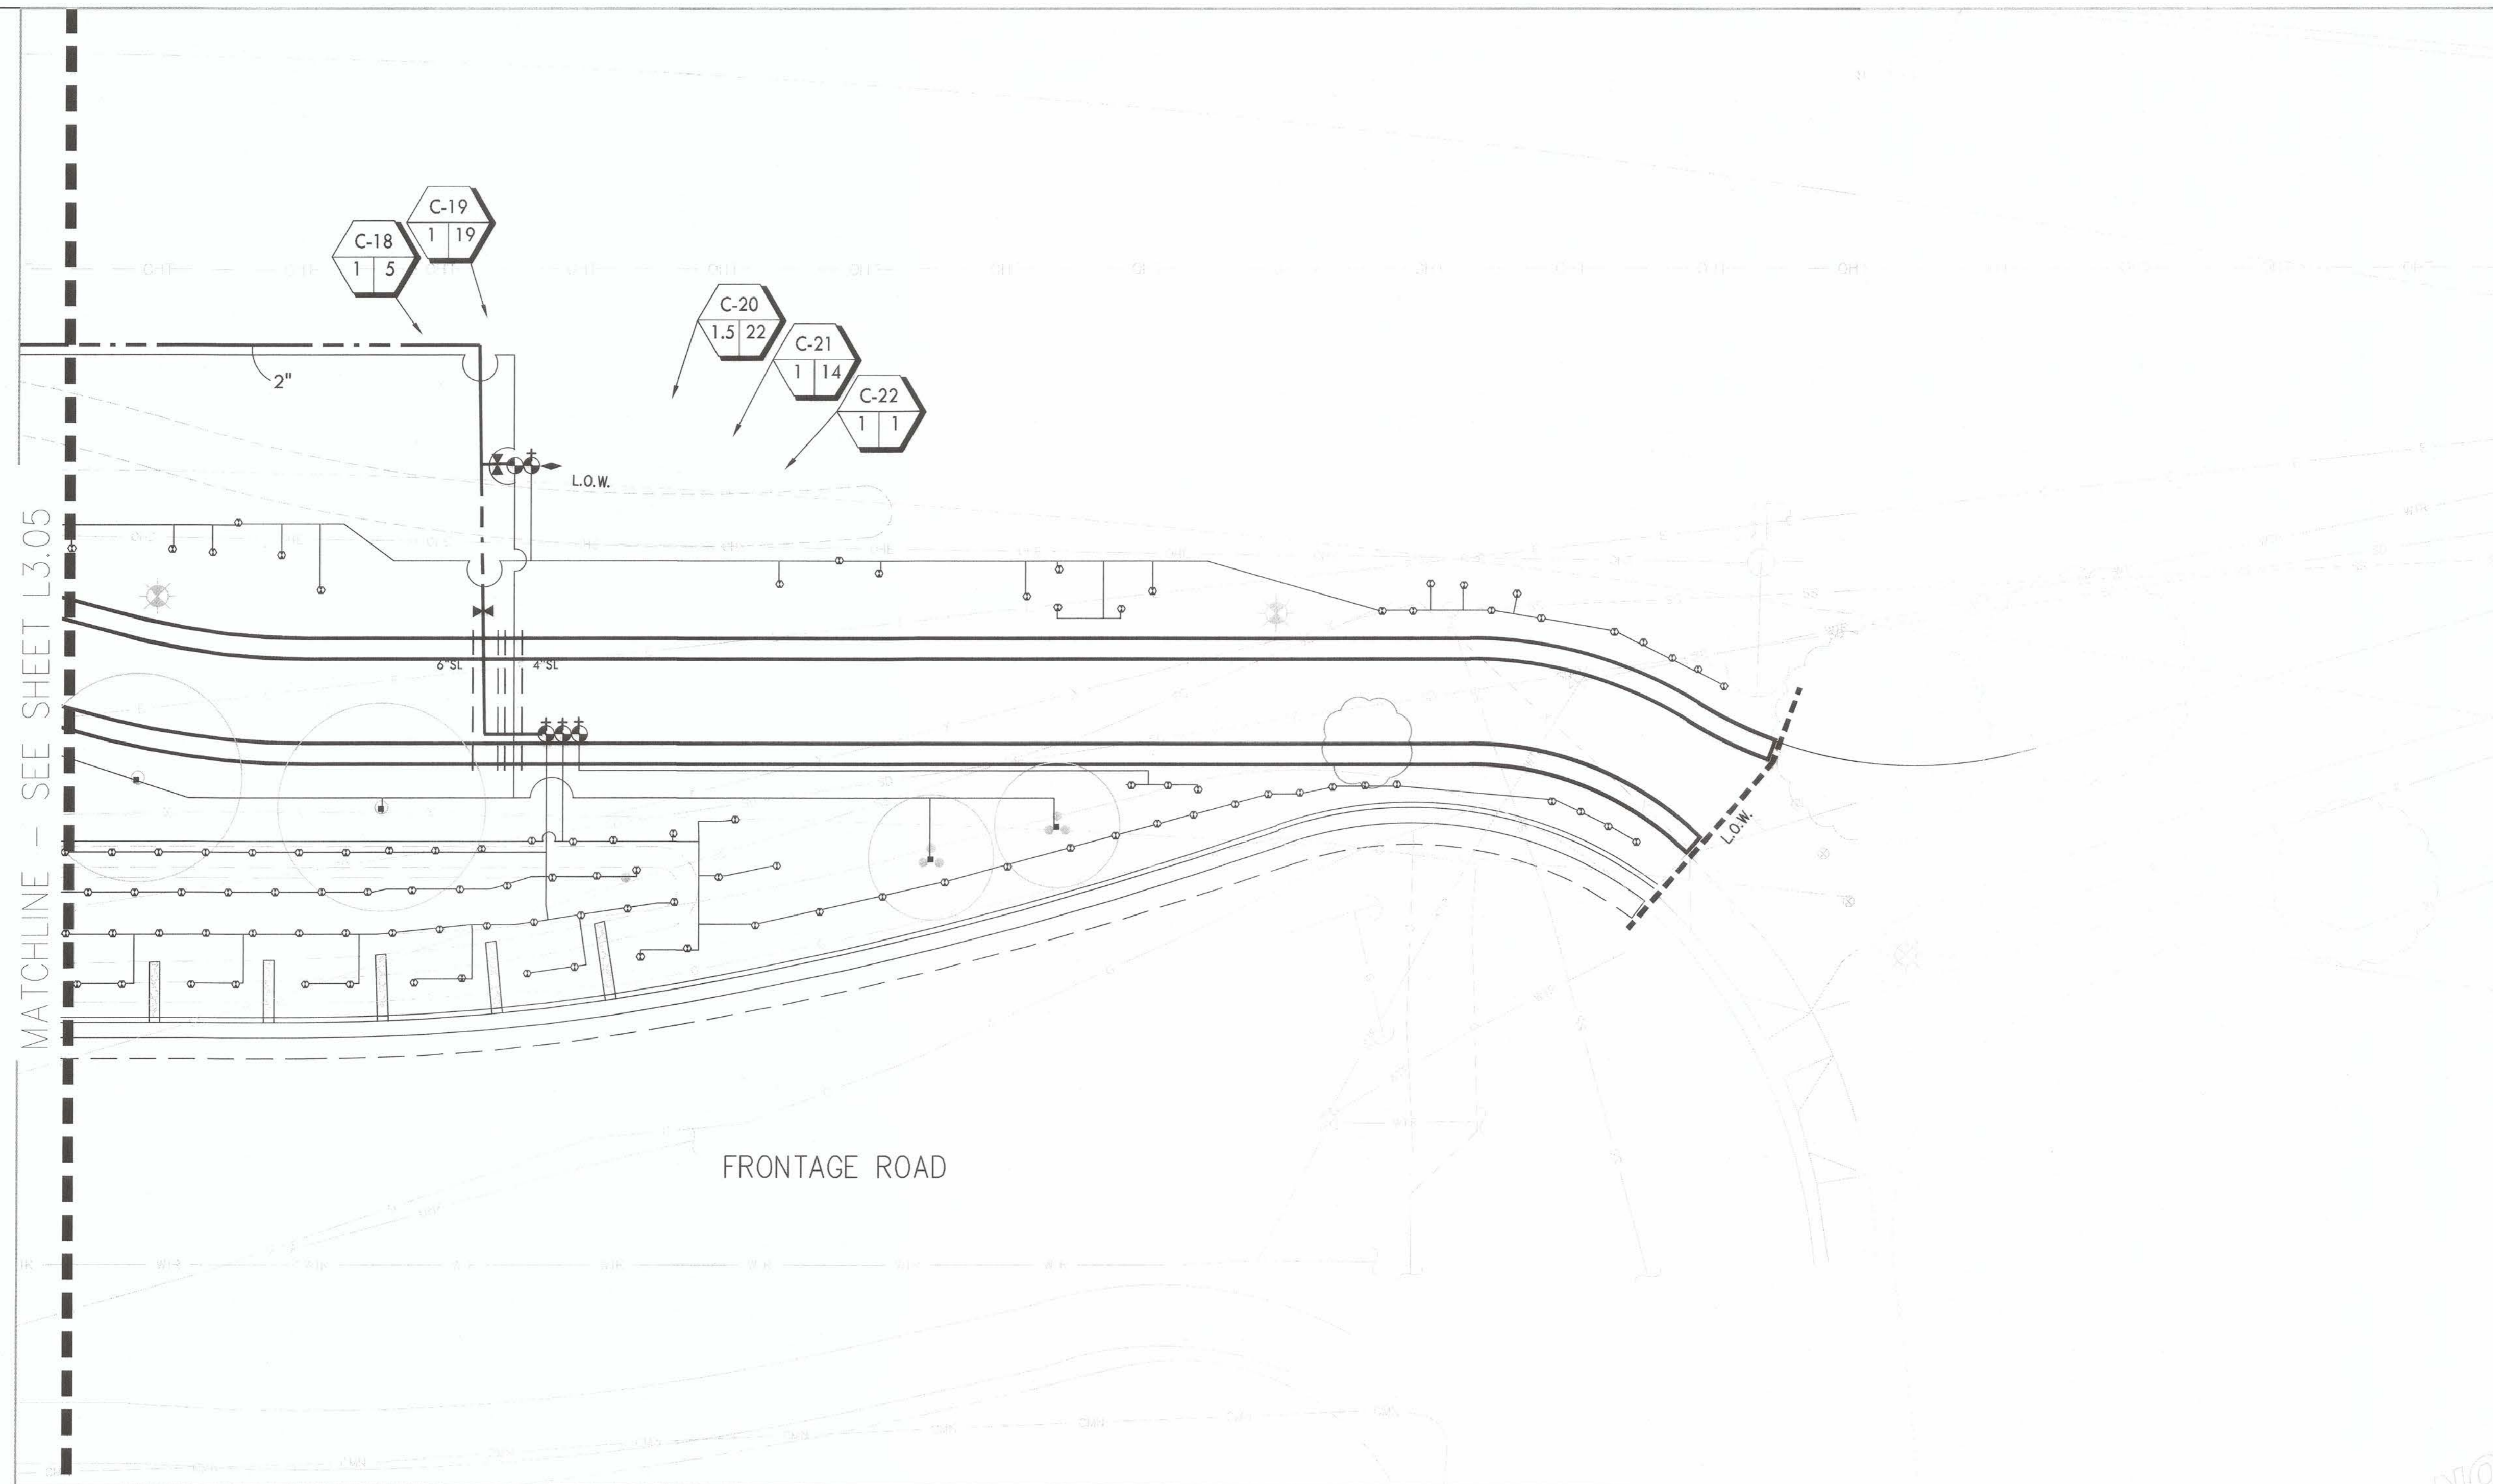
JOHN SAMUELSON
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 Date: 9/26/23





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Irrigation Consultant:
Russell D. Mitchell Associates, Inc.
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 tel 925.939.3985 ♦ fax 925.932.5671
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 P.O. BOX 111111
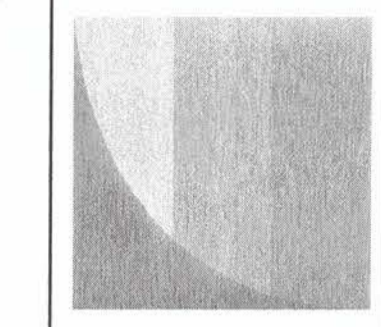
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FRONTAGE ROAD LIVING TRAIL
 IRRIGATION PLAN

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44 OF 59

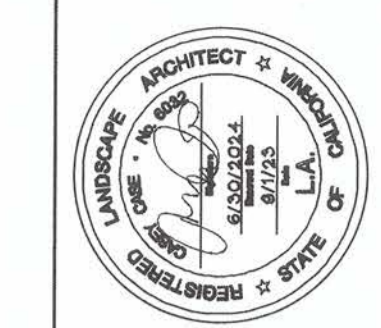DWG. NO.
L3.06

IRRIGATION NOTES

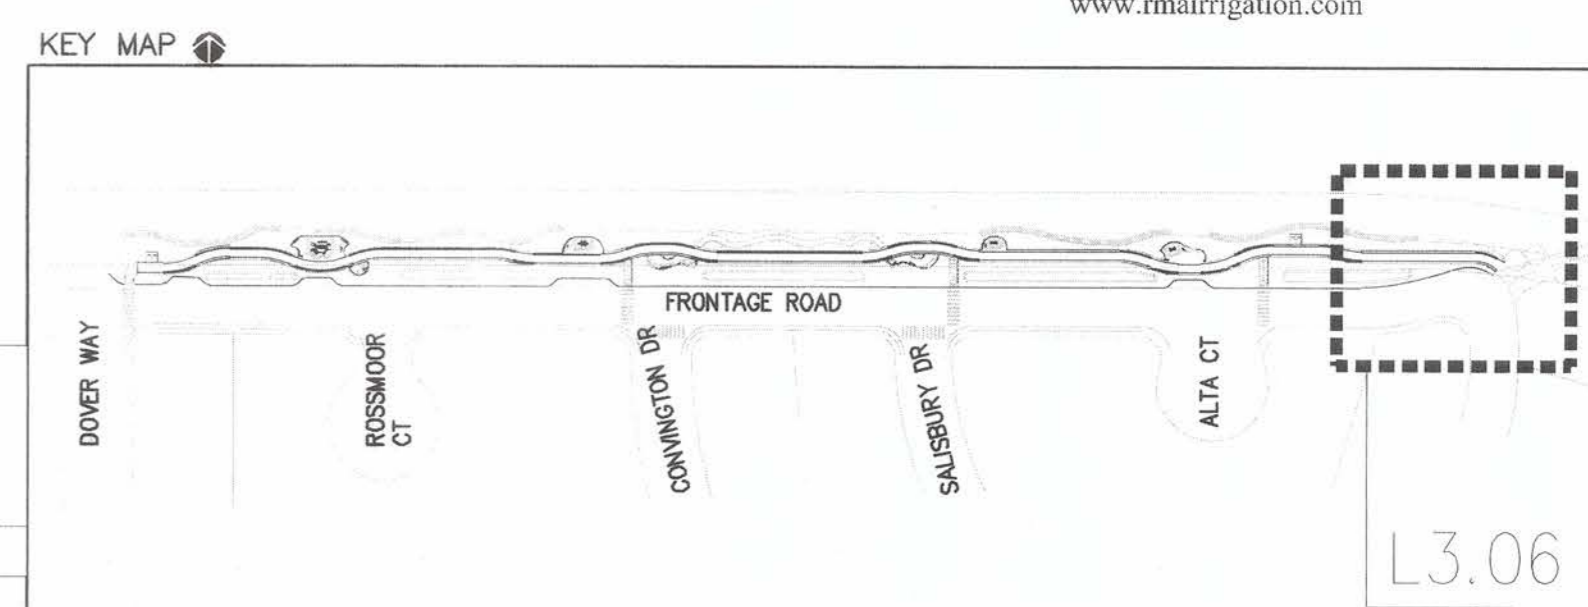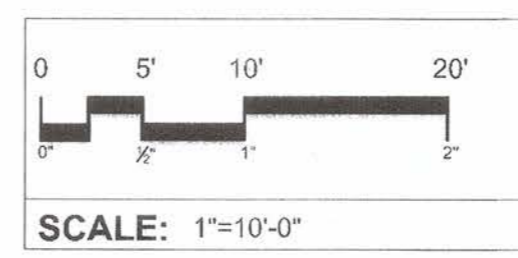
- THESE IRRIGATION DRAWINGS ARE DIAGRAMMATIC AND INDICATIVE OF THE WORK TO BE INSTALLED. ALL PIPING, VALVES, AND OTHER IRRIGATION COMPONENTS MAY BE SHOWN WITHIN PAVED AREAS FOR GRAPHIC CLARITY ONLY AND ARE TO BE INSTALLED WITHIN PLANTING AREAS. DUE TO THE SCALE OF THE DRAWINGS, IT IS NOT POSSIBLE TO INDICATE ALL OFFSETS, FITTINGS, SLEEVES, CONDUIT, AND OTHER ITEMS WHICH MAY BE REQUIRED. INVESTIGATE THE STRUCTURAL AND FINISHED CONDITION AFFECTING THE CONTRACT WORK INCLUDING OBSTRUCTIONS, GRADE DIFFERENCES OR AREA DIMENSIONAL DIFFERENCES. IN THE EVENT OF FIELD DISCREPANCY WITH CONTRACT DOCUMENTS, PLAN THE INSTALLATION WORK ACCORDINGLY BY NOTIFICATION AND APPROVAL OF THE OWNER'S AUTHORIZED REPRESENTATIVE AND ACCORDING TO THE CONTRACT SPECIFICATIONS. NOTIFY AND COORDINATE IRRIGATION CONTRACT WORK WITH APPLICABLE CONTRACTORS FOR THE LOCATION AND INSTALLATION OF PIPE, CONDUIT OR SLEEVES THROUGH OR UNDER WALLS, ROADWAYS, PAVING AND STRUCTURES BEFORE CONSTRUCTION. IN THE EVENT THESE NOTIFICATIONS ARE NOT PERFORMED, THE CONTRACTOR ASSUMES FULL RESPONSIBILITY FOR REQUIRED REVISIONS.
- THE CONTRACTOR SHALL COMPLY WITH ALL APPLICABLE CODES, STANDARDS, AND REGULATIONS. ALL WORK AND MATERIALS SHALL BE IN FULL ACCORDANCE WITH THE LATEST RULES AND REGULATIONS OF THE NATIONAL ELECTRIC CODE; THE UNIFORM PLUMBING CODE, PUBLISHED BY THE WESTERN PLUMBING OFFICIALS ASSOCIATION; AND OTHER STATE OR LOCAL LAWS OR REGULATIONS. NOTHING IN THESE DRAWINGS IS TO BE CONSTRUED TO PERMIT WORK NOT CONFORMING TO THESE CODES OR REGULATIONS. THE CONTRACTOR SHALL FURNISH WITHOUT ANY EXTRA CHARGE, ANY ADDITIONAL MATERIAL AND LABOR WHEN REQUIRED BY THE COMPLIANCE WITH THESE CODES AND REGULATIONS.
- THE CONTRACTOR SHALL COORDINATE INSTALLATION OF IRRIGATION SYSTEM WITH LAYOUT AND INSTALLATION OF THE PLANT MATERIALS TO INSURE THAT THERE WILL BE COMPLETE AND UNIFORM IRRIGATION COVERAGE OF PLANTING IN ACCORDANCE WITH THESE DRAWINGS, AND CONTRACT DOCUMENTS. THE IRRIGATION LAYOUT SHALL BE CHECKED BY THE CONTRACTOR AND OWNER'S AUTHORIZED REPRESENTATIVE PRIOR TO CONSTRUCTION TO DETERMINE IF ANY CHANGES, DELETIONS, OR ADDITIONS ARE REQUIRED. IRRIGATION SYSTEM SHALL BE INSTALLED AND TESTED PRIOR TO INSTALLATION OF PLANT MATERIAL.
- THE INTENT OF THIS IRRIGATION SYSTEM IS TO PROVIDE THE MINIMUM AMOUNT OF WATER REQUIRED TO SUSTAIN GOOD PLANT HEALTH.
- IT IS THE RESPONSIBILITY OF THE MAINTENANCE CONTRACTOR AND/OR OWNER TO PROGRAM THE IRRIGATION CONTROLLER(S) TO PROVIDE THE MINIMUM AMOUNT OF WATER NEEDED TO SUSTAIN GOOD PLANT HEALTH. THIS INCLUDES MAKING ADJUSTMENTS TO THE PROGRAM FOR SEASONAL WEATHER CHANGES, PLANT MATERIAL, WATER REQUIREMENTS, MOUNDS, SLOPES, SUN, SHADE AND WIND EXPOSURE.
- IT IS THE RESPONSIBILITY OF A LICENSED ELECTRICAL CONTRACTOR TO PROVIDE 120 VOLT A.C. (2.5 AMP DEMAND PER CONTROLLER) ELECTRICAL SERVICE TO THE CONTROLLER LOCATION(S). IT IS THE RESPONSIBILITY OF THE IRRIGATION CONTRACTOR TO COORDINATE THE ELECTRICAL SERVICE STUB-OUT TO THE CONTROLLER(S). PROVIDE PROPER GROUNDING PER CONTROLLER MANUFACTURER'S INSTRUCTIONS AND IN ACCORDANCE WITH LOCAL CODES.
- PROVIDE EACH CONTROLLER WITH ITS OWN GROUND ROD. SEPARATE THE GROUND RODS BY A MINIMUM OF EIGHT FEET. THE GROUND ROD SHALL BE AN EIGHT FOOT LONG BY 5/8" DIAMETER U.L. APPROVED COPPER CLAD ROD. INSTALL NO MORE THAN 6" OF THE GROUND ROD ABOVE FINISH GRADE. CONNECT #6 GAUGE WIRE WITH A U.L. APPROVED GROUND ROD CLAMP TO ROD AND BACK TO GROUND SCREW AT BASE OF CONTROLLER WITH APPROPRIATE CONNECTOR. MAKE THIS WIRE AS SHORT AS POSSIBLE, AVOIDING KINKS OR BENDING.
- SCHEDULE A MEETING WHICH INCLUDES REPRESENTATIVES OF THE IRRIGATION CONTROLLER MANUFACTURER, THE MAINTENANCE CONTRACTOR, THE OWNER AND THE IRRIGATION CONTRACTOR AT THE SITE FOR INSTRUCTION ON THE PROPER PROGRAMMING AND OPERATION OF THE IRRIGATION CONTROLLER.
- INSTALL 3" DETECTABLE TAPE ABOVE ALL PRESSURIZED MAIN LINES AS DETAILED. USE CHRISTY #TA-DT-3-BIRR FOR POTABLE IRRIGATION SYSTEMS.
- PROVIDE EACH IRRIGATION CONTROLLER WITH ITS OWN INDEPENDENT LOW VOLTAGE COMMON GROUND WIRE.
- IRRIGATION CONTROL WIRES: SOLID COPPER WITH U.L. APPROVAL FOR DIRECT BURIAL IN GROUND. COMMON GROUND WIRE: SIZE #12-1 WIRE WITH A WHITE INSULATING JACKET. CONTROL WIRE SERVICING REMOTE CONTROL VALVES: SIZE #14-1 WIRE WITH INSULATING JACKET OF COLOR OTHER THAN WHITE. SPLICES SHALL BE MADE WITH 3M-DBY SEAL PACKS OR APPROVED EQUAL.
- INSTALL TWO SPARE CONTROL WIRES OF A DIFFERENT COLOR ALONG THE ENTIRE MAIN LINE. LOOP 36" EXCESS WIRE INTO EACH SINGLE VALVE BOX AND INTO ONE VALVE BOX IN EACH GROUP OF VALVES.
- SPLICING OF LOW VOLTAGE WIRES IS PERMITTED IN VALVE BOXES ONLY. LEAVE A 36" LONG, 1" DIAMETER COIL OF EXCESS WIRE AT EACH SPLICE AND A 36" LONG EXPANSION LOOP EVERY 100 FEET ALONG WIRE RUN. TAPE WIRES TOGETHER EVERY TEN FEET. DO NOT TAPE WIRES TOGETHER WHERE CONTAINED WITHIN SLEEVE.
- INSTALL GREEN PLASTIC VALVE BOXES WITH BOLT DOWN, NON HINGED COVER MARKED "IRRIGATION CONTROL VALVE". BOX BODY SHALL HAVE KNOCK OUTS. ACCEPTABLE VALVE BOX MANUFACTURER'S INCLUDE NDS, CARSON OR APPROVED EQUAL.
- INSTALL REMOTE CONTROL VALVE BOXES 12" FROM WALK, CURB, BUILDING OR LANDSCAPE FEATURE. AT MULTIPLE VALVE BOX GROUPS, INSTALL EACH BOX AN EQUAL DISTANCE FROM THE WALK, CURB, BUILDING OR LANDSCAPE FEATURE AND PROVIDE 12" BETWEEN BOX TOPS. ALIGN THE SHORT SIDE OF RECTANGULAR VALVE BOXES PARALLEL TO WALK, CURB, BUILDING OR LANDSCAPE FEATURE.
- VALVE LOCATIONS SHOWN ARE DIAGRAMMATIC. INSTALL IN GROUND COVER/SHRUB AREAS (AVOID LAWN AREAS WHERE POSSIBLE).
- THE CONTRACTOR SHALL LABEL CONTROL LINE WIRE AT EACH REMOTE CONTROL VALVE WITH A 2 1/4" X 2 3/4" POLYURETHANE I.D. TAG, INDICATING IDENTIFICATION NUMBER OF VALVE (CONTROLLER AND STATION NUMBER). ATTACH LABEL TO CONTROL WIRE. THE CONTRACTOR SHALL PERMANENTLY STAMP ALL VALVE BOX LIDS WITH APPROPRIATE IDENTIFICATION AS NOTED IN CONSTRUCTION DETAILS.
- FLUSH AND ADJUST IRRIGATION OUTLETS AND NOZZLES FOR OPTIMUM PERFORMANCE AND TO PREVENT OVER SPRAY ONTO WALKS, ROADWAYS, AND/OR BUILDINGS. SELECT THE BEST DEGREE OF THE ARC AND RADIUS TO FIT THE EXISTING SITE CONDITIONS AND THROTTLE THE FLOW CONTROL AT EACH VALVE TO OBTAIN THE OPTIMUM OPERATING PRESSURE FOR EACH CONTROL ZONE.
- LOCATE BUBBLERS ON UPHILL SIDE OF PLANT OR TREE.
- INSTALL A HUNTER HCV SERIES, KBI CV SERIES, OR APPROVED EQUAL SPRING LOADED CHECK VALVE IN SPRINKLER RISER ASSEMBLIES WHERE LOW OUTLET DRAINAGE WILL CAUSE EROSION AND/OR EXCESS WATER.
- WHERE IT IS NECESSARY TO EXCAVATE ADJACENT TO EXISTING TREES, USE CAUTION TO AVOID INJURY TO TREES AND TREE ROOTS. EXCAVATE BY HAND IN AREAS WHERE TWO (2) INCH AND LARGER ROOTS OCCUR. BACK FILL TRENCHES ADJACENT TO TREE WITHIN TWENTY-FOUR (24) HOURS. WHERE THIS IS NOT POSSIBLE, SHADE THE SIDE OF THE TRENCH ADJACENT TO THE TREE WITH WET BURLAP OR CANVAS.
- NOTIFY LOCAL JURISDICTIONS FOR INSPECTION AND TESTING OF INSTALLED BACKFLOW PREVENTION DEVICE.
- THE IRRIGATION SYSTEM DESIGN IS BASED ON THE MINIMUM OPERATING PRESSURE SHOWN ON THE IRRIGATION DRAWINGS. VERIFY WATER PRESSURE PRIOR TO CONSTRUCTION. REPORT ANY DIFFERENCE BETWEEN THE WATER PRESSURE INDICATED ON THE DRAWINGS AND THE ACTUAL PRESSURE READING AT THE IRRIGATION POINT OF CONNECTION TO THE OWNER'S AUTHORIZED REPRESENTATIVE.
- IRRIGATION DEMAND: REFER TO PLANS.
- THE EXISTING MAIN LINE SHOWN ON THE DRAWINGS IS DIAGRAMMATIC. VERIFY AND LOCATE EXISTING MAIN LINE IN FIELD. REPORT TO ARCHITECT IN WRITING ANY DEVIATION OF EXISTING MAIN LINE LOCATION FROM THAT SHOWN ON THE DRAWINGS.
- PIPE SIZING SHOWN ON THE DRAWINGS IS TYPICAL. AS CHANGES IN LAYOUT OCCUR DURING STAKING AND CONSTRUCTION THE SIZE MAY NEED TO BE ADJUSTED ACCORDINGLY.
- PIPE THREAD SEALANT COMPOUND SHALL BE RECTOR SEAL #5.
- THE LANDSCAPE CONTRACTOR SHALL BE RESPONSIBLE FOR MINOR CHANGES IN THE IRRIGATION LAYOUT DUE TO OBSTRUCTIONS NOT SHOWN ON THE IRRIGATION DRAWINGS SUCH AS LIGHTS, FIRE HYDRANTS, SIGNS, ELECTRICAL ENCLOSURES, ETC.
- THE LANDSCAPE CONTRACTOR SHALL BE RESPONSIBLE FOR CHANGES IN THE IRRIGATION LAYOUT AND VALVE ZONING DUE TO VARIATIONS IN THE EXISTING SITE CONDITIONS SUCH AS EXPOSURE FROM BUILDINGS, TRELLISES, TREES, ETC., AS WELL AS SLOPE AND SOIL CONDITIONS. THE CONTRACTOR SHALL NOTIFY THE LANDSCAPE ARCHITECT AND IRRIGATION CONSULTANT OF THE PROPOSED CHANGES PRIOR TO INSTALLATION FOR APPROVAL.
- THE LANDSCAPE CONTRACTOR IS RESPONSIBLE FOR ADJUSTING THE IRRIGATION SYSTEM DESIGN IF THE PLANTING DESIGN CHANGES FROM THE ORIGINAL PLAN AND NEEDS TO ADAPT TO THE NEW PLANTING DESIGN. THE LANDSCAPE CONTRACTOR NEEDS TO NOTIFY THE LANDSCAPE ARCHITECT AND IRRIGATION CONSULTANT OF PROPOSED CHANGES PRIOR TO INSTALLATION FOR APPROVAL.
- WHEN WORK OF THIS SECTION HAS BEEN COMPLETED AND SUCH OTHER TIMES AS MAY BE DIRECTED, REMOVE ALL TRASH, DEBRIS, SURPLUS MATERIALS AND EQUIPMENT FROM SITE.
- CONTRACTOR SHALL BE RESPONSIBLE FOR SUPPLEMENTAL HAND WATERING OF ALL PLANT MATERIAL WITHIN DRIPLINE AREAS UNTIL THE PLANTS ARE SUFFICIENTLY ESTABLISHED.
- VERIFY LOCATIONS OF ALL IRRIGATION COMPONENTS INSTALLED WITHIN A VALVE BOX WITH LANDSCAPE ARCHITECT PRIOR TO INSTALLATION. DO NOT INSTALL UNTIL LANDSCAPE ARCHITECT PROVIDES ACCEPTABLE LOCATIONS.

IRRIGATION LEGEND

SYMBOL	MODEL NUMBER	DESCRIPTION	NOZZLE GPM	OPERATING PSI	OPERATING RADIUS (FEET)
	1401	RAINBIRD BUBBLER, 1 PER SHRUB	0.25	30	TRICKLE
	1401	RAINBIRD BUBBLER FOR TREES IN SHRUB AREAS - 2 PER TREE	0.25	30	TRICKLE
	WLT-0500-T	NDS SCH 40 BALL VALVE OR APPROVED EQUAL			
	OPERIND	RAIN BIRD DRIP ZONE INDICATOR			
	33-DRC	RAIN BIRD 3/4" TWO-PIECE QUICK COUPLING VALVE (YELLOW LOCKING RUBBER COVER)			
	T113-K SERIES	NIBCO BRASS GATE VALVE (LINE SIZE)-2.5" AND SMALLER			
	FSI-T15-001	CST 1.5" TEE MOUNTED FLOW SENSOR (2-100 GPM)			
	PESB-2"	RAINBIRD MASTER VALVE - 2" (NORMALLY CLOSED)			
	PESB-R SERIES	RAIN BIRD REMOTE CONTROL VALVE WITH SCRUBBER MECHANISM			
	SA6-RM6-24 DXICA WRS GR-K	RAINMASTER DXI 24 STATION PEDESTAL MOUNT CONTROLLER ASSEMBLY BY SITE ONE GREEN TECH IN STAINLESS STEEL ENCLOSURE; INCLUDES CELLULAR COMMUNICATION, RAIN SENSOR AND GROUNDING KIT			
	RS-1000	IRRITROL WIRELESS RAIN SENSOR			
	975XL2SEU-1.5"/ BPDJ/PBB-20	WILKINS REDUCED PRESSURE BACKFLOW ASSEMBLY WITH GAURDSHACK PAINTED STAINLESS STEEL ENCLOSURE AND FREEZE BLANKET.			
		CONTROLLER AND STATION NUMBER			
		FLOW (GPM)			
		REMOTE CONTROL VALVE SIZE (IN INCHES)			
		ASSOCIATED REMOTE CONTROL VALVE			
		CONTROLLER AND STATION NUMBER			
		AREA (SQ. FT.)			
		FLOW (GPM)			
		REMOTE CONTROL VALVE SIZE (IN INCHES)			
		ASSOCIATED REMOTE CONTROL VALVE			
		MAIN LINE: 2.5" AND 3": CLASS 31.5 PVC PLASTIC PIPE WITH SCHEDULE 80 PVC SOLVENT WELD FITTINGS. 2" AND SMALLER: SCHEDULE 40 PVC WITH SCHEDULE 80 PVC SOLVENT WELD FITTINGS. 18" COVER.			
		LATERAL LINE: 3/4" AND LARGER: 1120-SCHEDULE 40 PVC PLASTIC PIPE WITH SCHEDULE 40 PVC SOLVENT WELD FITTINGS. 12" COVER.			
		SLEEVING: SCHEDULE 40 PVC PLASTIC PIPE. COVER TO BE AS INDICATED IN SPECIFICATIONS OR AS INDICATED ABOVE FOR PIPE DEPTH OF COVER.			
		CONDUIT: SCHEDULE 40 PVC PLASTIC CONDUIT. COVER TO BE AS INDICATED IN SPECIFICATIONS OR AS INDICATED ABOVE FOR PIPE DEPTH OF COVER.			



GATES +ASSOCIATES
 LANDSCAPE ARCHITECTURE
 LAND PLANNING - URBAN DESIGN
 10000 Wilshire Blvd., Suite 1000
 Los Angeles, CA 90024
 T 310.204.4174 www.gates.com

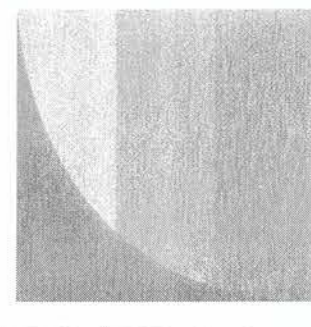

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 JOHN SAMUELSON
 City Engineer
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FRONTAGE ROAD LIVING TRAIL
 IRRIGATION NOTES AND LEGEND








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DATE	REV	DESCRIPTION

SHEET NO.
45 OF 59

DWG. NO.
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Irrigation Consultant:
Russell D. Mitchell Associates, Inc.
 2760 Camino Diablo
 Walnut Creek, CA 94597
 tel 925.939.3985 ♦ fax 925.932.5671
 www.mairrigation.com



GATES + ASSOCIATES
LANDSCAPE ARCHITECTURE
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1500 W. 32nd Avenue, Suite 200
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Tel: 412.662.8174 www.gates-llp.com
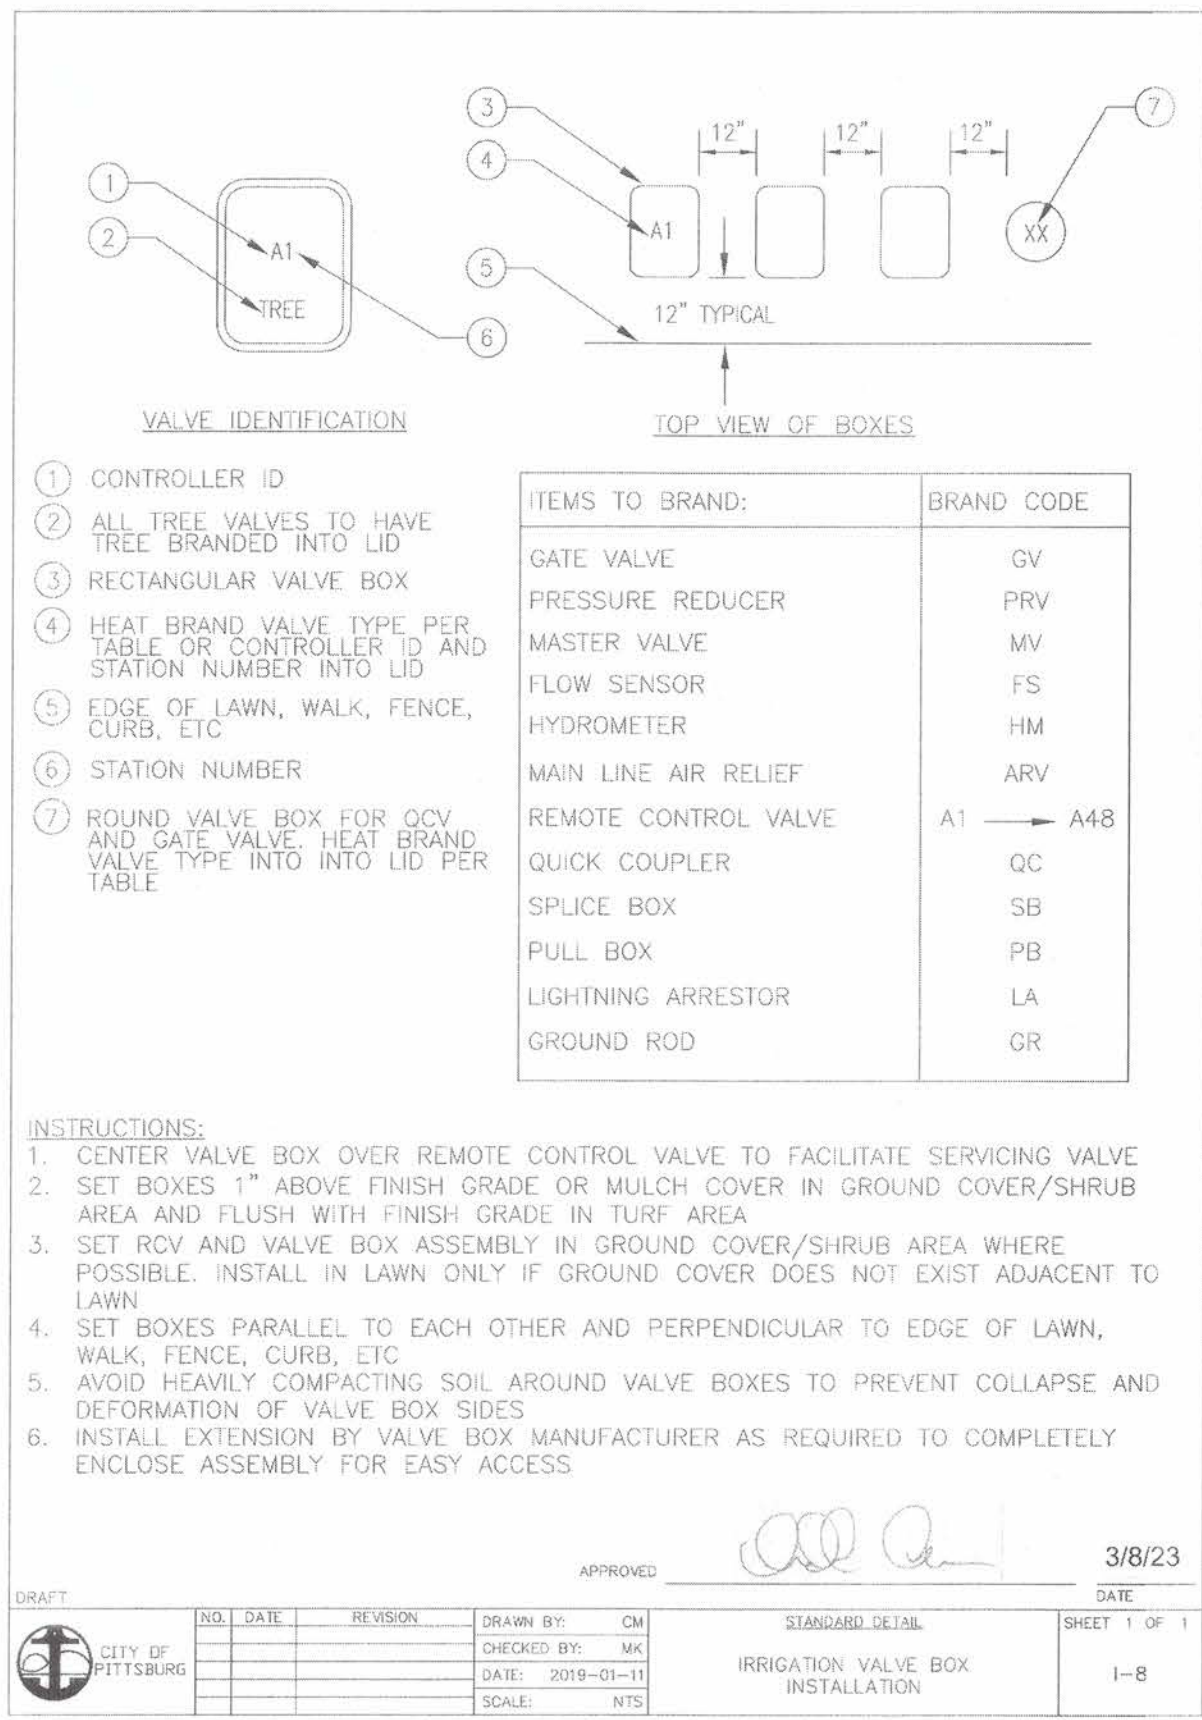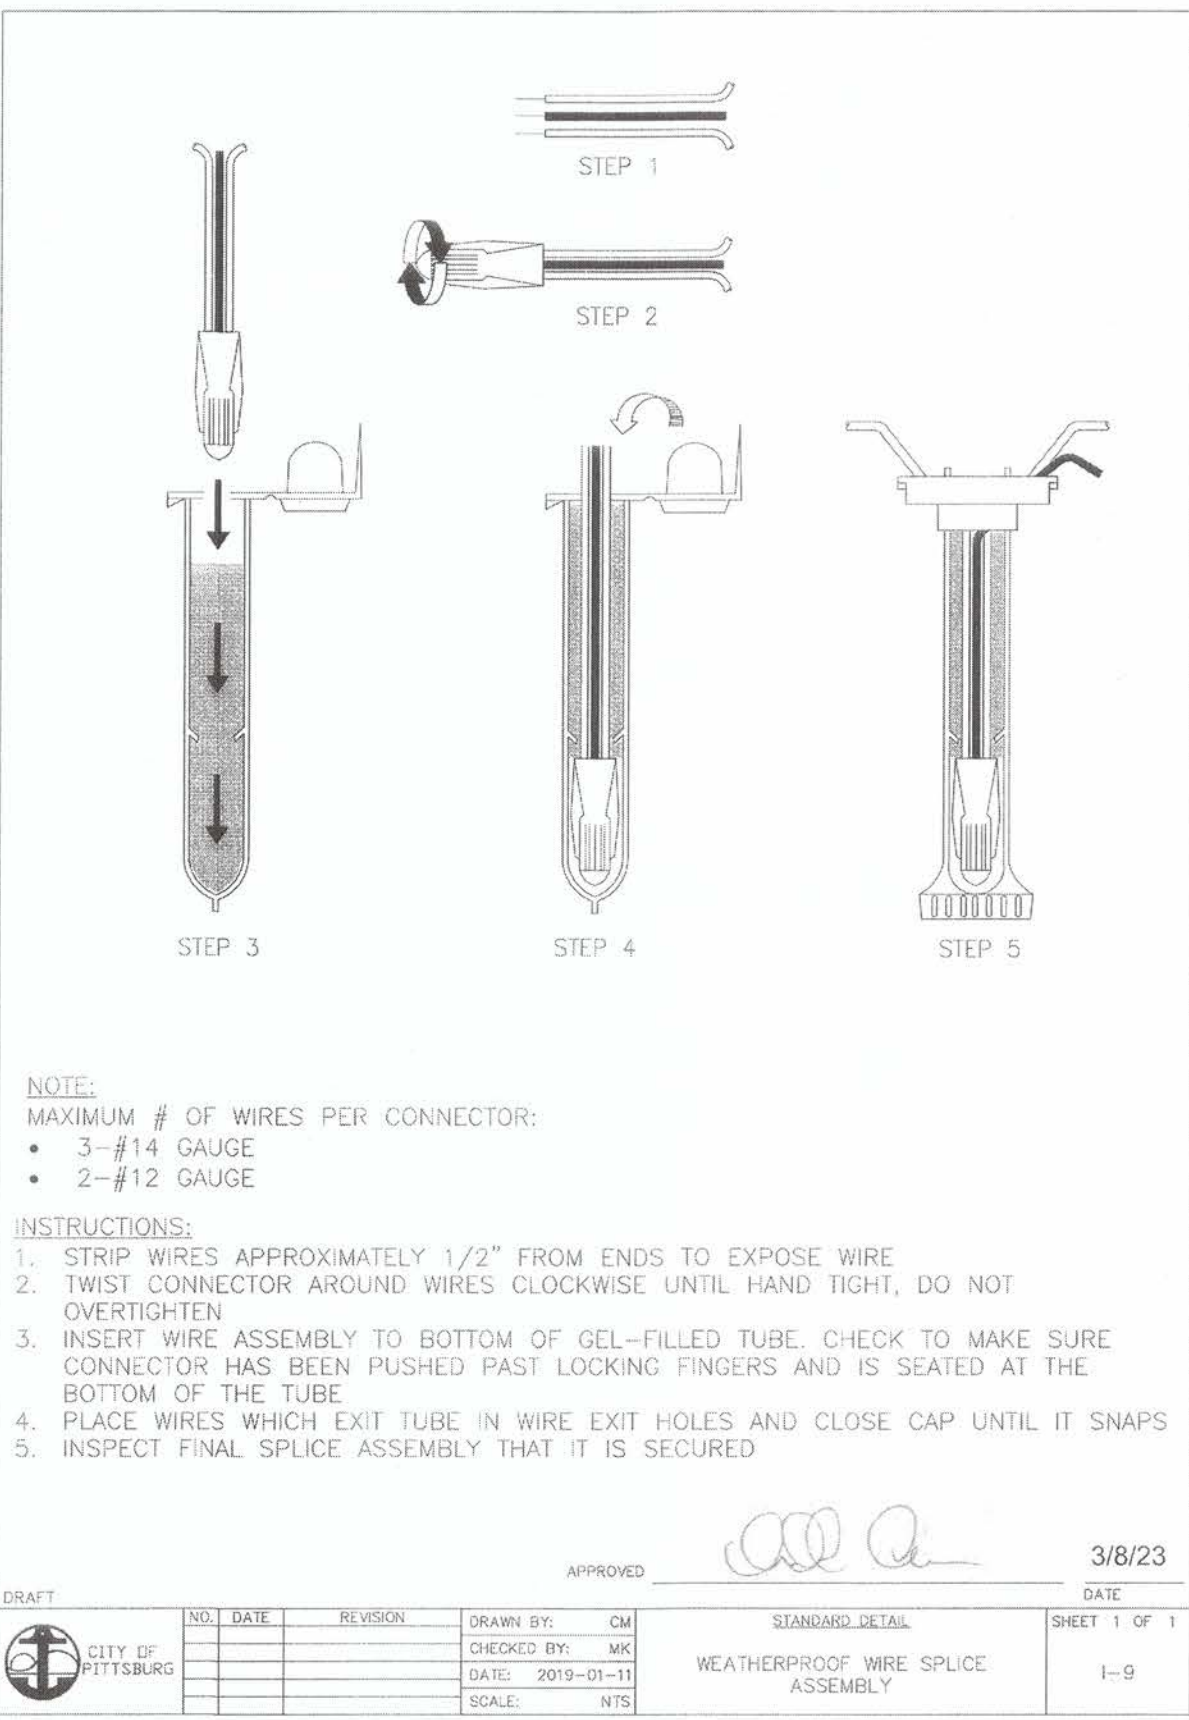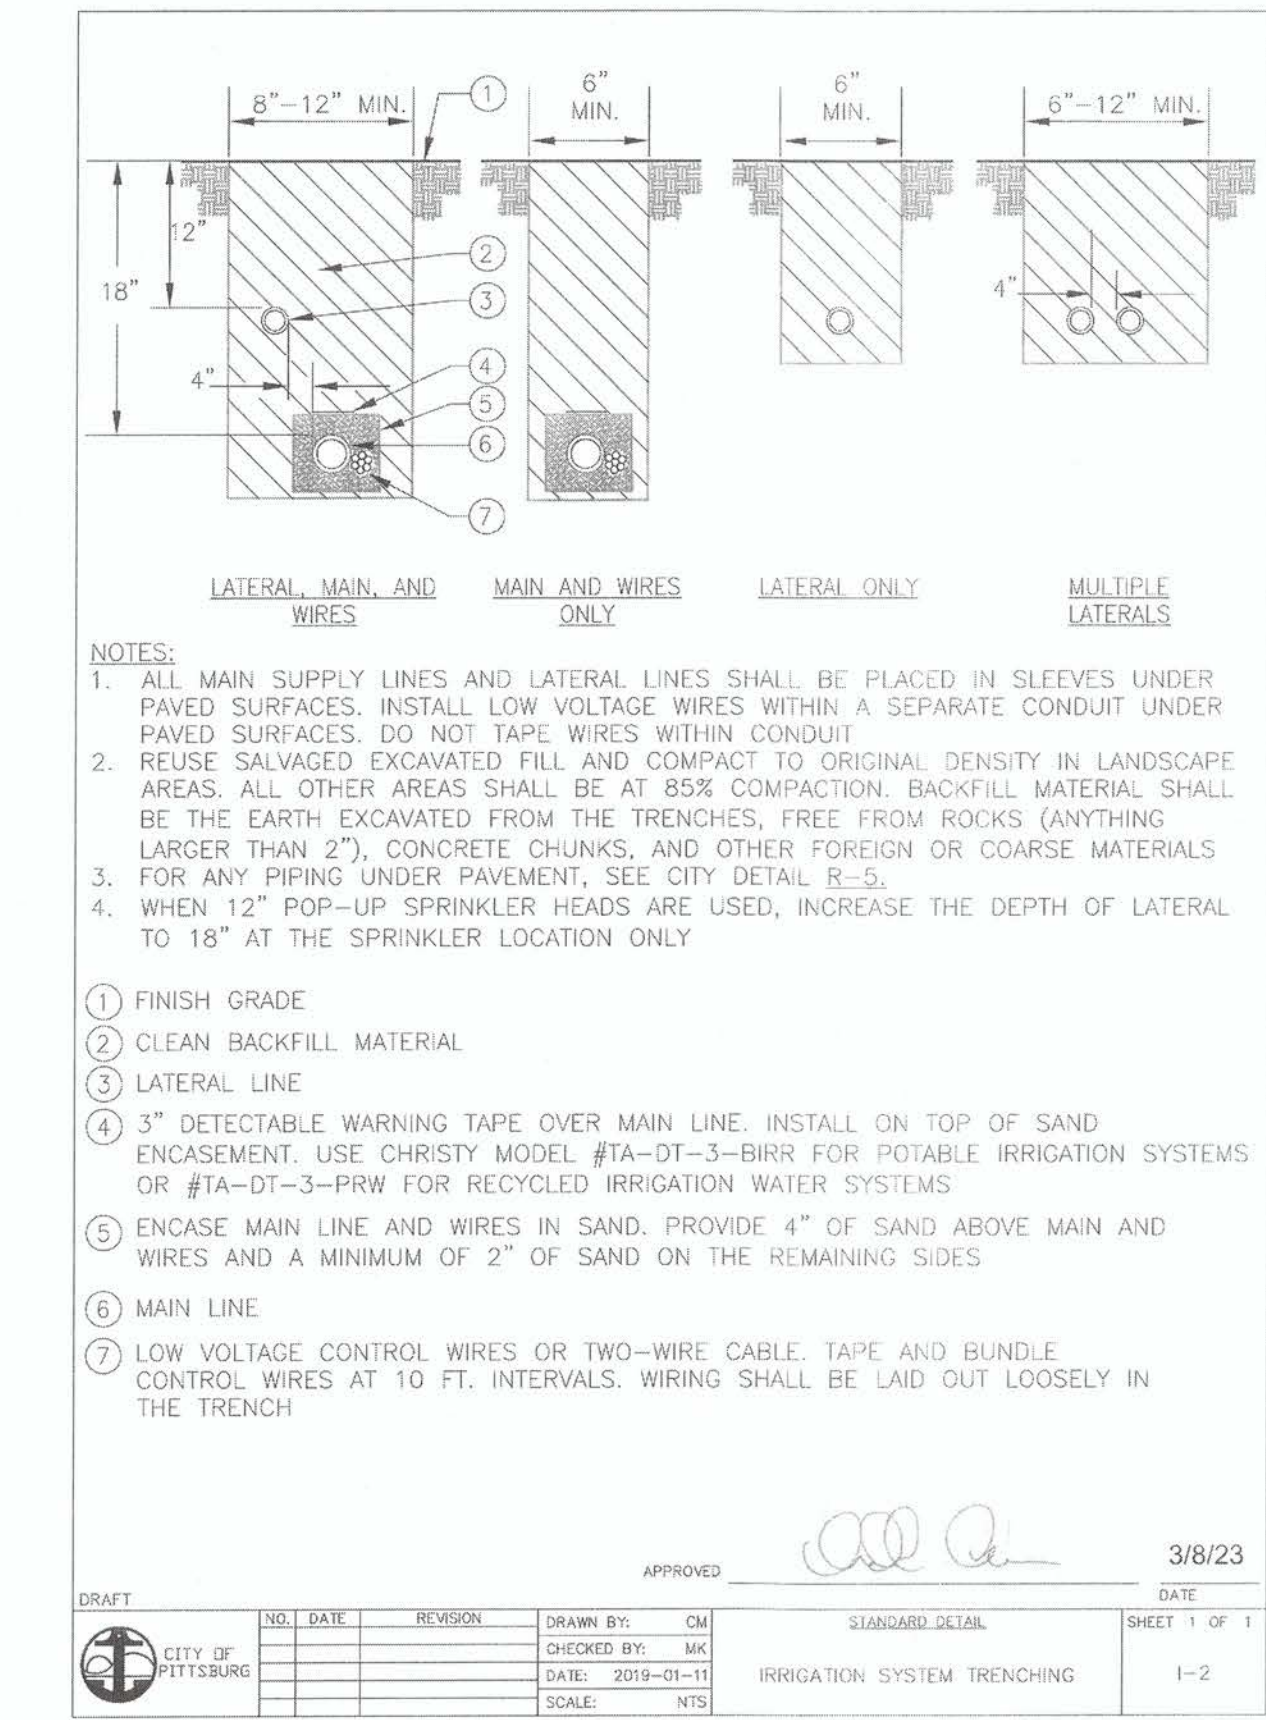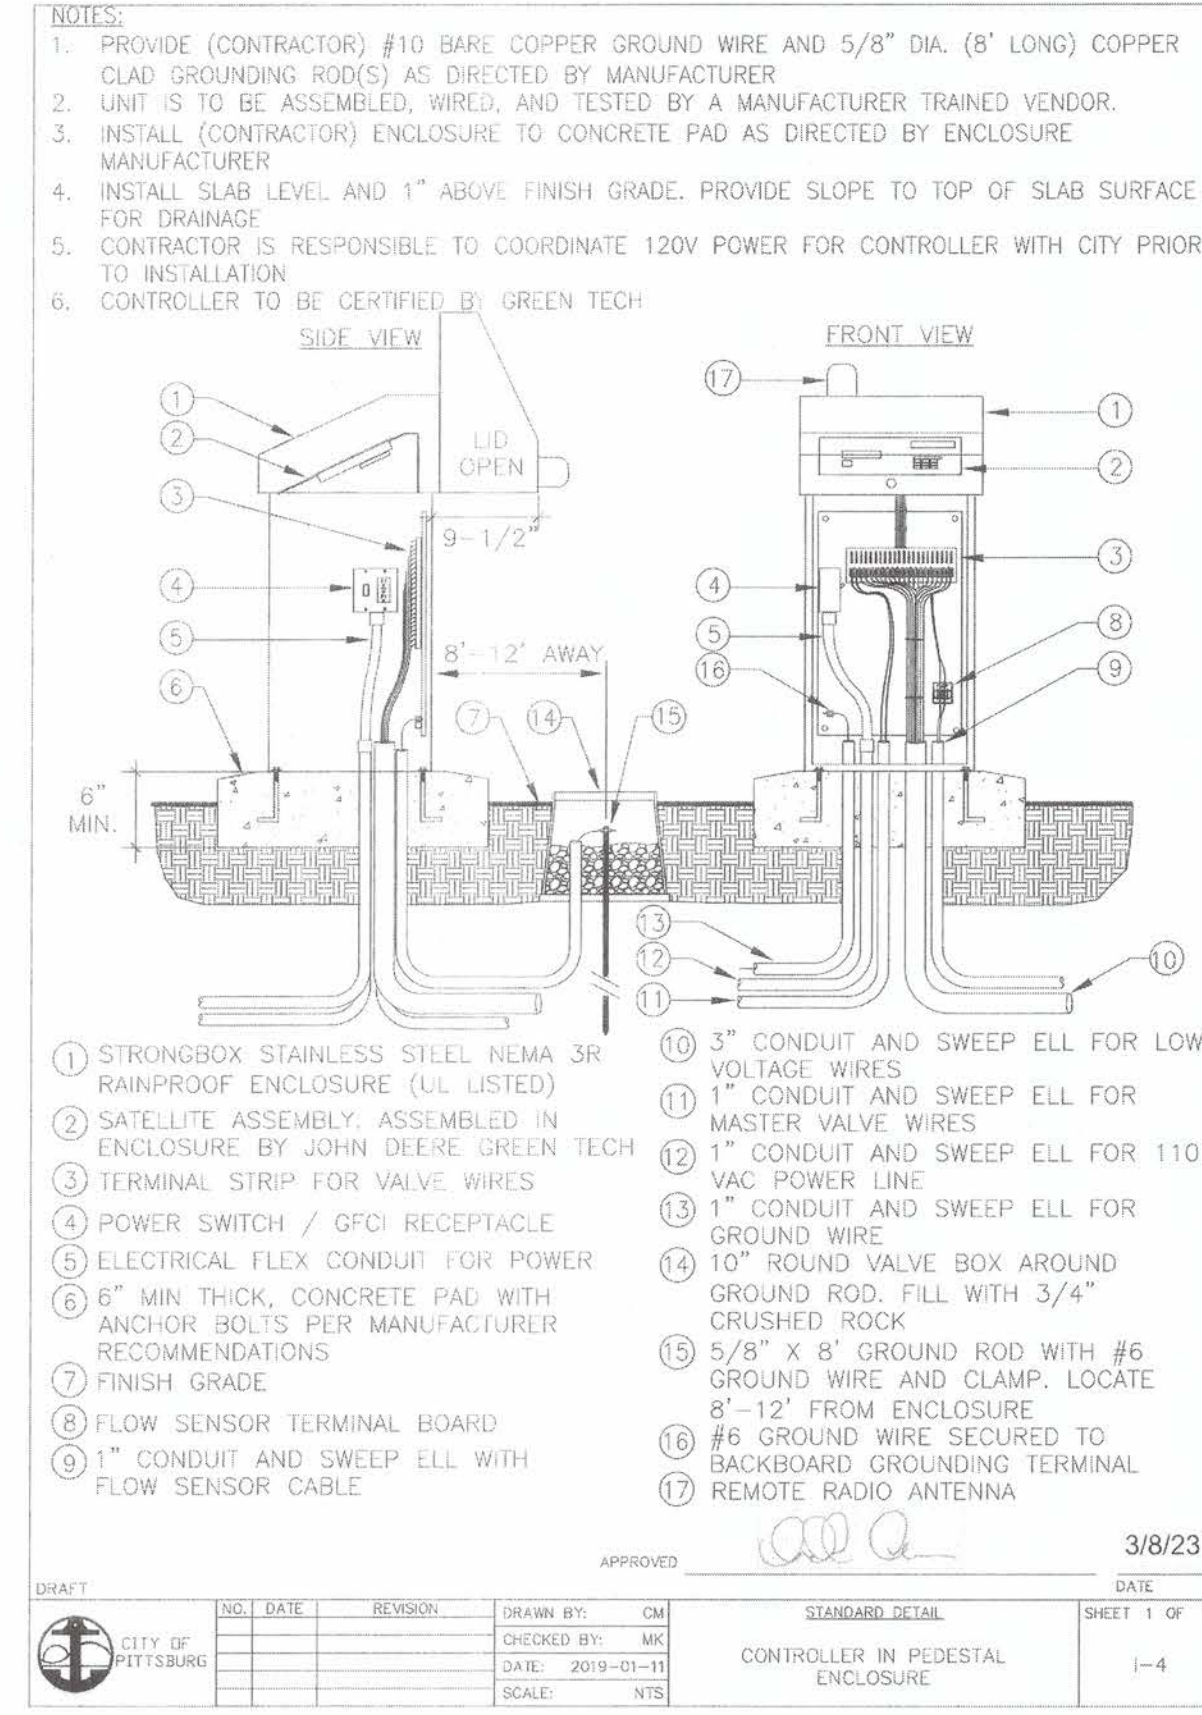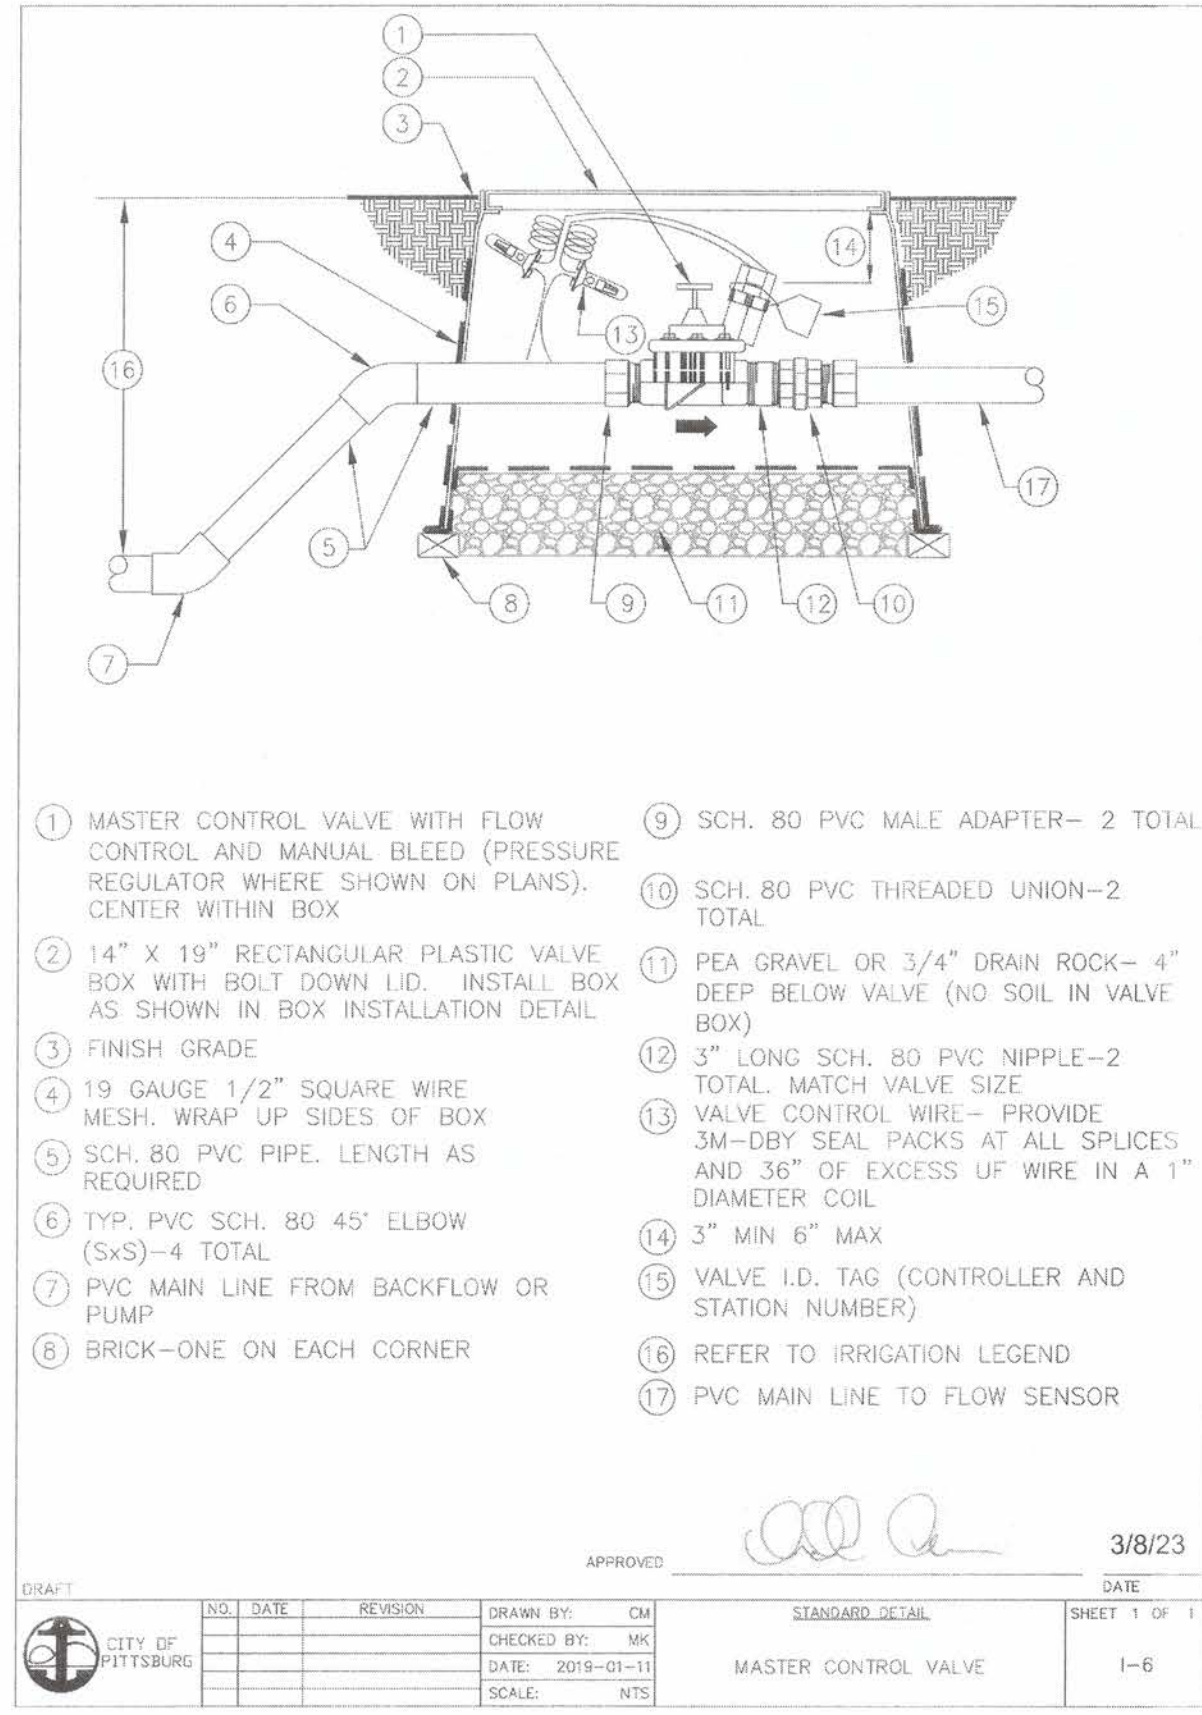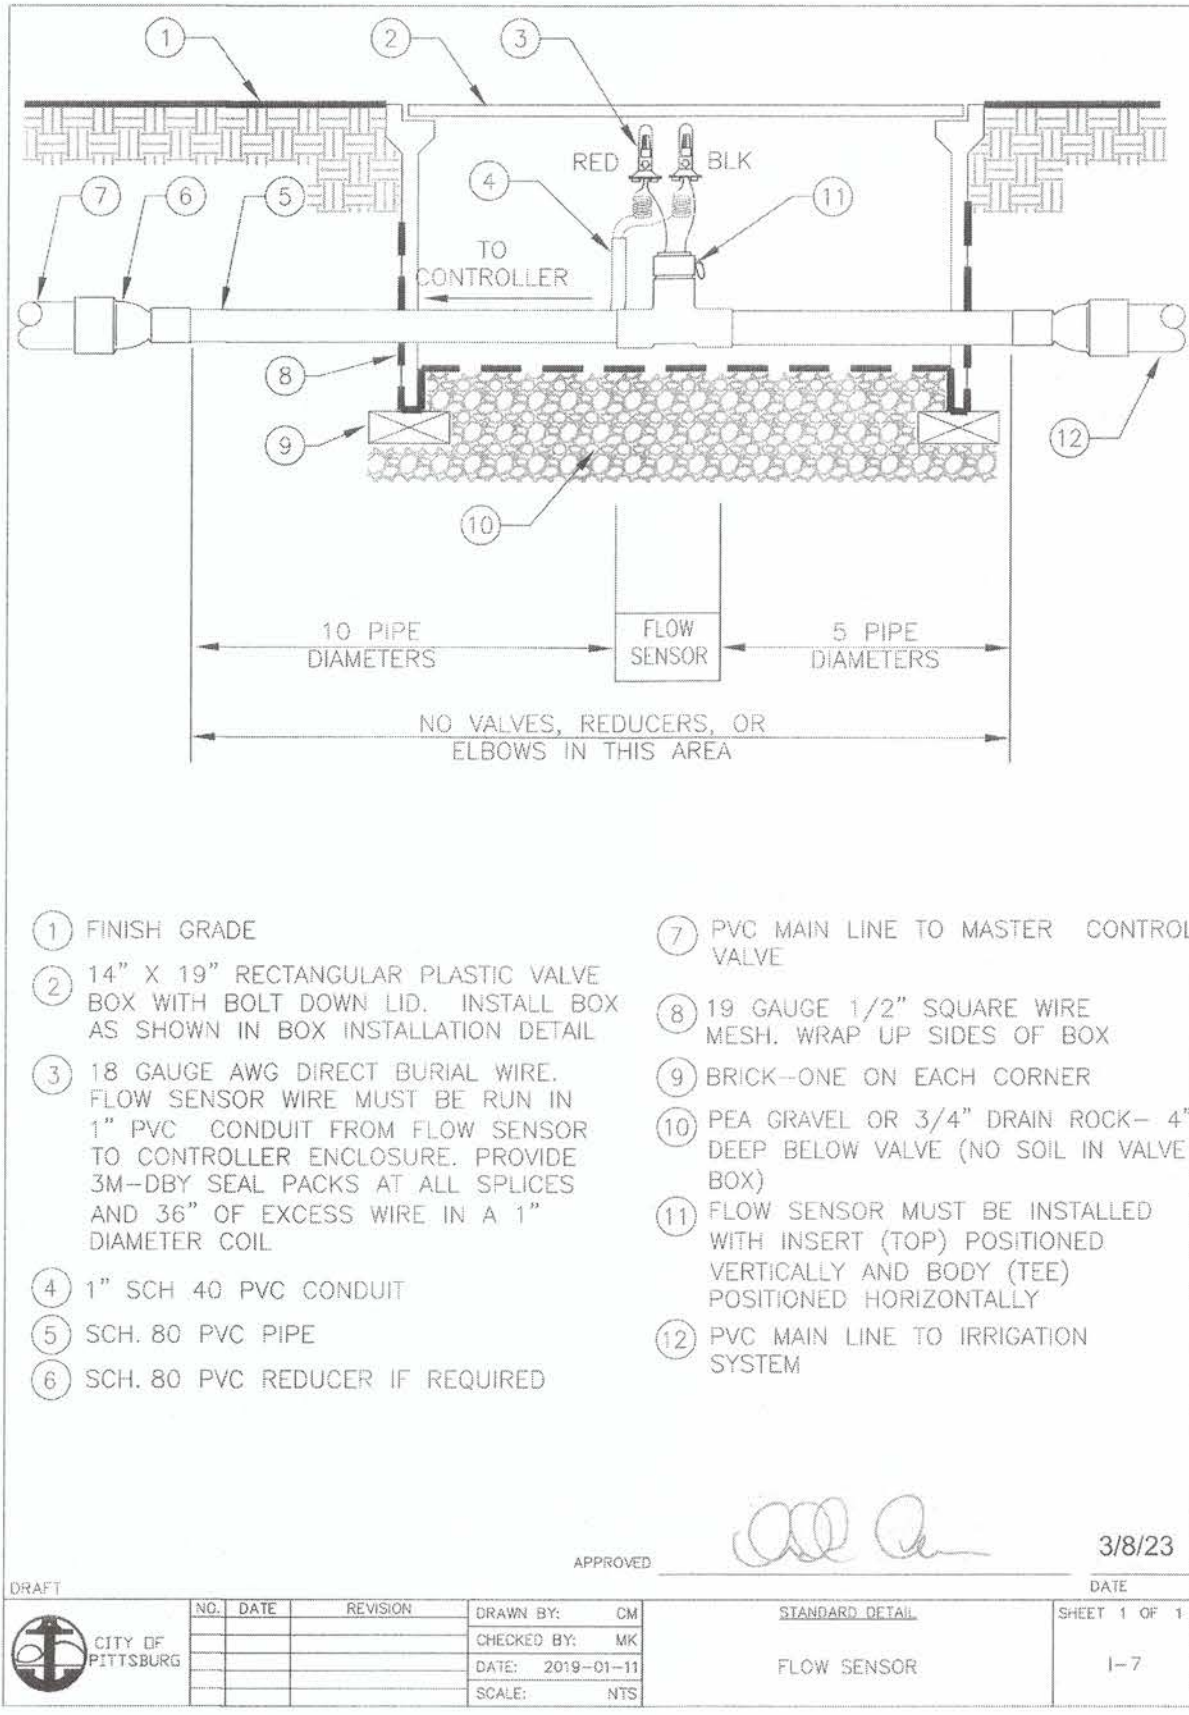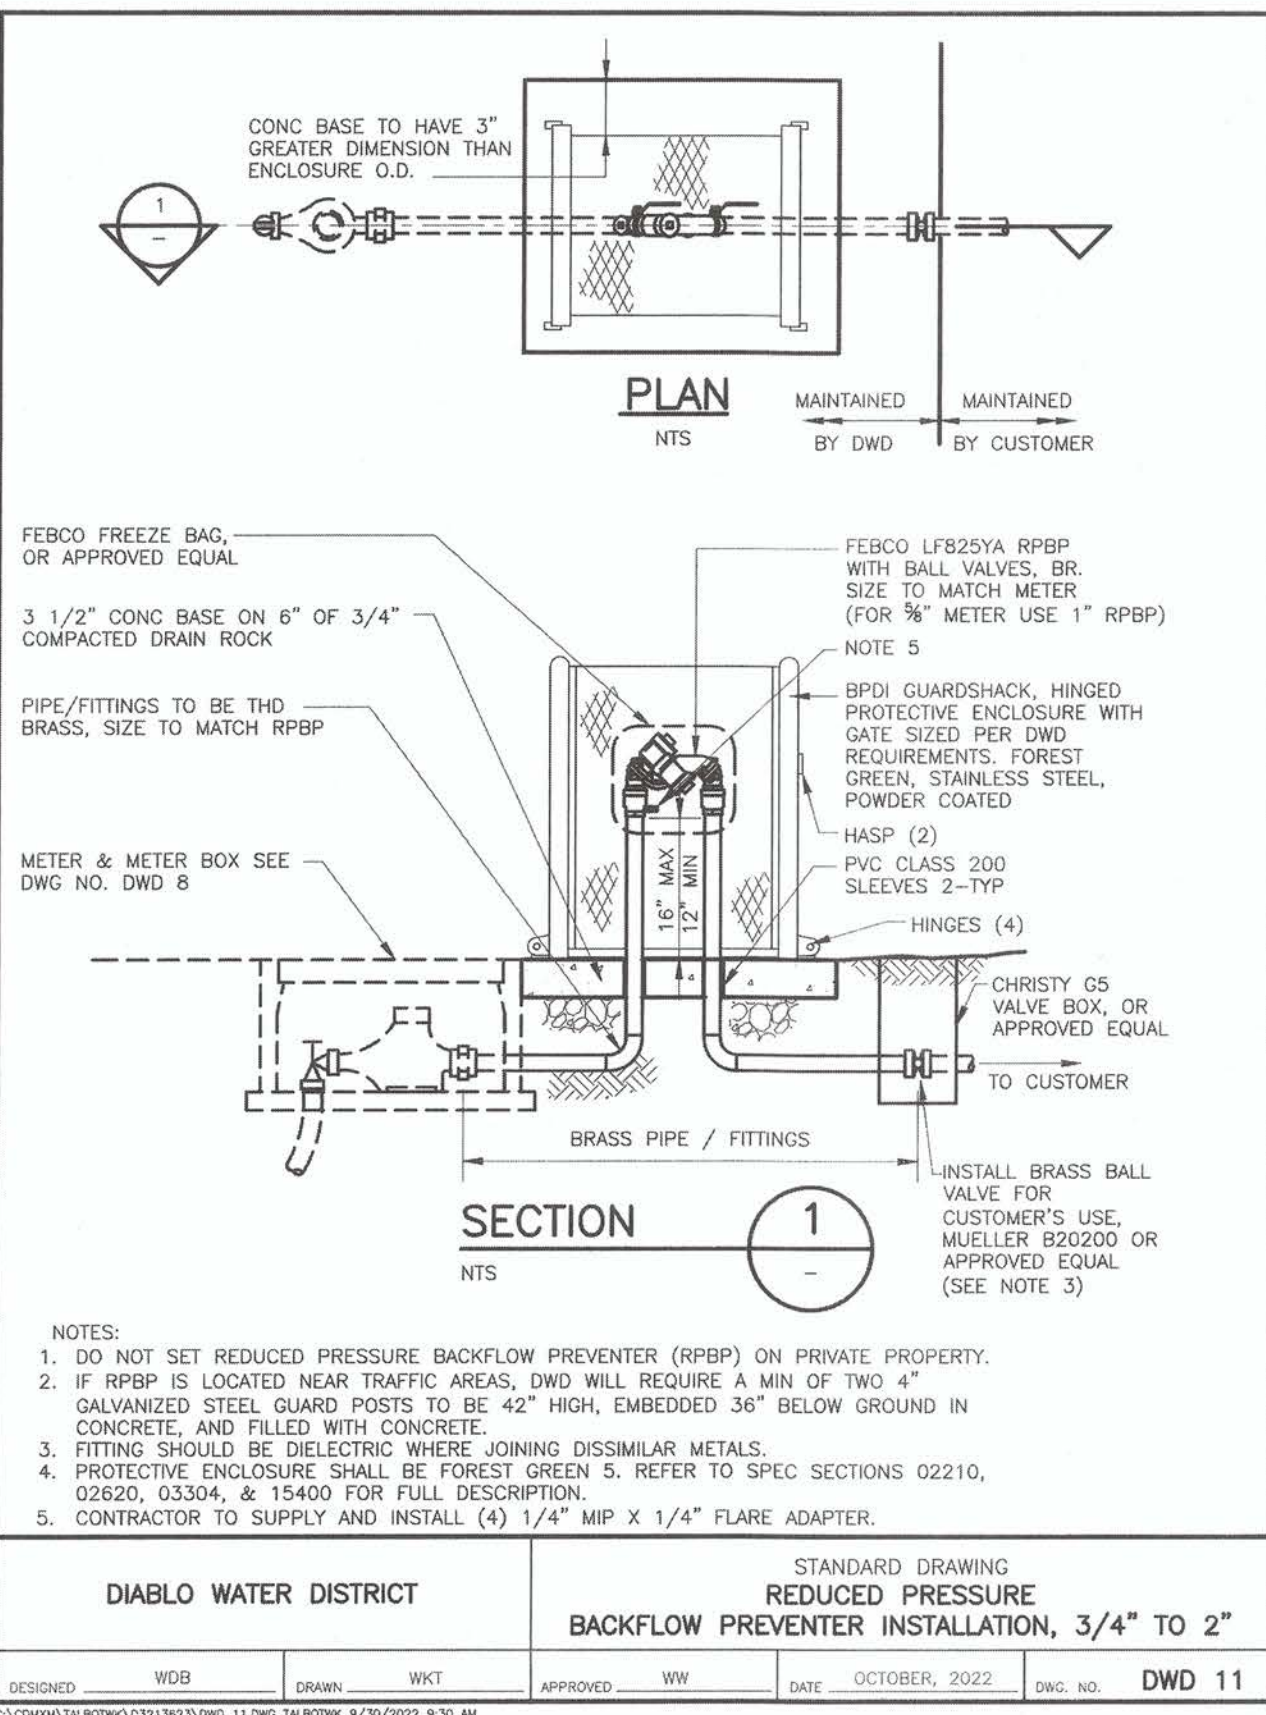
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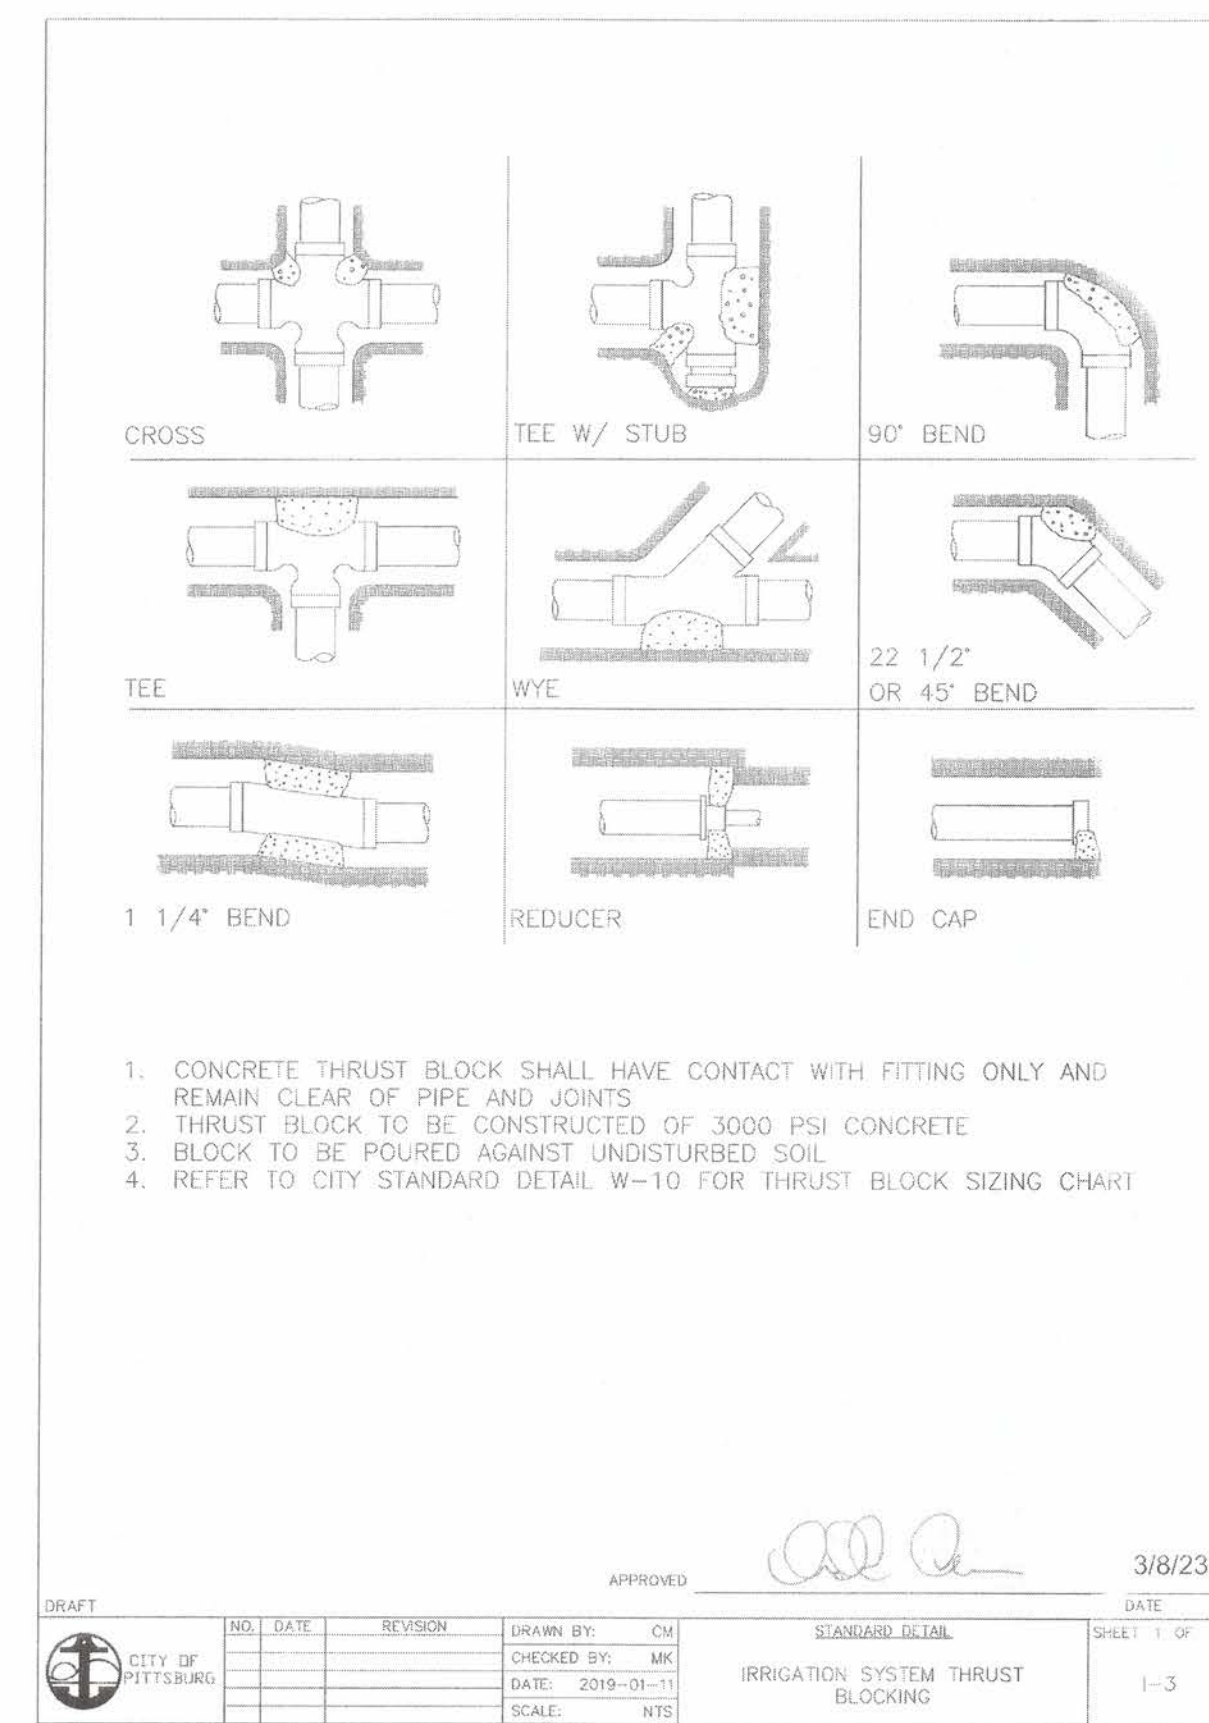
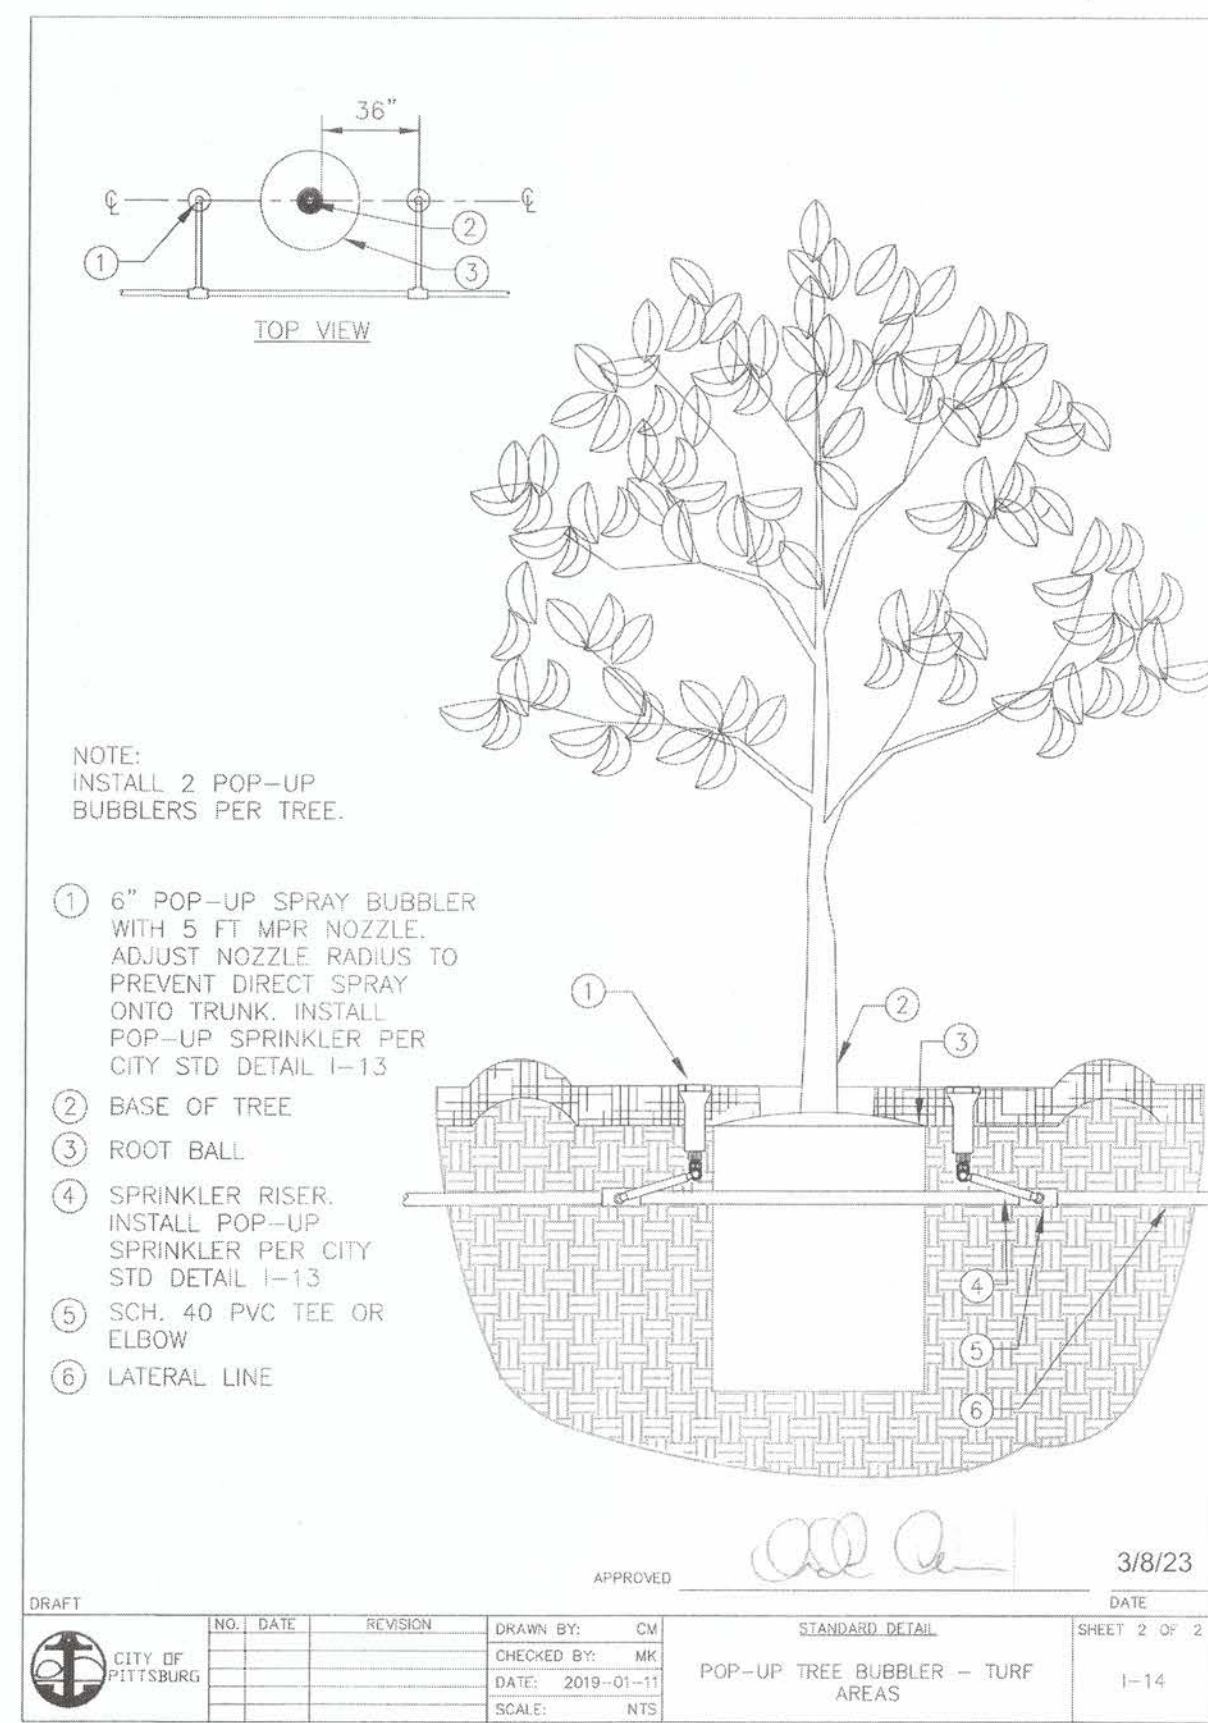
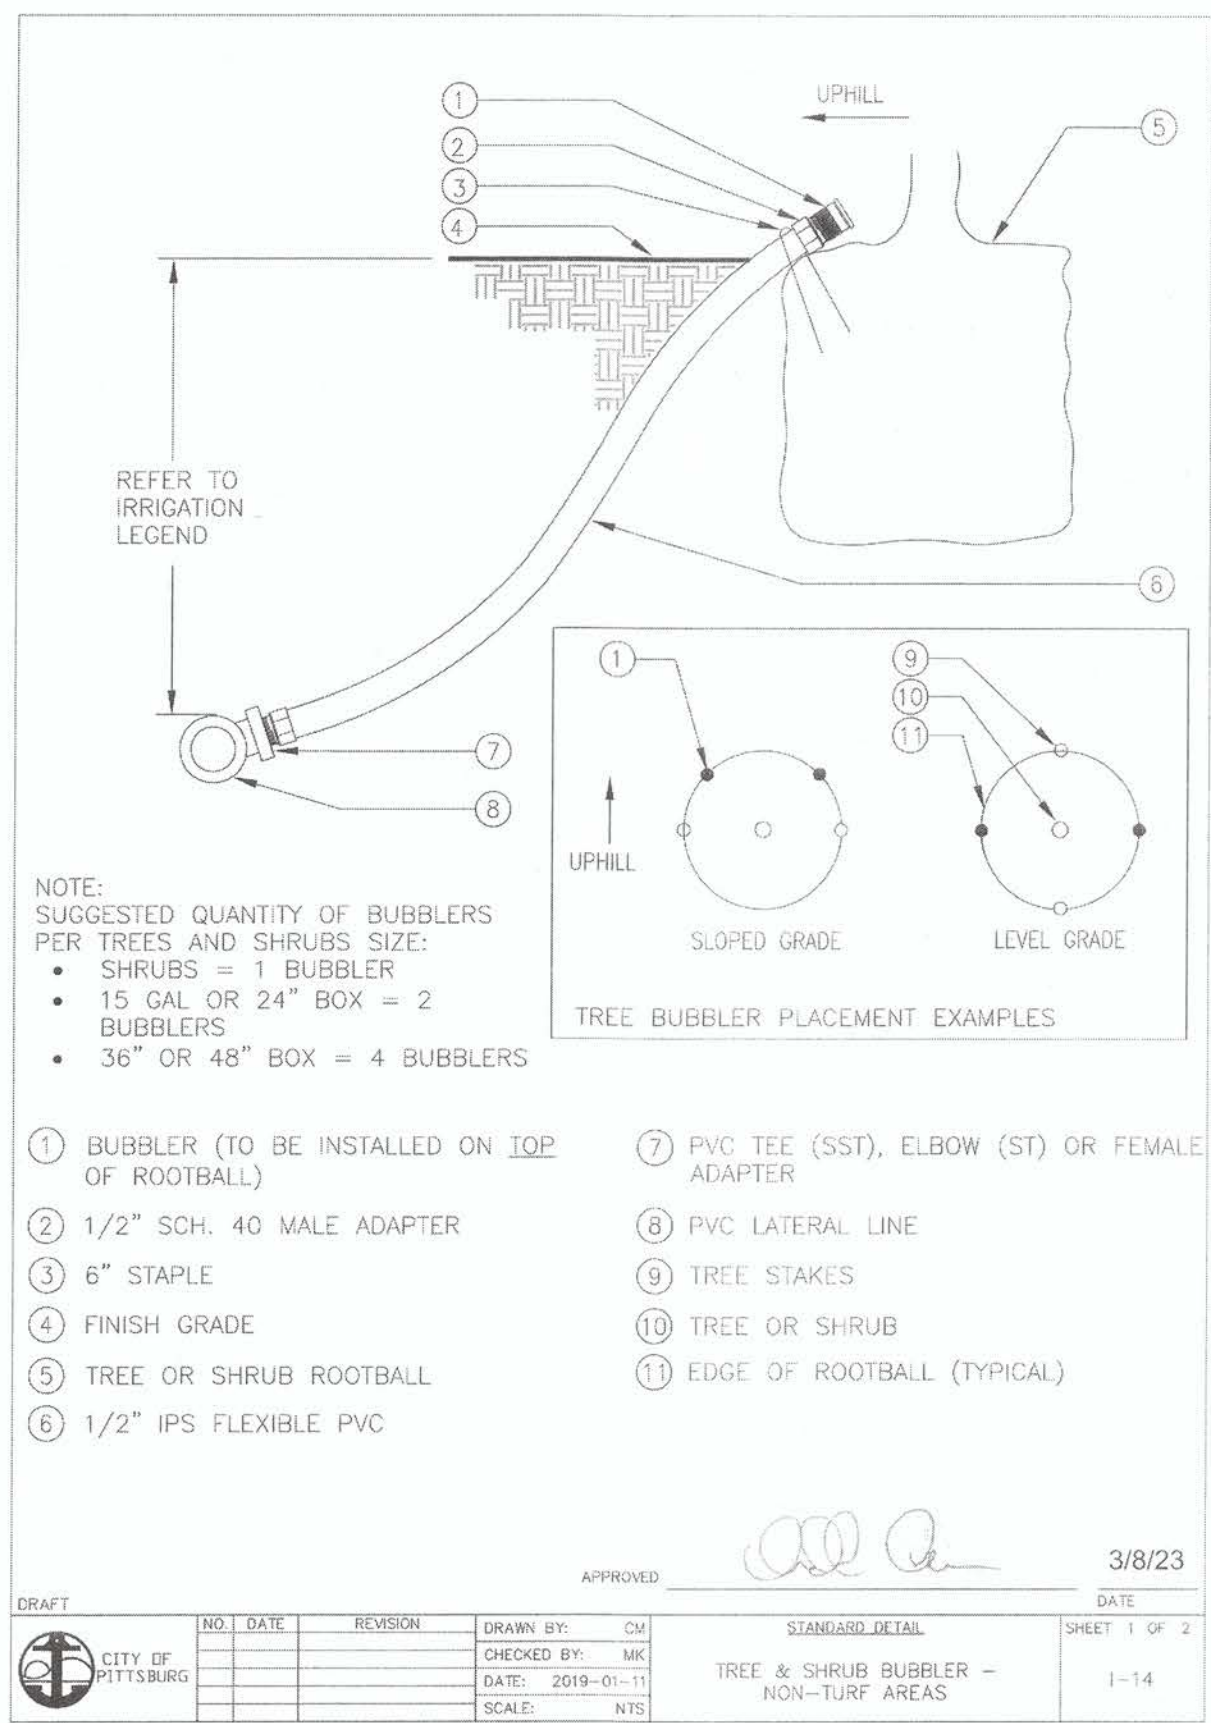
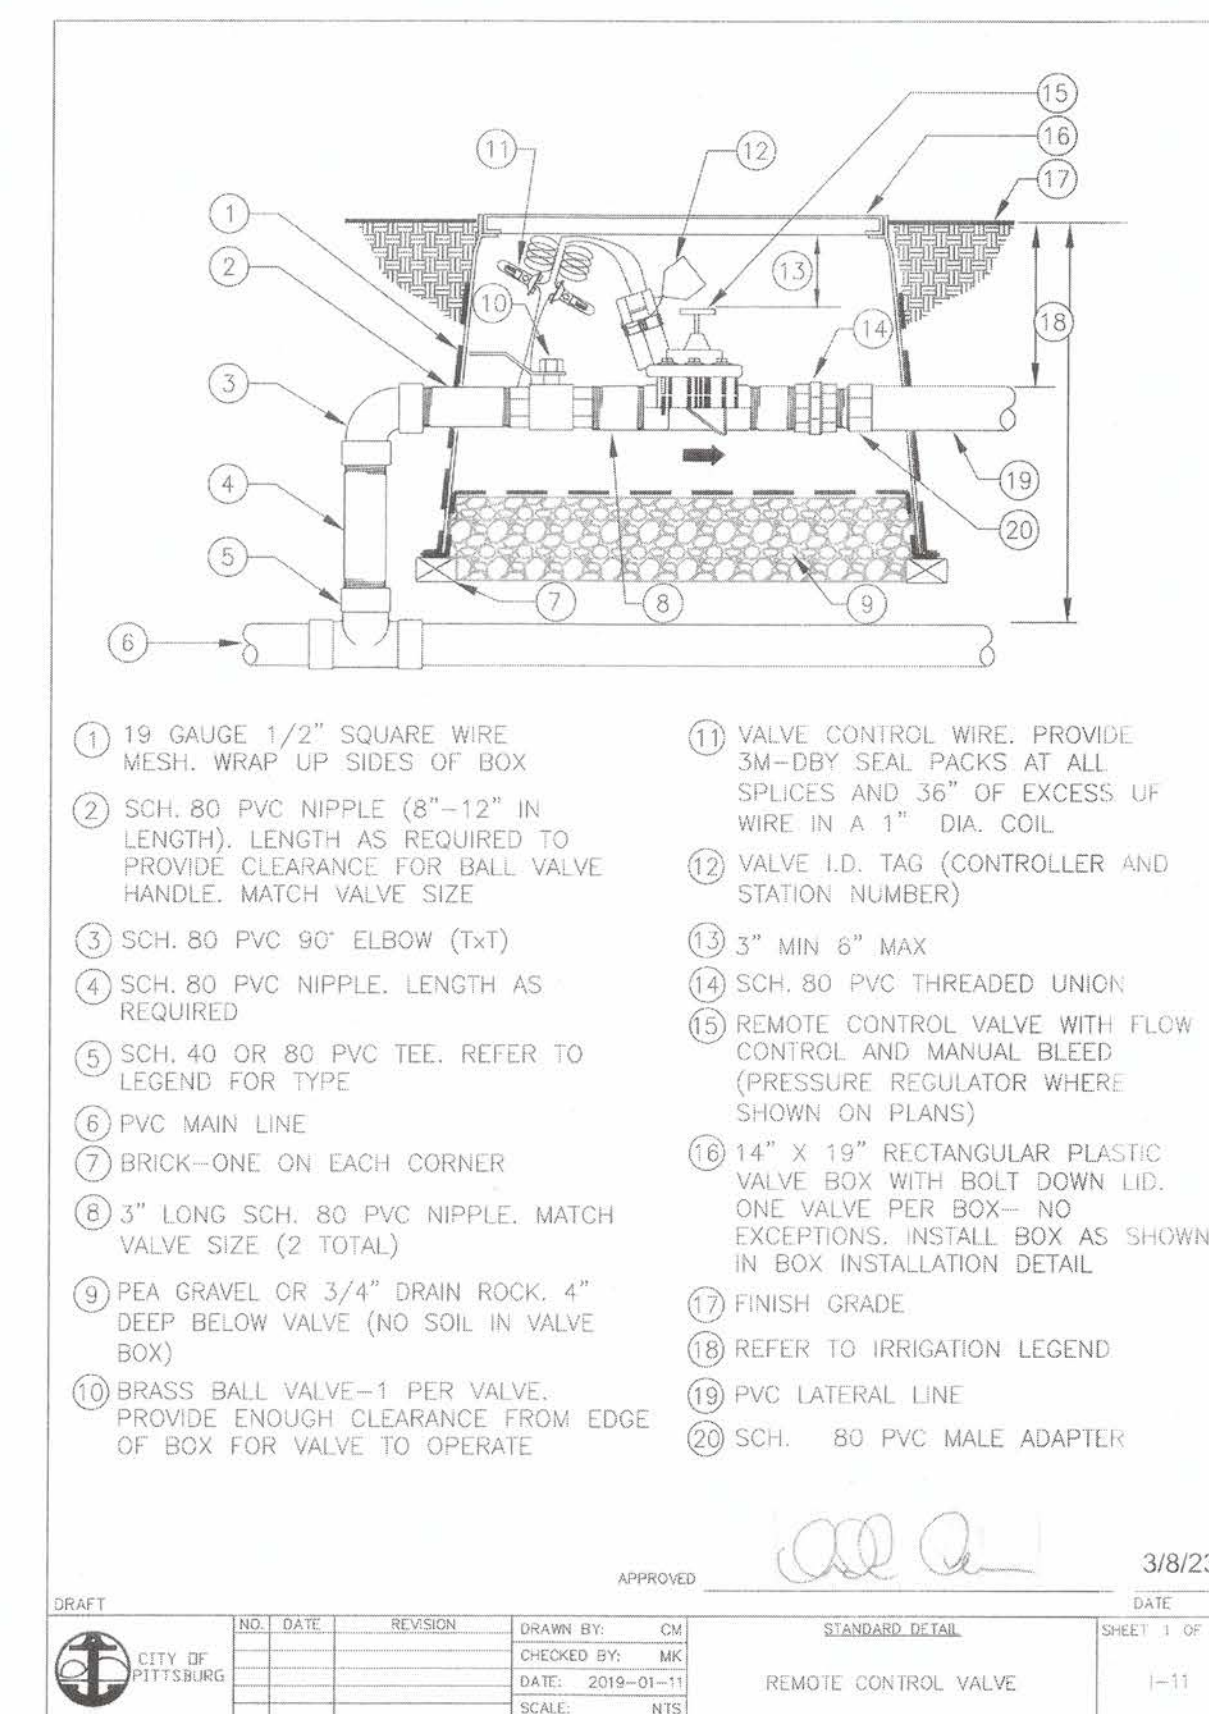
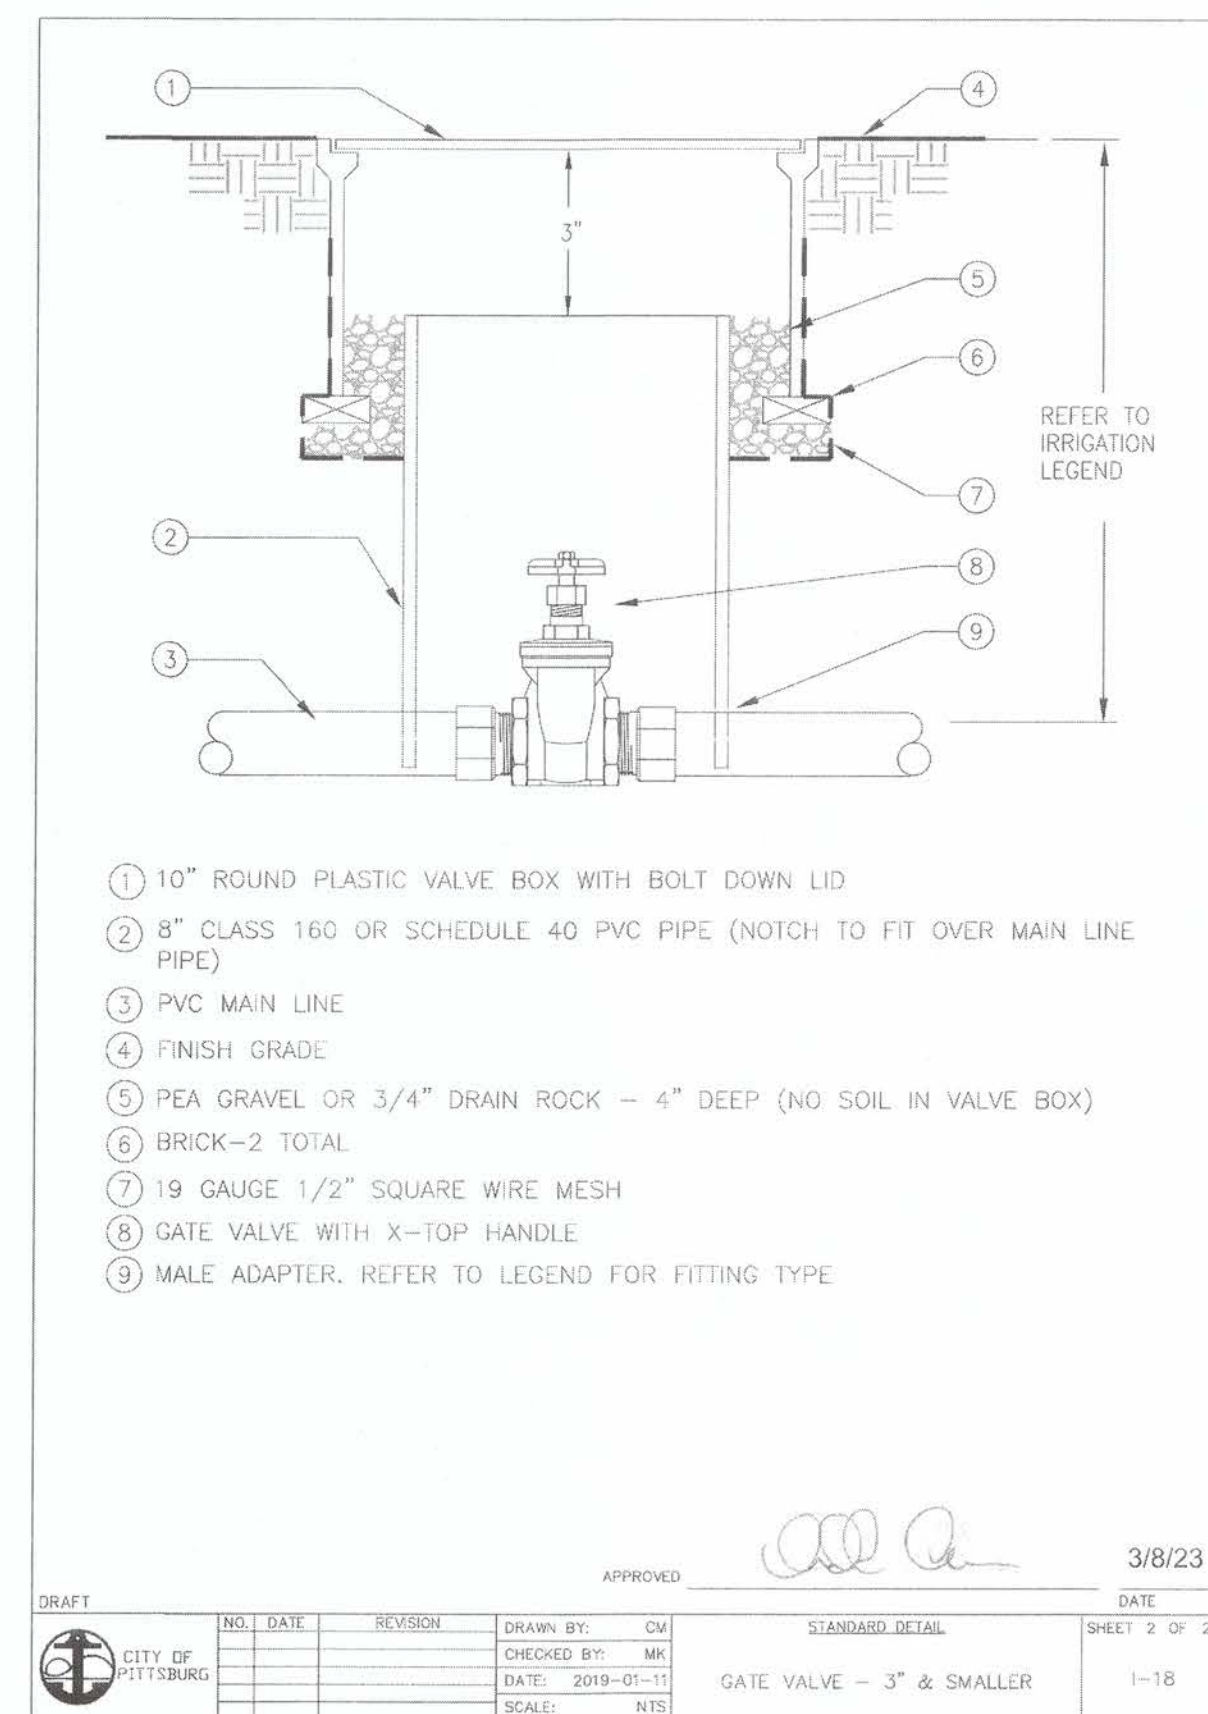
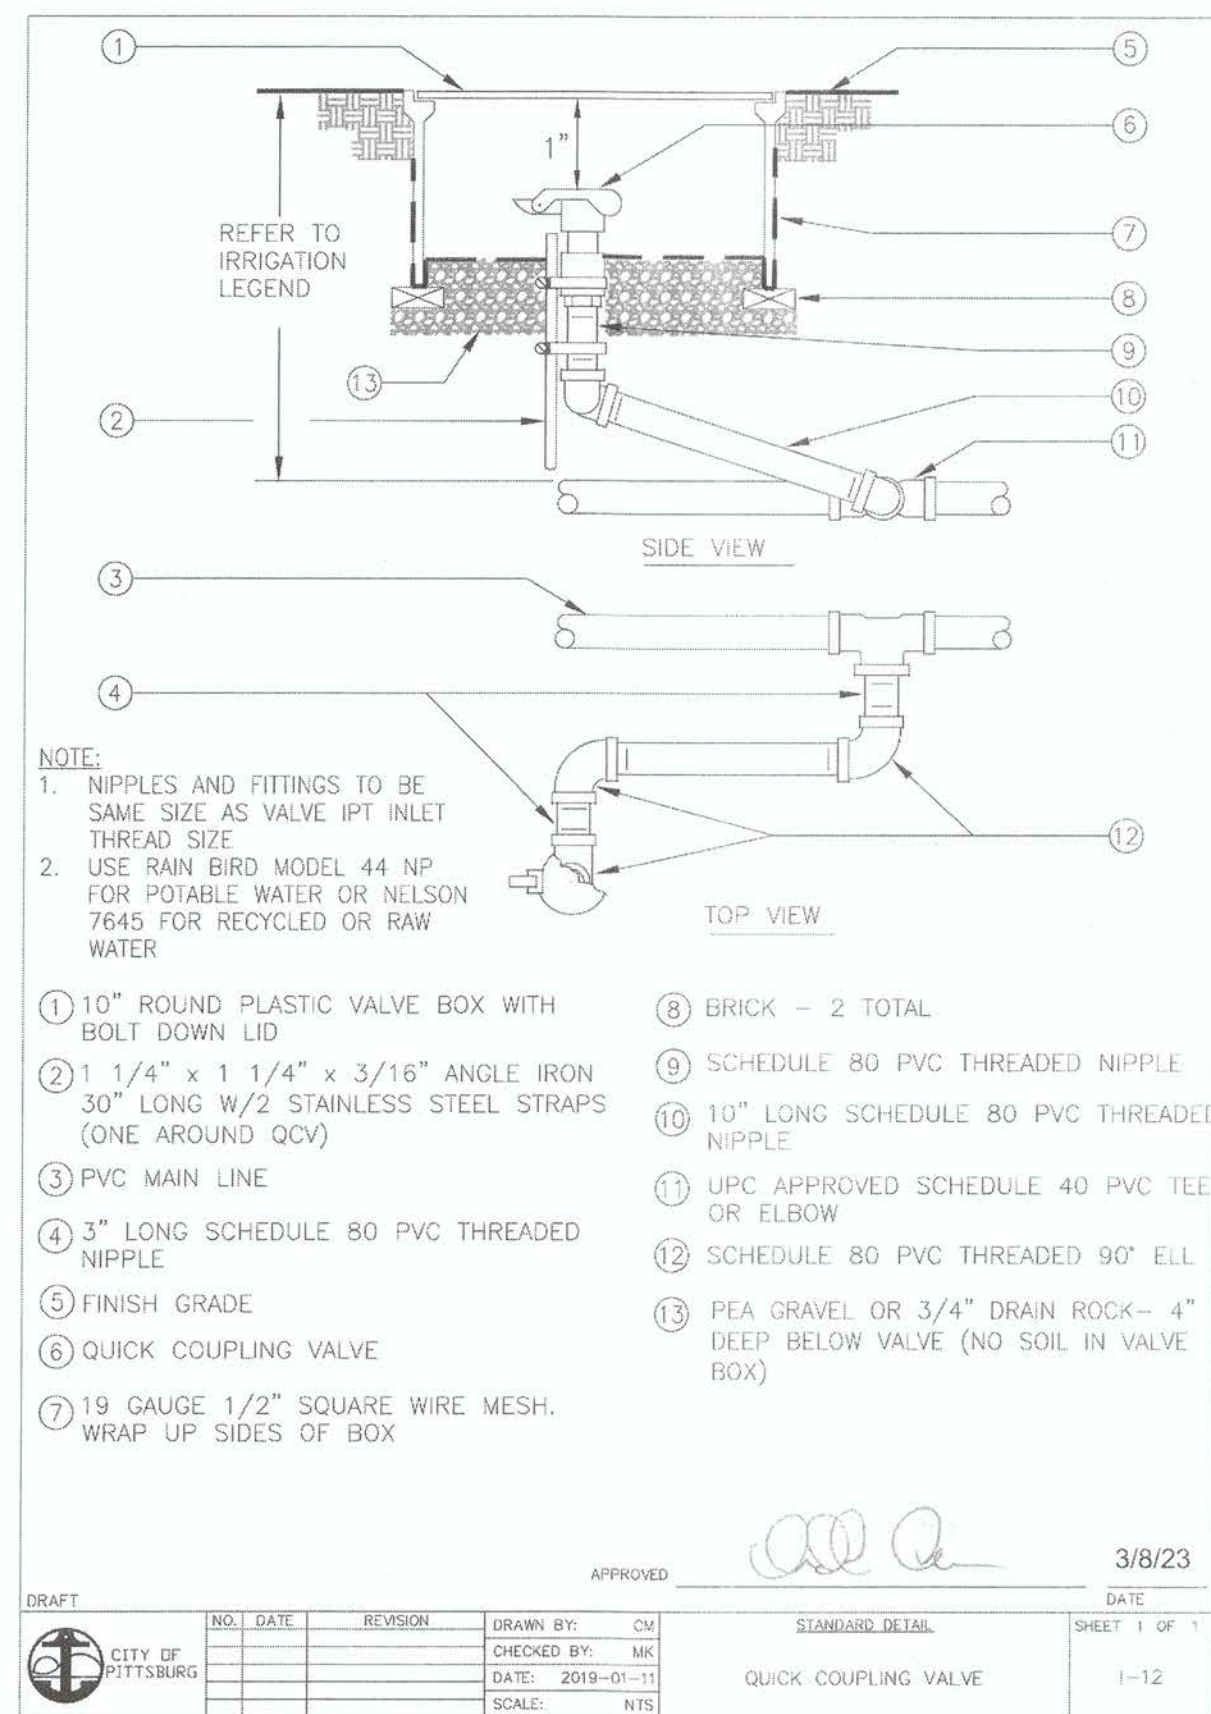


**FRONTAGE ROAD
LIVING TRAIL**
IRRIGATION DETAILS

BY: DRAWN: TZ
CHECKED: KC
REVIEWED: KC, TZ
DATE: 09/05/23
SCALE: AS SHOWN

DATE	REV	DESCRIPTION

SHEET NO.
46 OF 59
DWG. NO.
L3.08



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**FRONTAGE ROAD
 LIVING TRAIL**
 IRRIGATION DETAILS

DATE	REV	DESCRIPTION	BY	DATE

DATE	REV	DESCRIPTION	BY	DATE

SHEET NO.
47 OF 59

DWG. NO.
L3.09

WATER CALCULATION:

WATER USE ESTIMATION & IRRIGATION SCHEDULE - CONTROLLER C

WATER TYPE	POTABLE
CITY	Pittsburg
ETO	45.4
DATE	8/17/2023

Nearest City to project with published ET data

STATION/HYDROZONE	GPM	AREA (sq.ft) (HA)	WATER USE TYPE (LW=LOW, MW=MOD, HW=HIGH)	PLANT TYPE	IRRIGATION TYPE	PLANT FACTOR (PF)	IRRIGATION EFFICIENCY (IE)	PRECIP. RATE/ APPLICATION RATE (IN/HR)	ETAF (PF/IE)	CYCLES PER DAY	DAYS PER WEEK	JAN	FEB	MAR	APR	MAY	JUNE	JULY	AUG	SEP	OCT	NOV	DEC	ETWU (GALLONS PER YEAR)	PERCENTAGE OF LANDSCAPE
												MONTHLY ETO													
												1.0	1.5	2.8	4.1	5.6	6.4	7.4	6.4	5.0	3.2	1.3	0.7		
TOTAL RUN TIME IN MINUTES PER DAY												0.0	0.0	4.0	6.0	8.0	9.0	10.0	9.0	7.0	5.0	2.0	0.0	9,007	4%
TOTAL												0.0	0.0	5.0	6.0	9.0	10.0	11.0	10.0	8.0	5.0	2.0	0.0	218,734	35%

SPECIAL LANDSCAPE AREAS			
HYDROZONE #	HYDROZONE NAME	AREA (sq.ft) (HA)	Percentage of Landscape
			0%

THE IRRIGATION VALVE SCHEDULE SHOWN ABOVE IS INTENDED TO BE USED AS A GUIDELINE ONLY AND INDICATES THE APPROXIMATE RUN TIMES IN MINUTES FOR EACH VALVE BASED ON ESTIMATED WEEKLY WATER REQUIREMENTS FOR ESTABLISHED PLANT MATERIAL. THE TIMES SHOWN ARE APPROXIMATE AND HAVE BEEN DEVELOPED FROM LOCAL AND CURRENT AVERAGES FOR EVAPOTRANSPIRATION, AND REFLECT THE WATER REQUIREMENTS OF THE PLANT MATERIAL BASED ON PLANT TYPE AND THE APPROXIMATE PRECIPITATION OR APPLICATION RATES OF THE IRRIGATION SYSTEM TYPE. ACTUAL RUN TIMES MAY BE DIFFERENT DEPENDING ON A VARIETY OF FACTORS INCLUDING TOPOGRAPHY, SOIL STRUCTURE, SUN AND WIND EXPOSURE, WEATHER, ACTUAL PLANT WATER REQUIREMENTS, OVERALL PRECIPITATION RATE OF ZONE, ETC.

MAWA	GALLONS/YR	261,135
	ACRE FEET/YR	0.80
	HCF/YR	349.11

MAWA FORMULA
MAXIMUM APPLIED WATER ALLOWANCE (MAWA) GALLONS PER YEAR
$MAWA = (ETO)(0.62)[(LA \times 0.45) + (0.55 \times SLA)]$

ETO = REFERENCE EVAPOTRANSPIRATION
 0.45 = ET ADJUSTMENT FACTOR
 LA = LANDSCAPED AREA (SQUARE FEET)
 0.62 = CONVERSION FACTOR (GALLONS/SQ.FT/YR)

ETWU FORMULA
ESTIMATED TOTAL WATER USE (ETWU) GALLONS PER YEAR
$ETWU = ((ETO)(.62)(ETAF \times LA))$

ETO = REFERENCE EVAPOTRANSPIRATION
 PF = PLANT FACTOR FOR HYDROZONES
 HA = HYDROZONE AREA (SQ. FT)
 0.62 = CONVERSION FACTOR (GALLONS/SQ.FT/YR)
 IE = IRRIGATION EFFICIENCY (0.81)-BUBBLER/DRIP
 IE = IRRIGATION EFFICIENCY (0.75)-ROTORS/SPRAY


ETWU	GALLONS/YR	218,734
	ACRE FEET/YR	0.67
	HCF/YR	292.43

SITE IRRIGATION EFFICIENCY	SITE PLANT FACTOR	MAWA COMPLIANT
28.2%	0.10	YES

ETAF Calculations	
REGULAR LANDSCAPE AREAS	
TOTAL ETAF x AREA	2,670
TOTAL AREA	20,616
AVG. ETAF	12.95%



GATES ASSOCIATES
 LANDSCAPE ARCHITECTURE
 LAND PLANNING - URBAN DESIGN
 1821 MARSH STREET, SUITE 100, WILMINGTON, MISSOURI 64490
 WWW.GATESASSOCIATES.COM

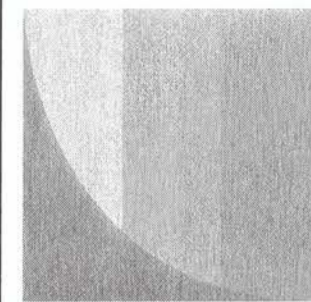

ACCEPTED FOR USE:
 JOHN SAMUELSON
 City Engineer
 Date: 8/16/23




FRONTAGE ROAD LIVING TRAIL
 IRRIGATION WATER CALCULATIONS

BY: DRAWN: TZ	CHECKED: KC	REVIEWED: KC, TZ	DATE: 09/05/23	SCALE: AS SHOWN
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DATE	REV	DESCRIPTION

SHEET NO. 48 OF 59
 DWG. NO. L3.10


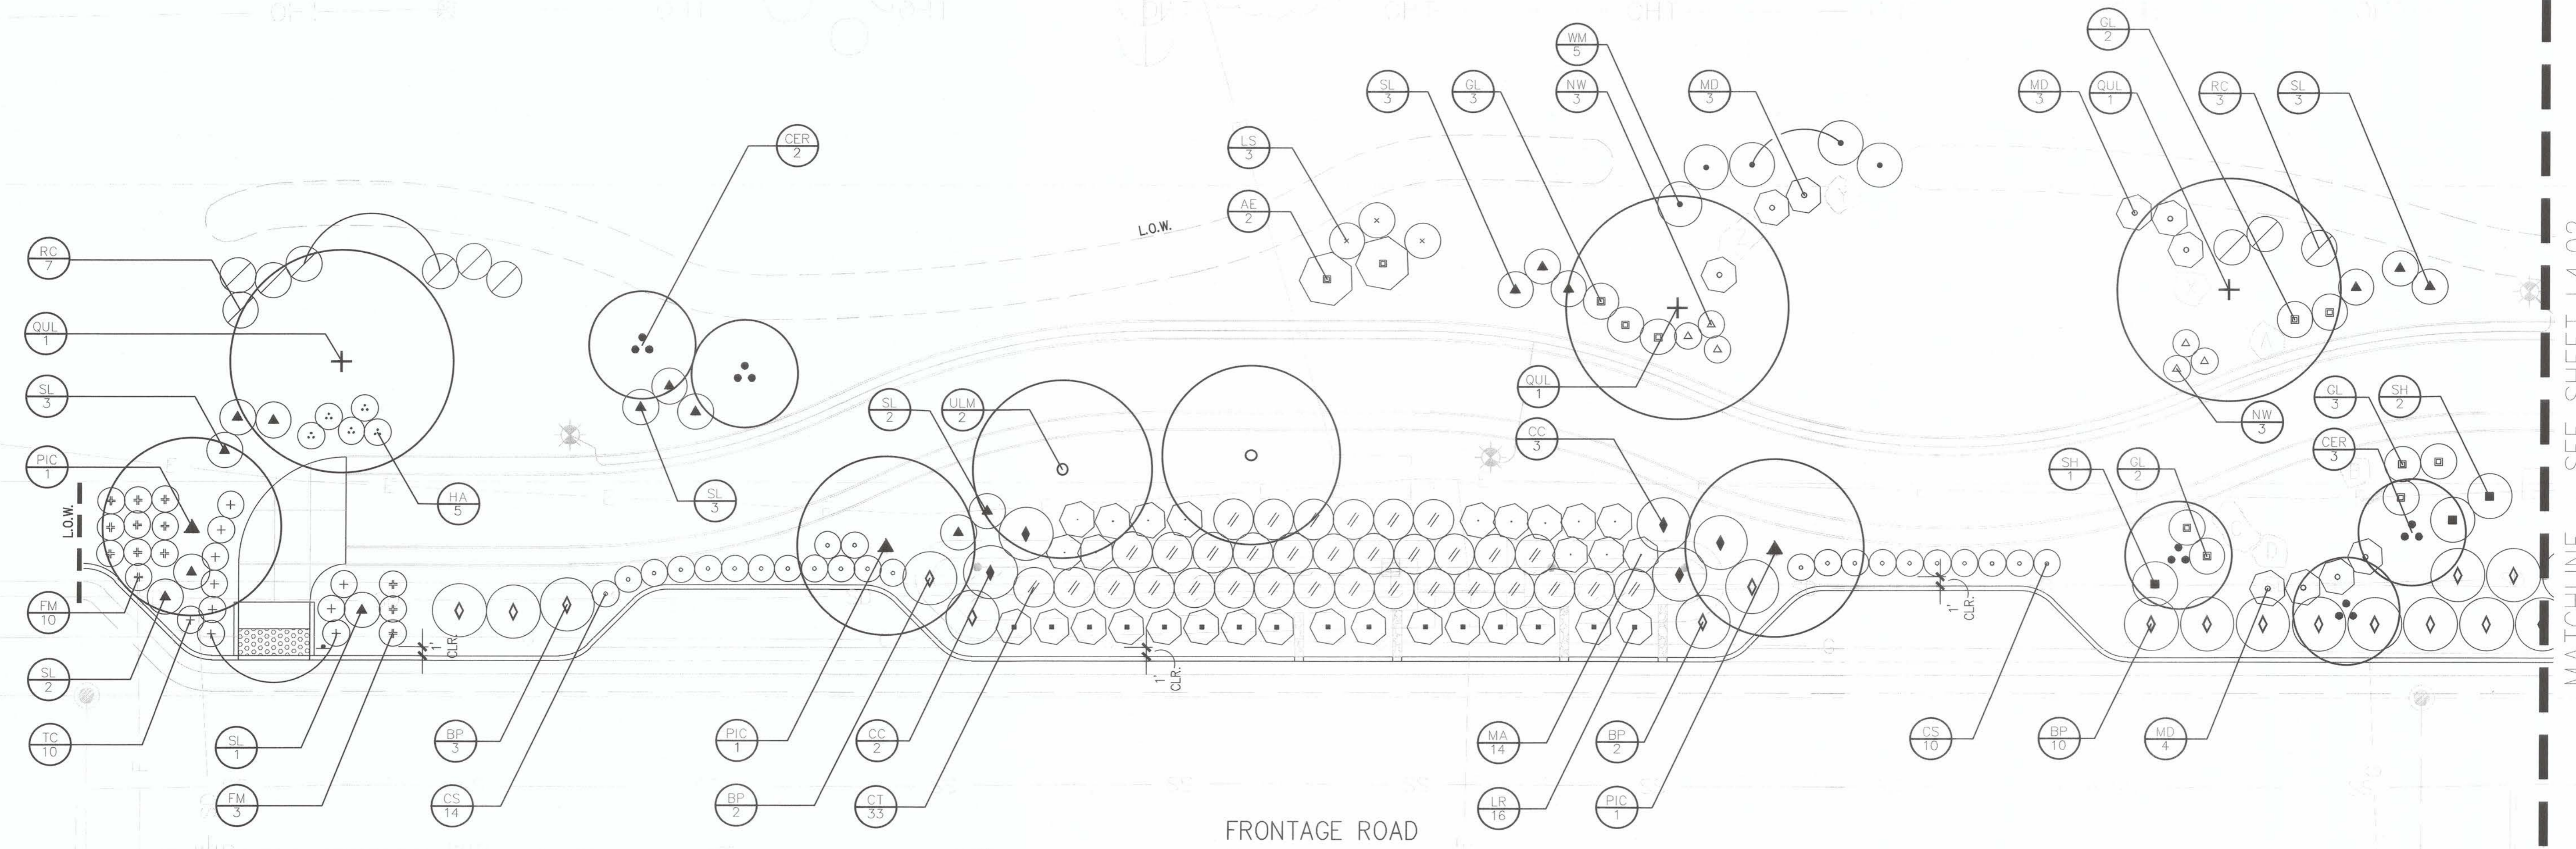


MATCHLINE - SEE SHEET L4.02

PLANTING SCHEDULE

TREES	BOTANICAL NAME	COMMON NAME	SIZE	WATER USE	SPACING	QTY
ACB	ACER BUERGERIANUM	TRIDENT MAPLE	24"BOX	L	AS SHOWN	10
CER	CERCIS OCCIDENTALIS	WESTERN REDBUD	24"BOX	VL	AS SHOWN	23
OES	OLEA EUROPAEA 'SWAN HILL'	SWAN HILL FRUITLESS OLIVE	24"BOX	VL	AS SHOWN	4
PIC	PISTACIA CHINENSIS	CHINESE PISTACHE	24"BOX	L	AS SHOWN	5
QUL	QUERCUS LOBATA	VALLEY OAK	24"BOX	VL	AS SHOWN	7
ULM	ULMUS CARPINIFOLIA X PARVIFOLIA 'FRONTIER'	FRONTIER ELM	24"BOX	L	AS SHOWN	16

SHRUBS	BOTANICAL NAME	COMMON NAME	SIZE	WATER USE	SPACING	QTY
AE	ARCTOSTAPHYLOS X 'EMERALD CARPET'	EMERALD CARPET MANZANITA	1 GAL	L	72" o.c.	21
BP	BACCHARIS PILULARIS 'TWIN PEAKS'	DWARF COYOTE BRUSH	1 GAL	L	72" o.c.	93
CS	CALANDRINIA SPECTABILIS 'SHINING PINK'	SHINING PINK CALANDRINIA	1 GAL	L	36" o.c.	34
CT	CHONDROPETALUM TECTORUM 'EL CAMPO'	SMALL CAPE RUSH	5 GAL	L	54" o.c.	299
CC	CORREA X 'CARMINE BELLS'	CARMINE BELLS AUSTRALIAN FUCHSIA	1 GAL	L	72" o.c.	46
FM	FESTUCA MAIREI	ATLAS FESCUE	1 GAL	L	36" o.c.	61
GL	GREVILLEA LANIGERA 'COASTAL GEM'	COASTAL GEM GREVILLEA	1 GAL	L	48" o.c.	27
HA	HELENIUM AUTUMNALE	SNEEZEWEEED	1 GAL	M	36" o.c.	27
HP	HESPERALOE PARVIFLORA 'PERPA'	BRAKELIGHTS®RED YUCCA	5 GAL	L	36" o.c.	10
LR	LANTANA CAMARA 'LANZ0001'	BANDANA®ROSE IMPROVED LANTANA	1 GAL	L	48" o.c.	149
LS	LEUCADENDRON SALIGNUM 'WINTER RED'	WINTER RED CONEBUSH	5 GAL	L	48" o.c.	25
MA	MIMULUS AURANTIACUS	BUSH MONKEYFLOWER	1 GAL	L	48" o.c.	69
MD	MUHLENBERGIA DUBIA	PINE MUHLY	1 GAL	L	48" o.c.	59
NW	NEPETA X 'WALKER'S LOW'	WALKER'S LOW CATMINT	1 GAL	L	36" o.c.	31
RC	RHAMNUS CALIFORNICA 'MOUND SAN BRUNO'	MOUND SAN BRUNO COFFEEBERRY	1 GAL	L	48" o.c.	39
SL	SALVIA LEUCANTHA 'SANTA BARBARA'	MEXICAN BUSH SAGE	5 GAL	L	48" o.c.	66
SH	SALVIA MICROPHYLLA 'HOT LIPS'	HOT LIPS GRAHAM SAGE	5 GAL	L	60" o.c.	15
TC	TEUCRIUM CHAMAEDRYS	GERMANDER	1 GAL	L	36" o.c.	65
WM	WESTRINGIA FRUTICOSA 'MORNING LIGHT'	MORNING LIGHT COAST ROSEMARY	1 GAL	L	60" o.c.	11

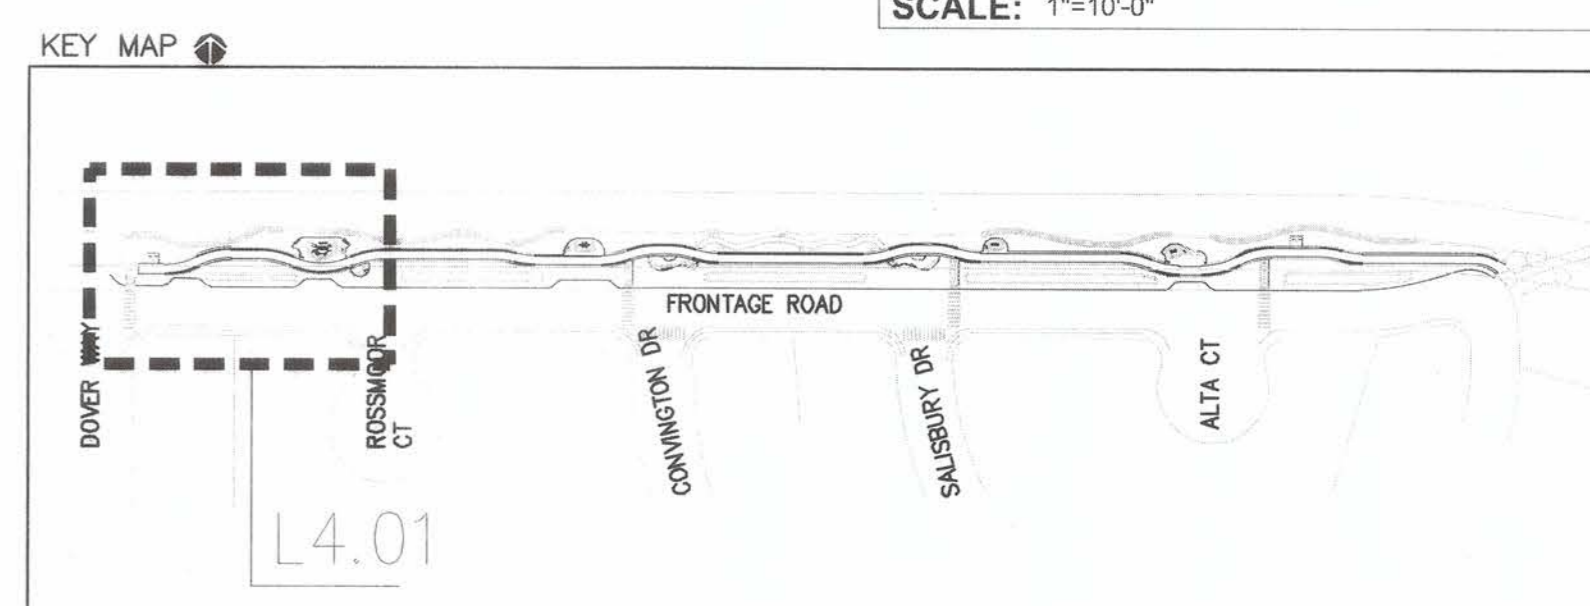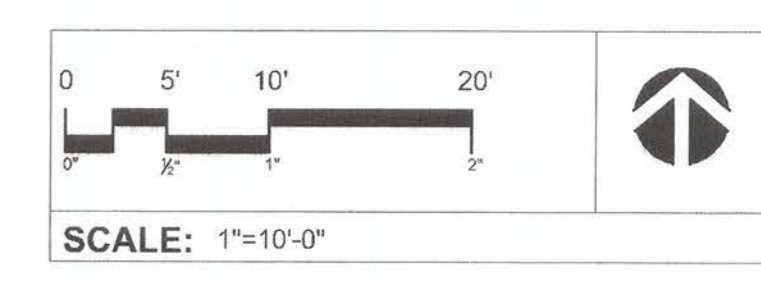

GATES + ASSOCIATES
 LANDSCAPE ARCHITECTURE
 LAND PLANNING • URBAN DESIGN
 800 N. WEDGE STREET, SUITE 1000, COVINGTON, LA 70022
 TEL: 504.835.1774 WWW.GATESLA.COM


ACCEPTED FOR USE:
 JOHN SAMUELSON
 City Engineer
 Date: 9/26/23



FRONTAGE ROAD LIVING TRAIL
 PLANTING PLAN

BY	DESCRIPTION
DRAWN: TZ	
CHECKED: KC	
REVIEWED: KC, TZ	
DATE: 09/05/23	
SCALE: AS SHOWN	

SHEET NO.
49 OF 59
 DWG. NO.
L4.01

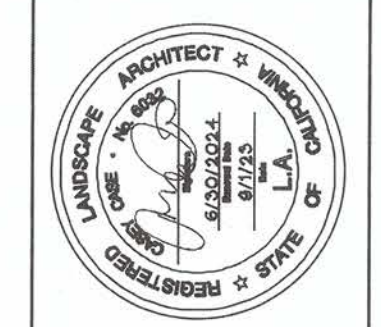

GATES + ASSOCIATES
 LANDSCAPE ARCHITECTURE
 LAND PLANNING + URBAN DESIGN
 18174 MISSOURI LICENSE NO. 18174
 T. 931.734.1174 F. 931.734.1174

ACCEPTED FOR USE:

JOHN SAMUELSON
 City Engineer
 Date: 9/24/23




FRONTAGE ROAD LIVING TRAIL
 PLANTING PLAN

DRAWN: TZ
 CHECKED: KC
 REVIEWED: KC, TZ
 DATE: 09/05/23
 SCALE: AS SHOWN

DATE	REV	DESCRIPTION



SHEET NO.
50 OF 59
 DWG. NO.
L4.02

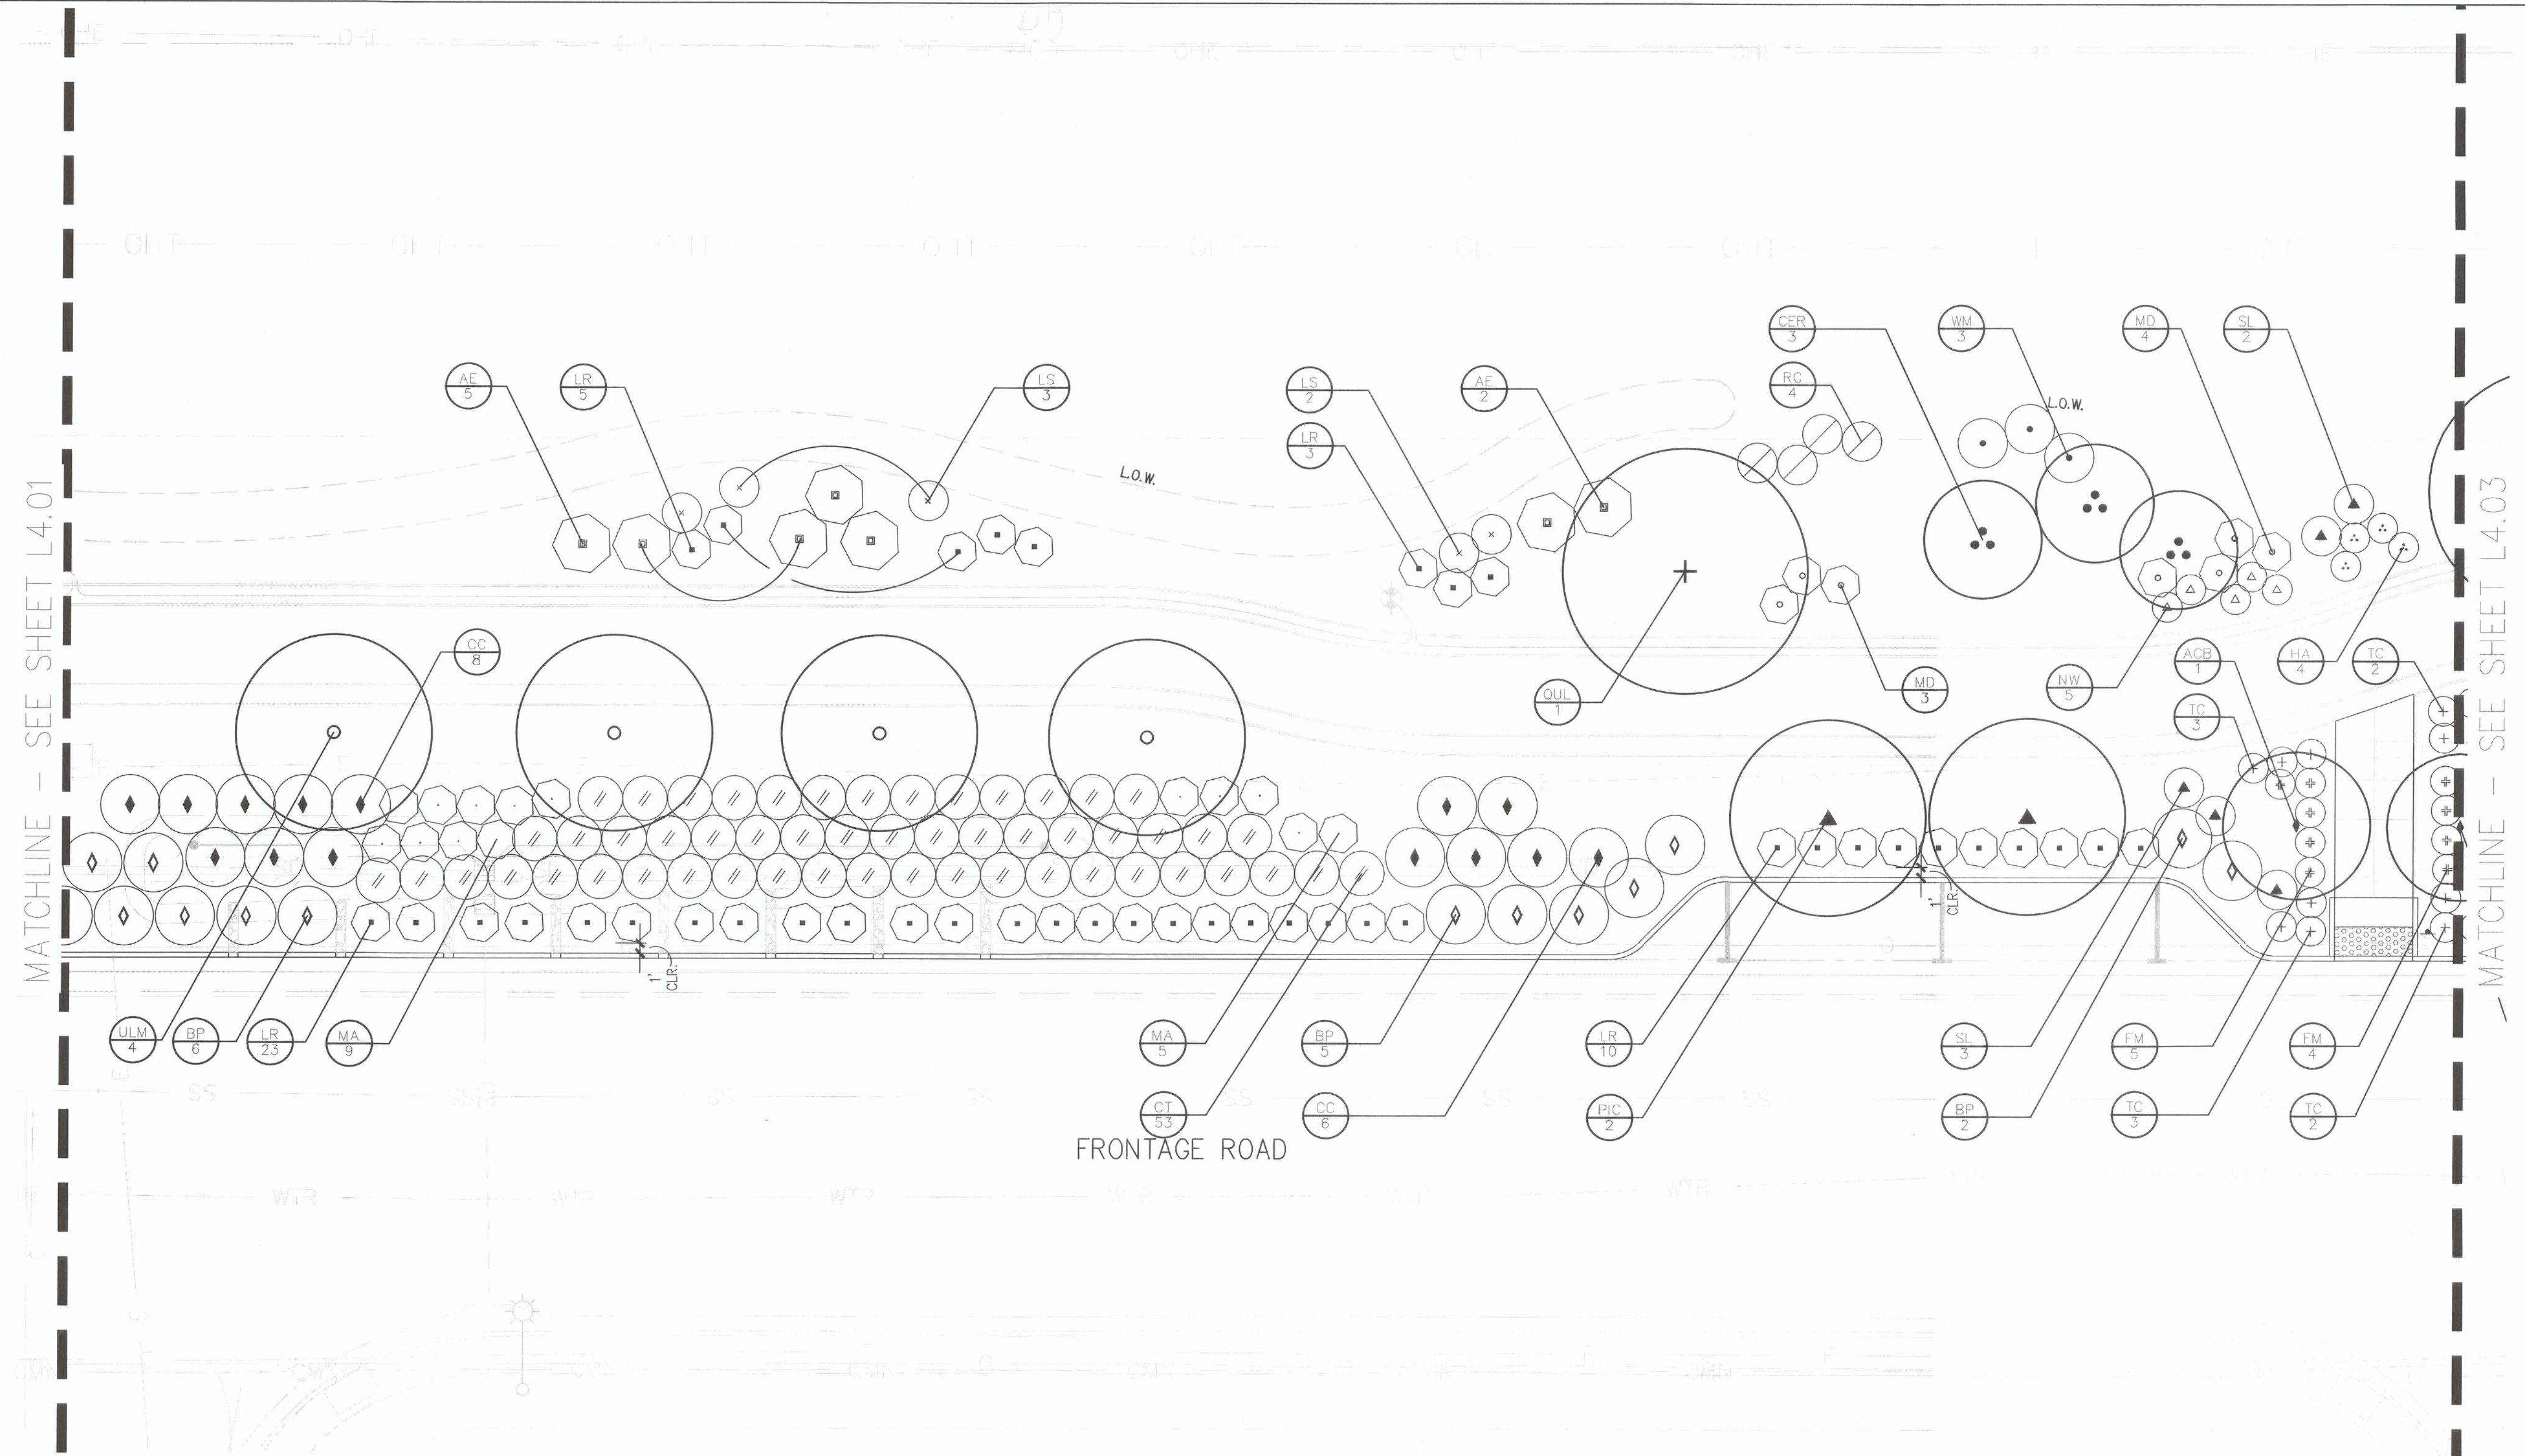

PLANTING SCHEDULE


TREES	BOTANICAL NAME	COMMON NAME	SIZE	WATER USE	SPACING	QTY
ACB	ACER BUERGERIANUM	TRIDENT MAPLE	24"BOX	L	AS SHOWN	10
CER	CERCIS OCCIDENTALIS	WESTERN REDBUD	24"BOX	VL	AS SHOWN	23
OES	OLEA EUROPAEA 'SWAN HILL'	SWAN HILL FRUITLESS OLIVE	24"BOX	VL	AS SHOWN	4
PIC	PISTACIA CHINENSIS	CHINESE PISTACHE	24"BOX	L	AS SHOWN	5
QUL	QUERCUS LOBATA	VALLEY OAK	24"BOX	VL	AS SHOWN	7
ULM	ULMUS CARPINIFOLIA X PARVIFOLIA 'FRONTIER'	FRONTIER ELM	24"BOX	L	AS SHOWN	16

SHRUBS	BOTANICAL NAME	COMMON NAME	SIZE	WATER USE	SPACING	QTY
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CS	CALANDRINIA SPECTABILIS 'SHINING PINK'	SHINING PINK CALANDRINIA	1 GAL	L	36" o.c.	34
CT	CHONDROPETALUM TECTORUM 'EL CAMPO'	SMALL CAPE RUSH	5 GAL	L	54" o.c.	299
CC	CORREA X 'CARMINE BELLS'	CARMINE BELLS AUSTRALIAN FUCHSIA	1 GAL	L	72" o.c.	46
FM	FESTUCA MAIREI	ATLAS FESCUE	1 GAL	L	36" o.c.	61
GL	GREVILLEA LANIGERA 'COASTAL GEM'	COASTAL GEM GREVILLEA	1 GAL	L	48" o.c.	27
HA	HELENIUM AUTUMNALE	SNEEZEWEED	1 GAL	M	36" o.c.	27
HP	HESPERALOE PARVIFLORA 'PERPA'	BRAKELIGHTS®RED YUCCA	5 GAL	L	36" o.c.	10
LR	LANTANA CAMARA 'LANZ0001'	BANDANA®ROSE IMPROVED LANTANA	1 GAL	L	48" o.c.	149
LS	LEUCADENDRON SALIGNUM 'WINTER RED'	WINTER RED CONEBUSH	5 GAL	L	48" o.c.	25
MA	MIMULUS AURANTIACUS	BUSH MONKEYFLOWER	1 GAL	L	48" o.c.	69
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SL	SALVIA LEUCANTHA 'SANTA BARBARA'	MEXICAN BUSH SAGE	5 GAL	L	48" o.c.	66
SH	SALVIA MICROPHYLLA 'HOT LIPS'	HOT LIPS GRAHAM SAGE	5 GAL	L	60" o.c.	15
TC	TEUCRIUM CHAMAEDRYS	GERMANDER	1 GAL	L	36" o.c.	65
WM	WESTRINGIA FRUTICOSA 'MORNING LIGHT'	MORNING LIGHT COAST ROSEMARY	1 GAL	L	60" o.c.	11

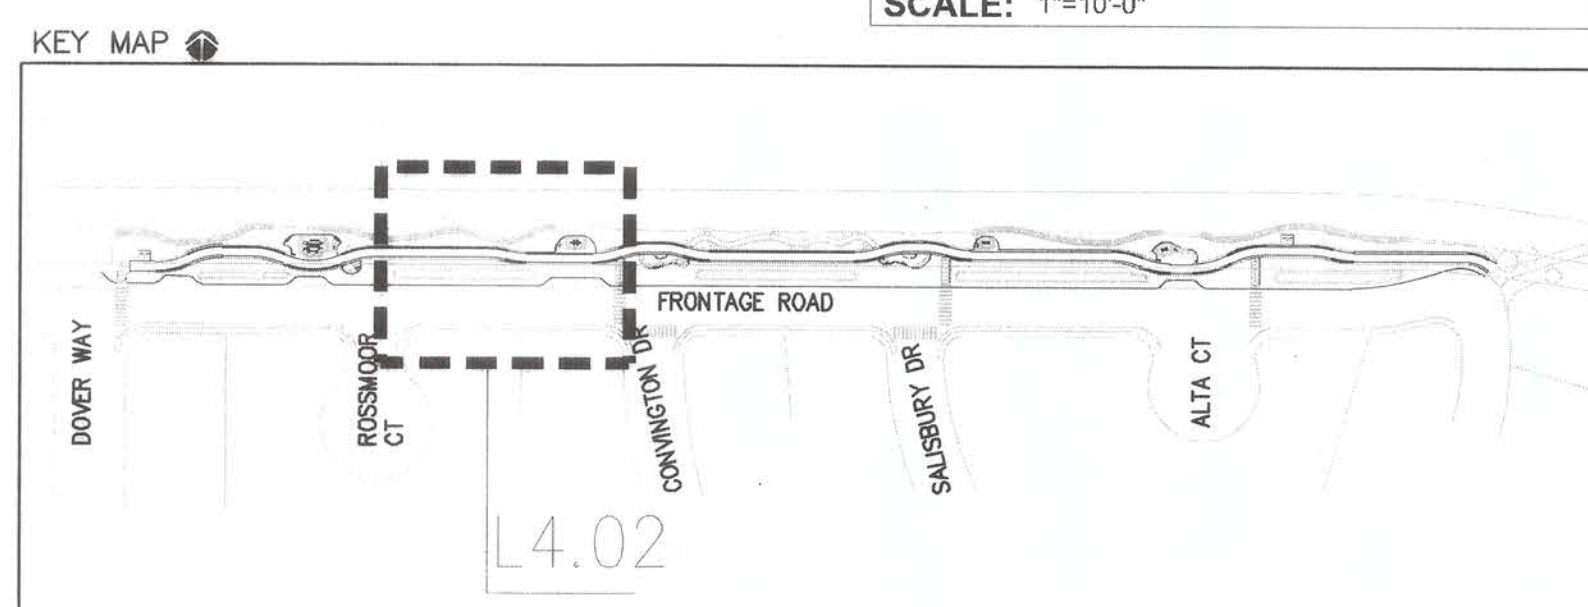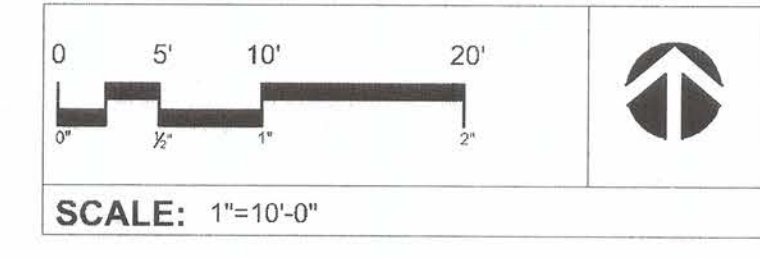

MATCHLINE - SEE SHEET L4.02




MATCHLINE - SEE SHEET L4.04

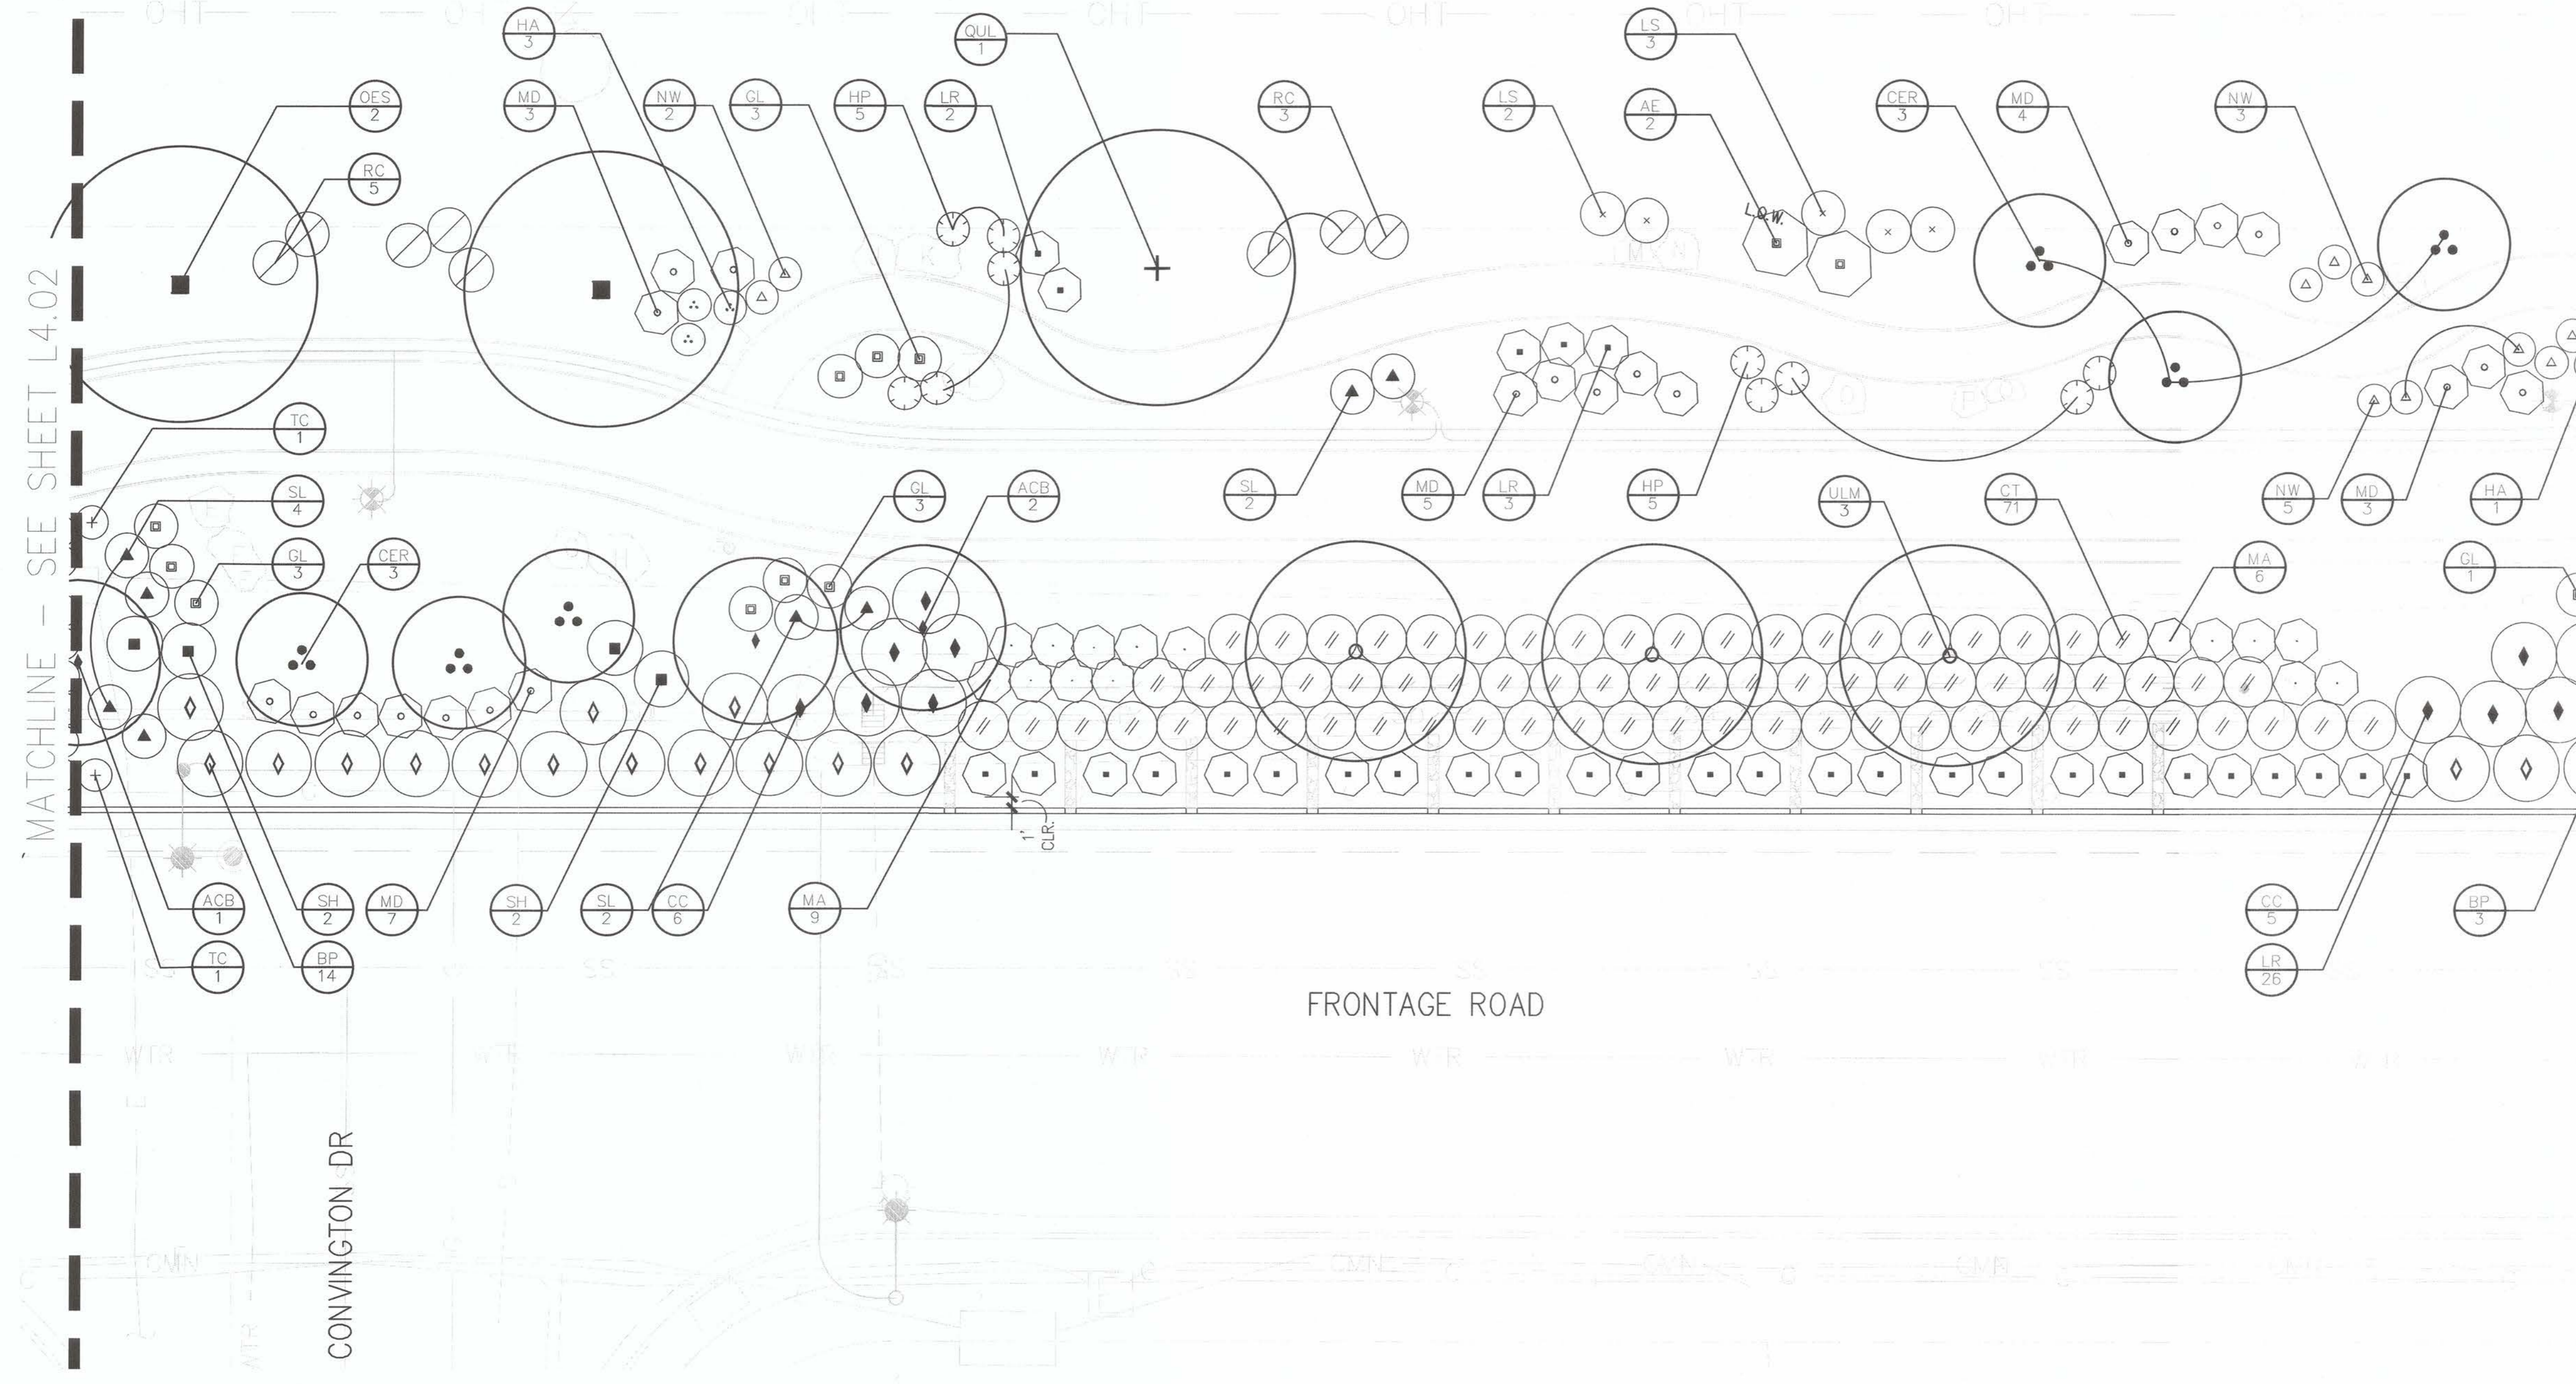

PLANTING SCHEDULE

TREES	BOTANICAL NAME	COMMON NAME	SIZE	WATER USE	SPACING	QTY
ACB	ACER BUERGERIANUM	TRIDENT MAPLE	24"BOX	L	AS SHOWN	10
CER	CERCIS OCCIDENTALIS	WESTERN REDBUD	24"BOX	VL	AS SHOWN	23
OES	OLEA EUROPAEA 'SWAN HILL'	SWAN HILL FRUITLESS OLIVE	24"BOX	VL	AS SHOWN	4
PIC	PISTACIA CHINENSIS	CHINESE PISTACHE	24"BOX	L	AS SHOWN	5
QUL	QUERCUS LOBATA	VALLEY OAK	24"BOX	VL	AS SHOWN	7
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CC	CORREA X 'CARMINE BELLS'	CARMINE BELLS AUSTRALIAN FUCHSIA	1 GAL	L	72" o.c.	46
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GL	GREVILLEA LANIGERA 'COASTAL GEM'	COASTAL GEM GREVILLEA	1 GAL	L	48" o.c.	27
HA	HELENIUM AUTUMNALE	SNEEZEWEEED	1 GAL	M	36" o.c.	27
HP	HESPERALOE PARVIFLORA 'PERPA'	BRAKELIGHTS®RED YUCCA	5 GAL	L	36" o.c.	10
LR	LANTANA CAMARA 'LANZ0001'	BANDANA®ROSE IMPROVED LANTANA	1 GAL	L	48" o.c.	149
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MA	MIMULUS AURANTIACUS	BUSH MONKEYFLOWER	1 GAL	L	48" o.c.	69
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SH	SALVIA MICROPHYLLA 'HOT LIPS'	HOT LIPS GRAHAM SAGE	5 GAL	L	60" o.c.	15
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WM	WESTRINGIA FRUTICOSA 'MORNING LIGHT'	MORNING LIGHT COAST ROSEMARY	1 GAL	L	60" o.c.	11

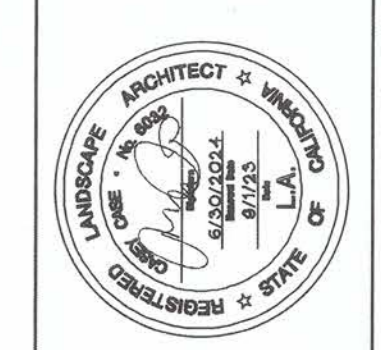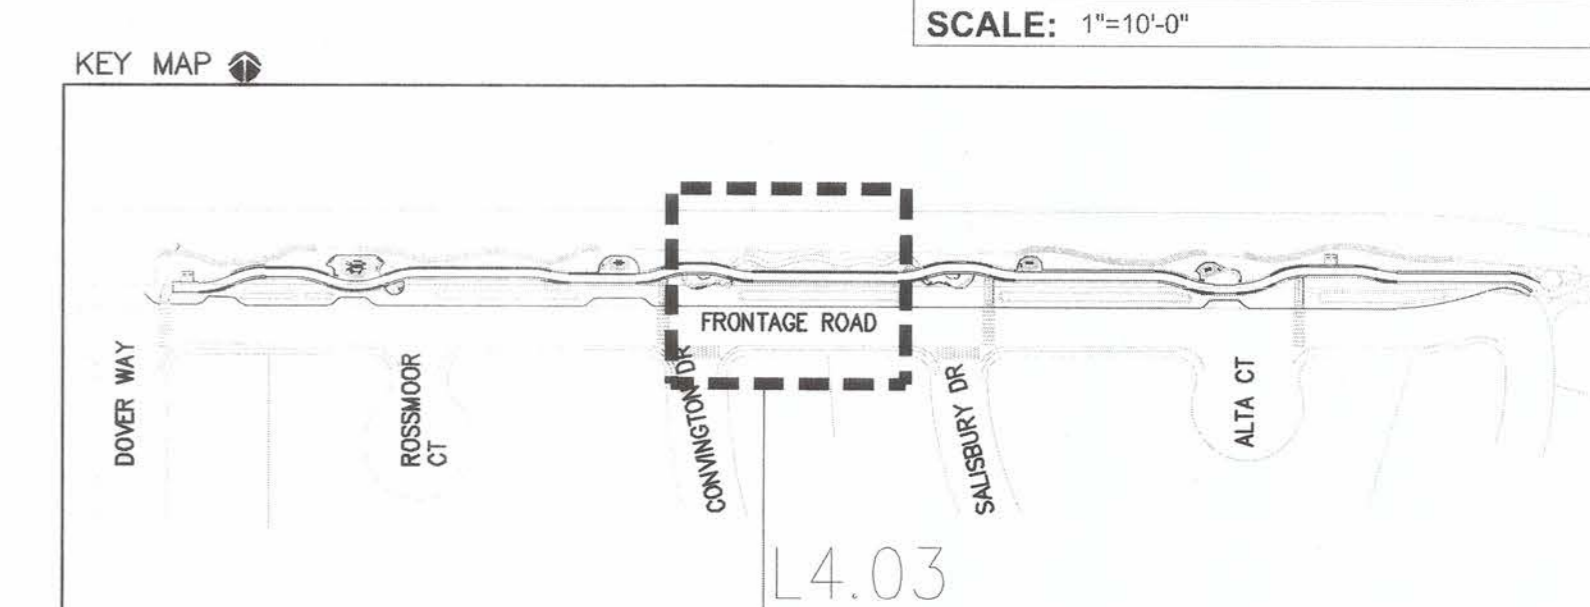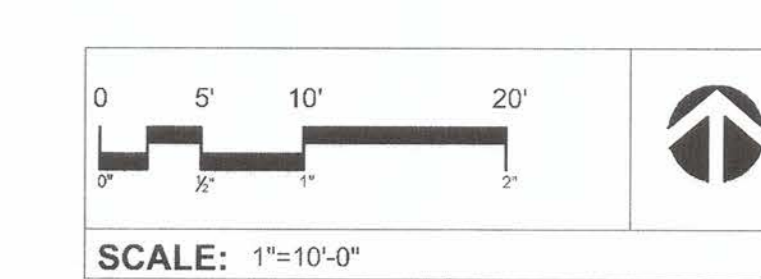

GATES + ASSOCIATES
LANDSCAPE ARCHITECTURE
LAND PLANNING • URBAN DESIGN
13717
7 757 733 1712 www.gatesca.com

ACCEPTED FOR USE:
JOHN SAMUELSON
City Engineer
Date: 7/28/23



FRONTAGE ROAD LIVING TRAIL PLANTING PLAN

BY: DRAWN: TZ	CHECKED: KC	REVIEWED: KC, TZ	DATE: 09/05/23	SCALE: AS SHOWN
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REV	DESCRIPTION

SHEET NO.
51 OF 59
DWG. NO.
L4.03



GATES + ASSOCIATES
 LANDSCAPE ARCHITECTURE
 LAND PLANNING • URBAN DESIGN
 1835 MARKET STREET, SUITE 200, ST. LOUIS, MO 63103
 T 314.776.8174 www.gatesla.com

ACCEPTED FOR USE:

 JOHN SAMUELSON
 City Engineer
 Date: 9/24/23




FRONTAGE ROAD LIVING TRAIL
 PLANTING PLAN

DRAWN: TZ
 CHECKED: KC
 REVIEWED: KC, TZ
 DATE: 09/05/23
 SCALE: AS SHOWN

DATE	REV	DESCRIPTION



SHEET NO.
52 OF 59
 DWG. NO.
L4.04

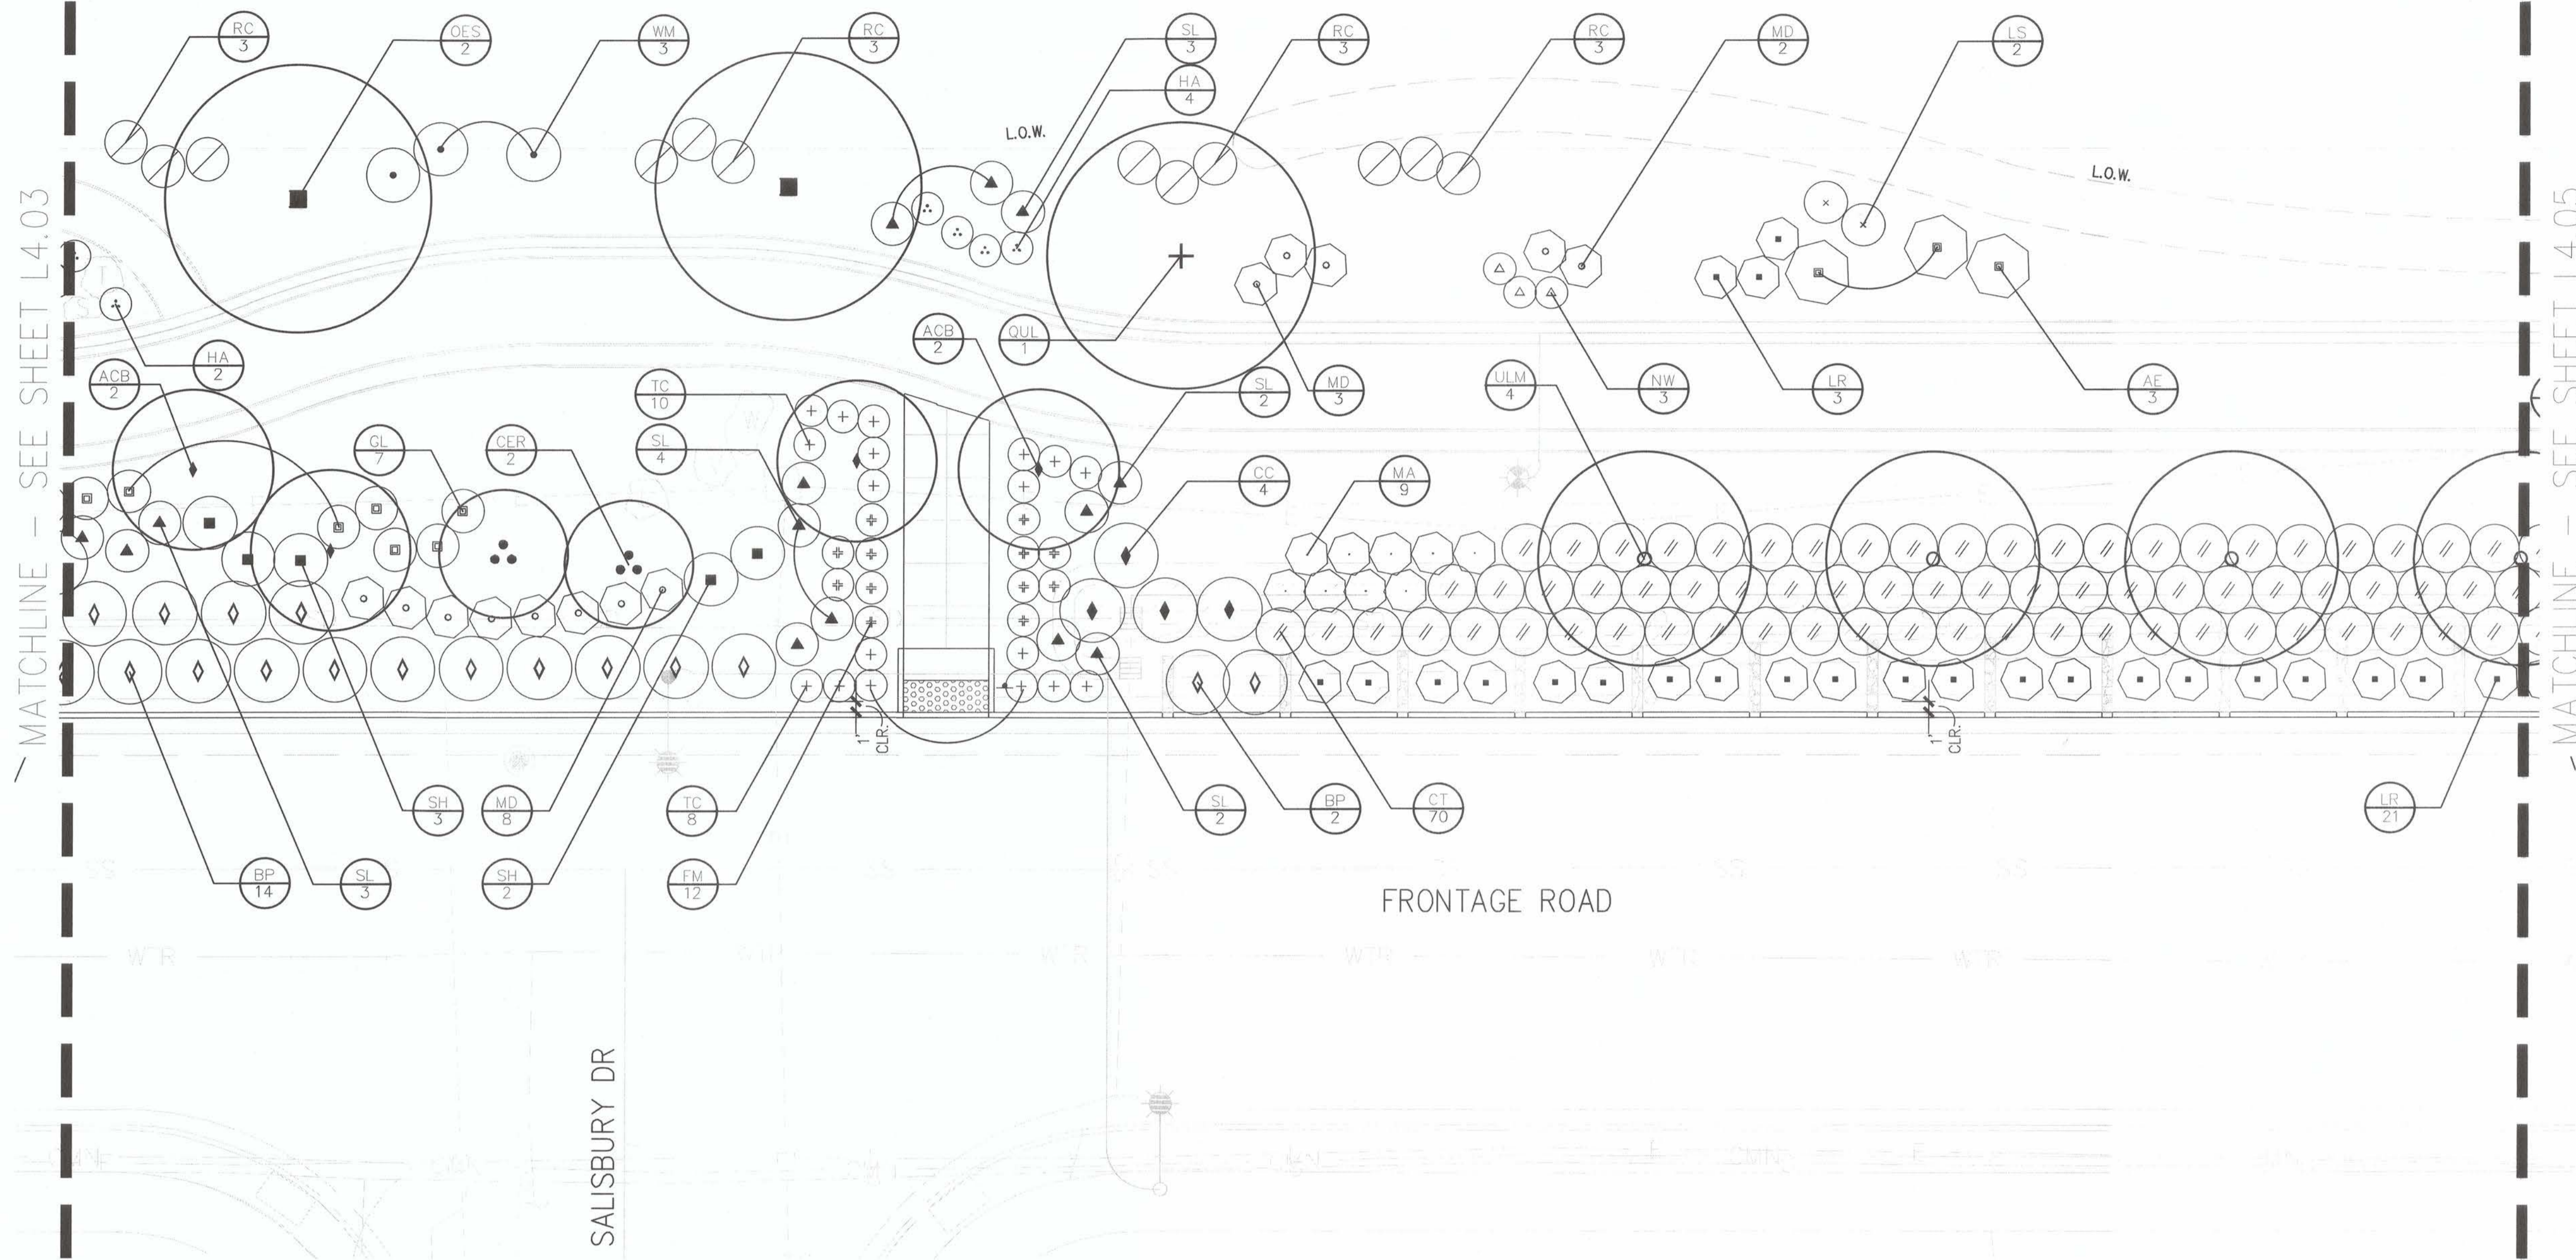


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GATES + ASSOCIATES
 LANDSCAPE ARCHITECTURE
 LAND PLANNING - URBAN DESIGN
 17217 75th ST, STE 100, SAN DIEGO, CA 92128
 WWW.GATESLA.COM

ACCEPTED FOR USE:

 JOHN SAMUELSON
 City Engineer
 Date: 9/26/23

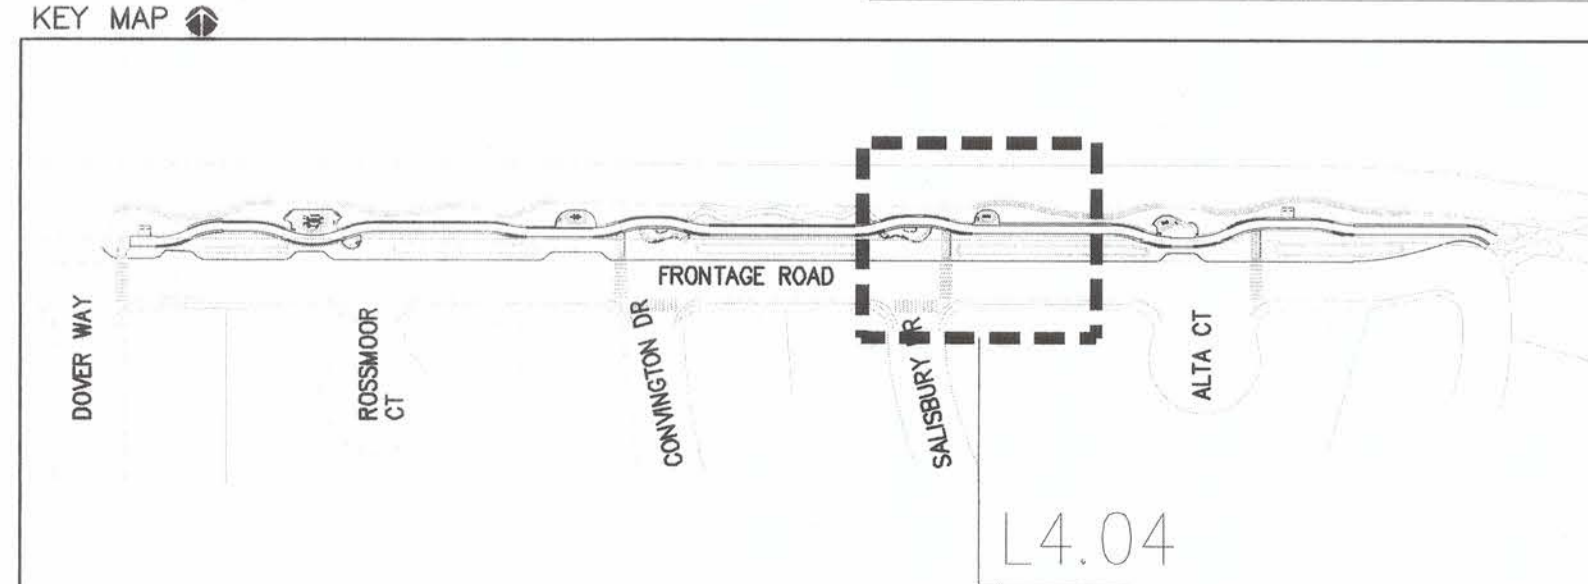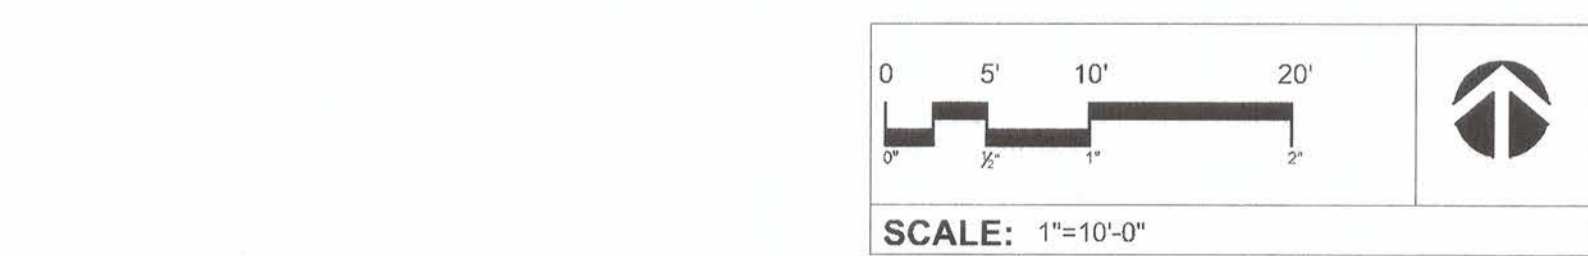


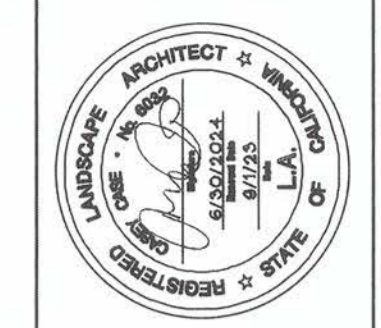**FRONTAGE ROAD
 LIVING TRAIL**
 PLANTING PLAN

DRAWN: TZ
 CHECKED: KC
 REVIEWED: KC, TZ
 DATE: 09/05/23
 SCALE: AS SHOWN

DATE	REV	DESCRIPTION



SHEET NO.
53 OF 59
 DWG. NO.
L4.05

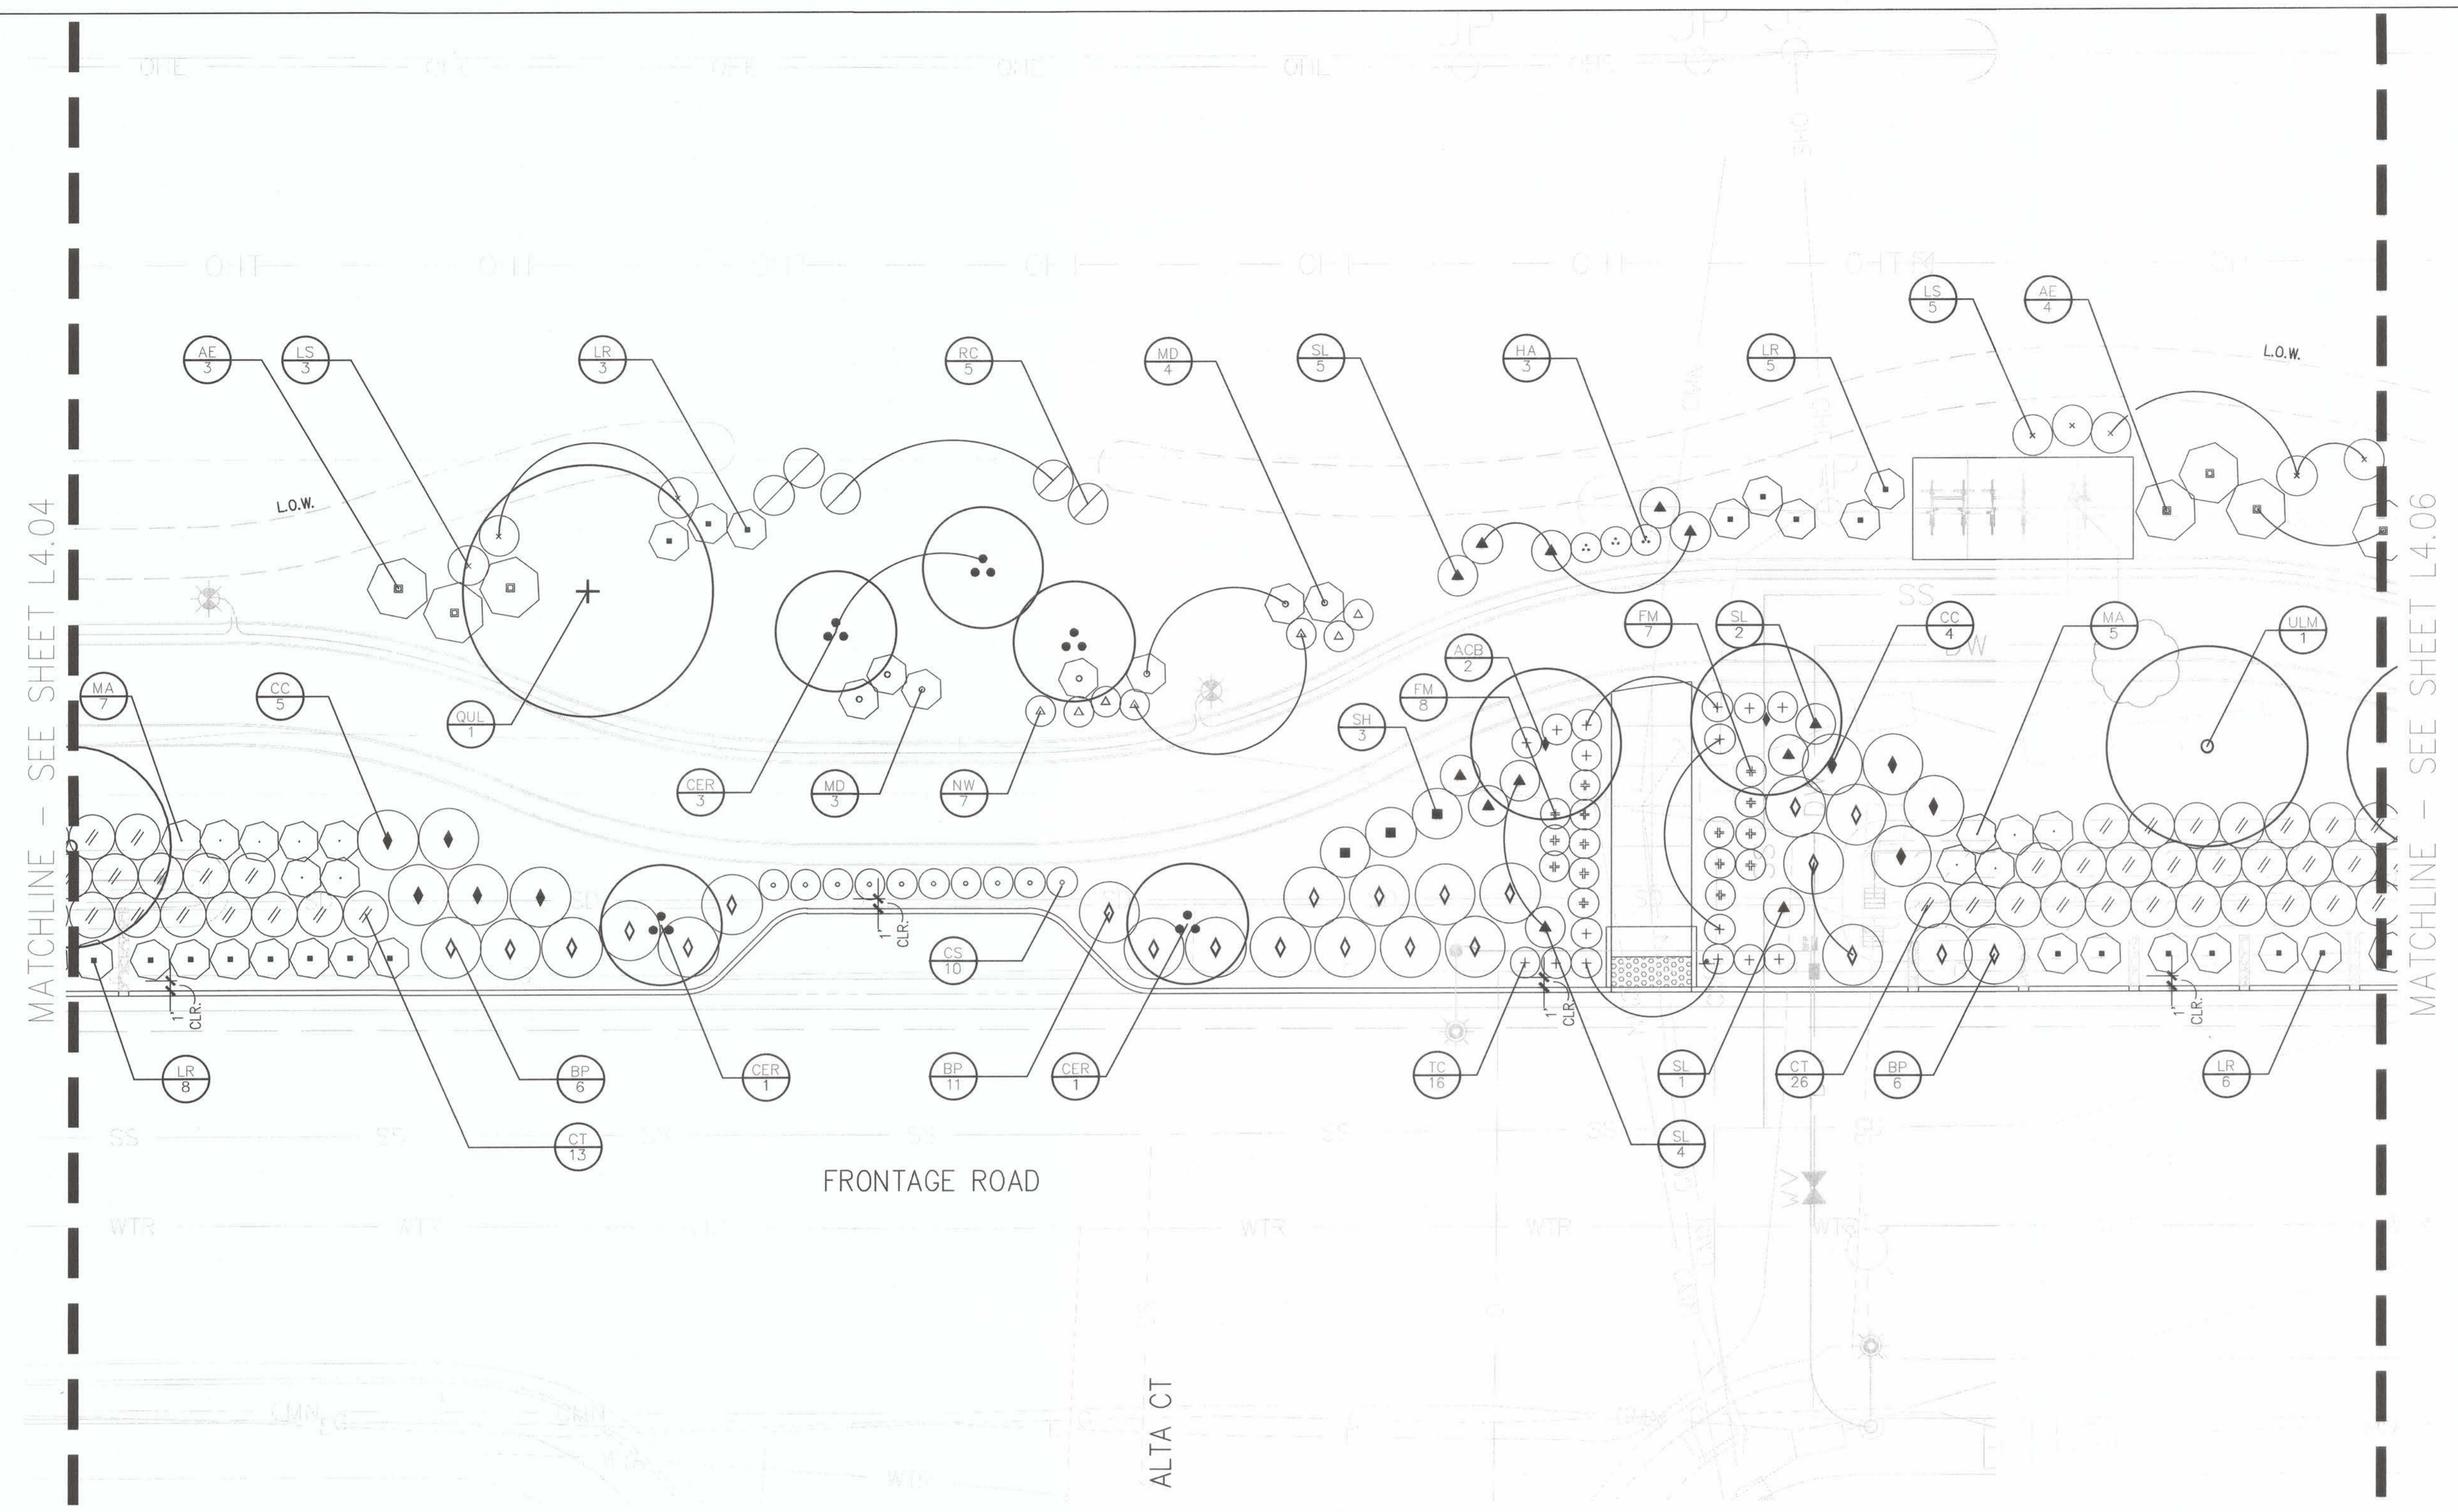

PLANTING SCHEDULE


TREES	BOTANICAL NAME	COMMON NAME	SIZE	WATER USE	SPACING	QTY
ACB	ACER BUERGERIANUM	TRIDENT MAPLE	24"BOX	L	AS SHOWN	10
CER	CERCIS OCCIDENTALIS	WESTERN REDBUD	24"BOX	VL	AS SHOWN	23
OES	OLEA EUROPAEA 'SWAN HILL'	SWAN HILL FRUITLESS OLIVE	24"BOX	VL	AS SHOWN	4
PIC	PISTACIA CHINENSIS	CHINESE PISTACHE	24"BOX	L	AS SHOWN	5
QUL	QUERCUS LOBATA	VALLEY OAK	24"BOX	VL	AS SHOWN	7
ULM	ULMUS CARPINIFOLIA X PARVIFOLIA 'FRONTIER'	FRONTIER ELM	24"BOX	L	AS SHOWN	16

SHRUBS	BOTANICAL NAME	COMMON NAME	SIZE	WATER USE	SPACING	QTY
AE	ARCTOSTAPHYLOS X 'EMERALD CARPET'	EMERALD CARPET MANZANITA	1 GAL	L	72" o.c.	21
BP	BACCHARIS PILULARIS 'TWIN PEAKS'	DWARF COYOTE BRUSH	1 GAL	L	72" o.c.	93
CS	CALANDRINIA SPECTABILIS 'SHINING PINK'	SHINING PINK CALANDRINIA	1 GAL	L	36" o.c.	34
CT	CHONDRPETALUM TECTORUM 'EL CAMPO'	SMALL CAPE RUSH	5 GAL	L	54" o.c.	299
CC	CORREA X 'CARMINE BELLS'	CARMINE BELLS AUSTRALIAN FUCHSIA	1 GAL	L	72" o.c.	46
FM	FESTUCA MAIREI	ATLAS FESCUE	1 GAL	L	36" o.c.	61
GL	GREVILLEA LANIGERA 'COASTAL GEM'	COASTAL GEM GREVILLEA	1 GAL	L	48" o.c.	27
HA	HELIENIUM AUTUMNALE	SNEEZEWEED	1 GAL	M	36" o.c.	27
HP	HESPERALOE PARVIFLORA 'PERPA'	BRAKELIGHTS® RED YUCCA	5 GAL	L	36" o.c.	10
LR	LANTANA CAMARA 'LANZ0001'	BANDANA® ROSE IMPROVED LANTANA	1 GAL	L	48" o.c.	149
LS	LEUCADENDRON SALIGNUM 'WINTER RED'	WINTER RED CONEBUSH	5 GAL	L	48" o.c.	25
MA	MIMULUS AURANTIACUS	BUSH MONKEYFLOWER	1 GAL	L	48" o.c.	69
MD	MUHLENBERGIA DUBIA	PINE MUHLY	1 GAL	L	48" o.c.	59
NW	NEPETA X 'WALKER'S LOW'	WALKER'S LOW CATMINT	1 GAL	L	36" o.c.	31
RC	RHAMNUS CALIFORNICA 'MOUND SAN BRUNO'	MOUND SAN BRUNO COFFEEBERRY	1 GAL	L	48" o.c.	39
SL	SALVIA LEUCANTHA 'SANTA BARBARA'	MEXICAN BUSH SAGE	5 GAL	L	48" o.c.	66
SH	SALVIA MICROPHYLLA 'HOT LIPS'	HOT LIPS GRAHAM SAGE	5 GAL	L	60" o.c.	15
TC	TEUCRIUM CHAMAEDRYS	GERMANDER	1 GAL	L	36" o.c.	65
WM	WESTRINGIA FRUTICOSA 'MORNING LIGHT'	MORNING LIGHT COAST ROSEMARY	1 GAL	L	60" o.c.	11

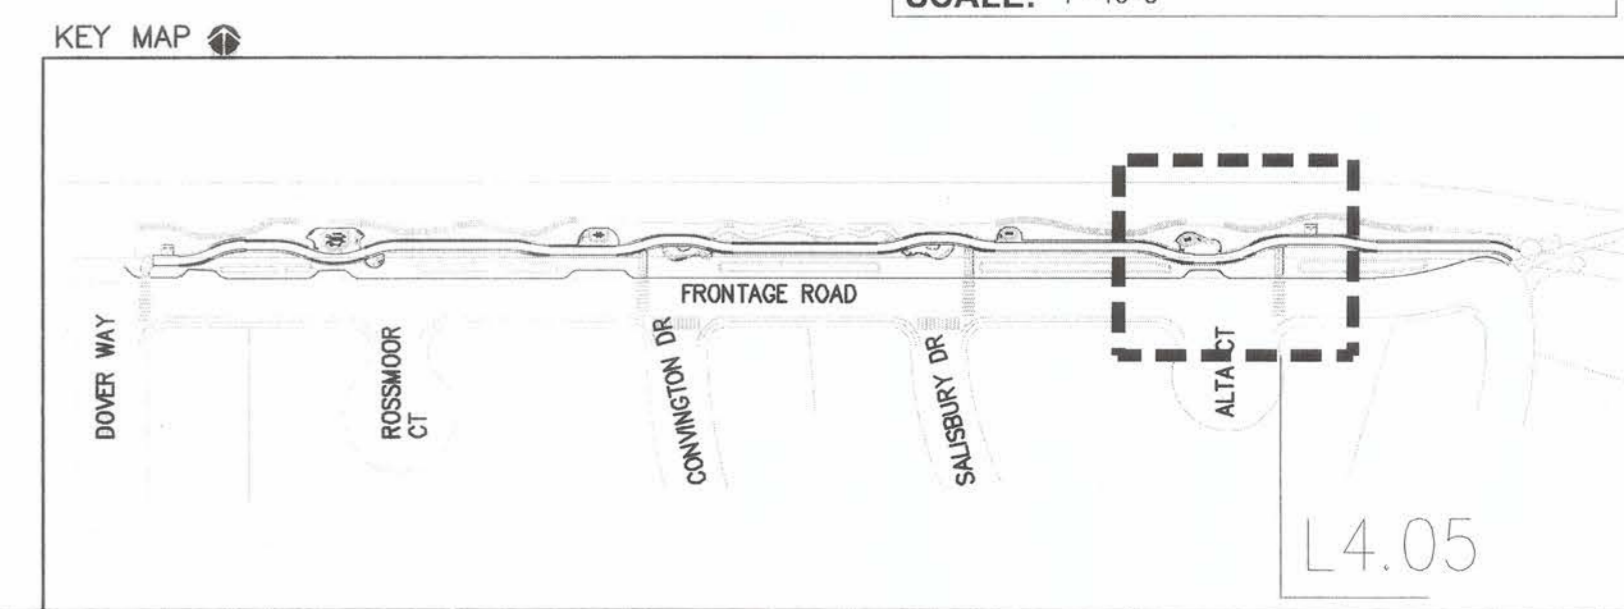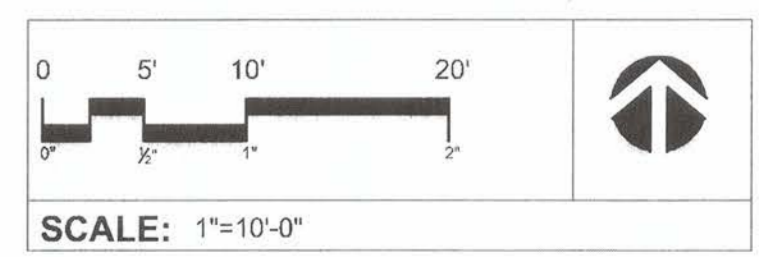



GATES + ASSOCIATES
 LANDSCAPE ARCHITECTURE
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 19317, 19318, 19319
 www.gatesla.com

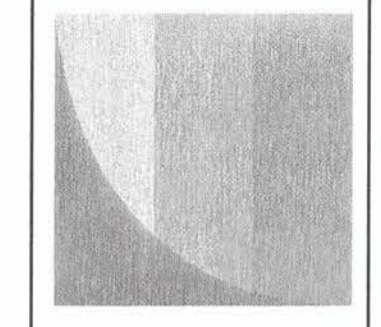

ACCEPTED FOR USE:
 JOHN SAMUELSON
 City Engineer
 Date: 9/26/23


City of Pittsburg

**FRONTAGE ROAD
 LIVING TRAIL**
 PLANTING PLAN

DRAWN: TZ
 CHECKED: KC
 REVIEWED: KC, TZ
 DATE: 09/05/23
 SCALE: AS SHOWN

DATE	REV	DESCRIPTION



SHEET NO.
54 OF 59
 DWG. NO.
L4.06

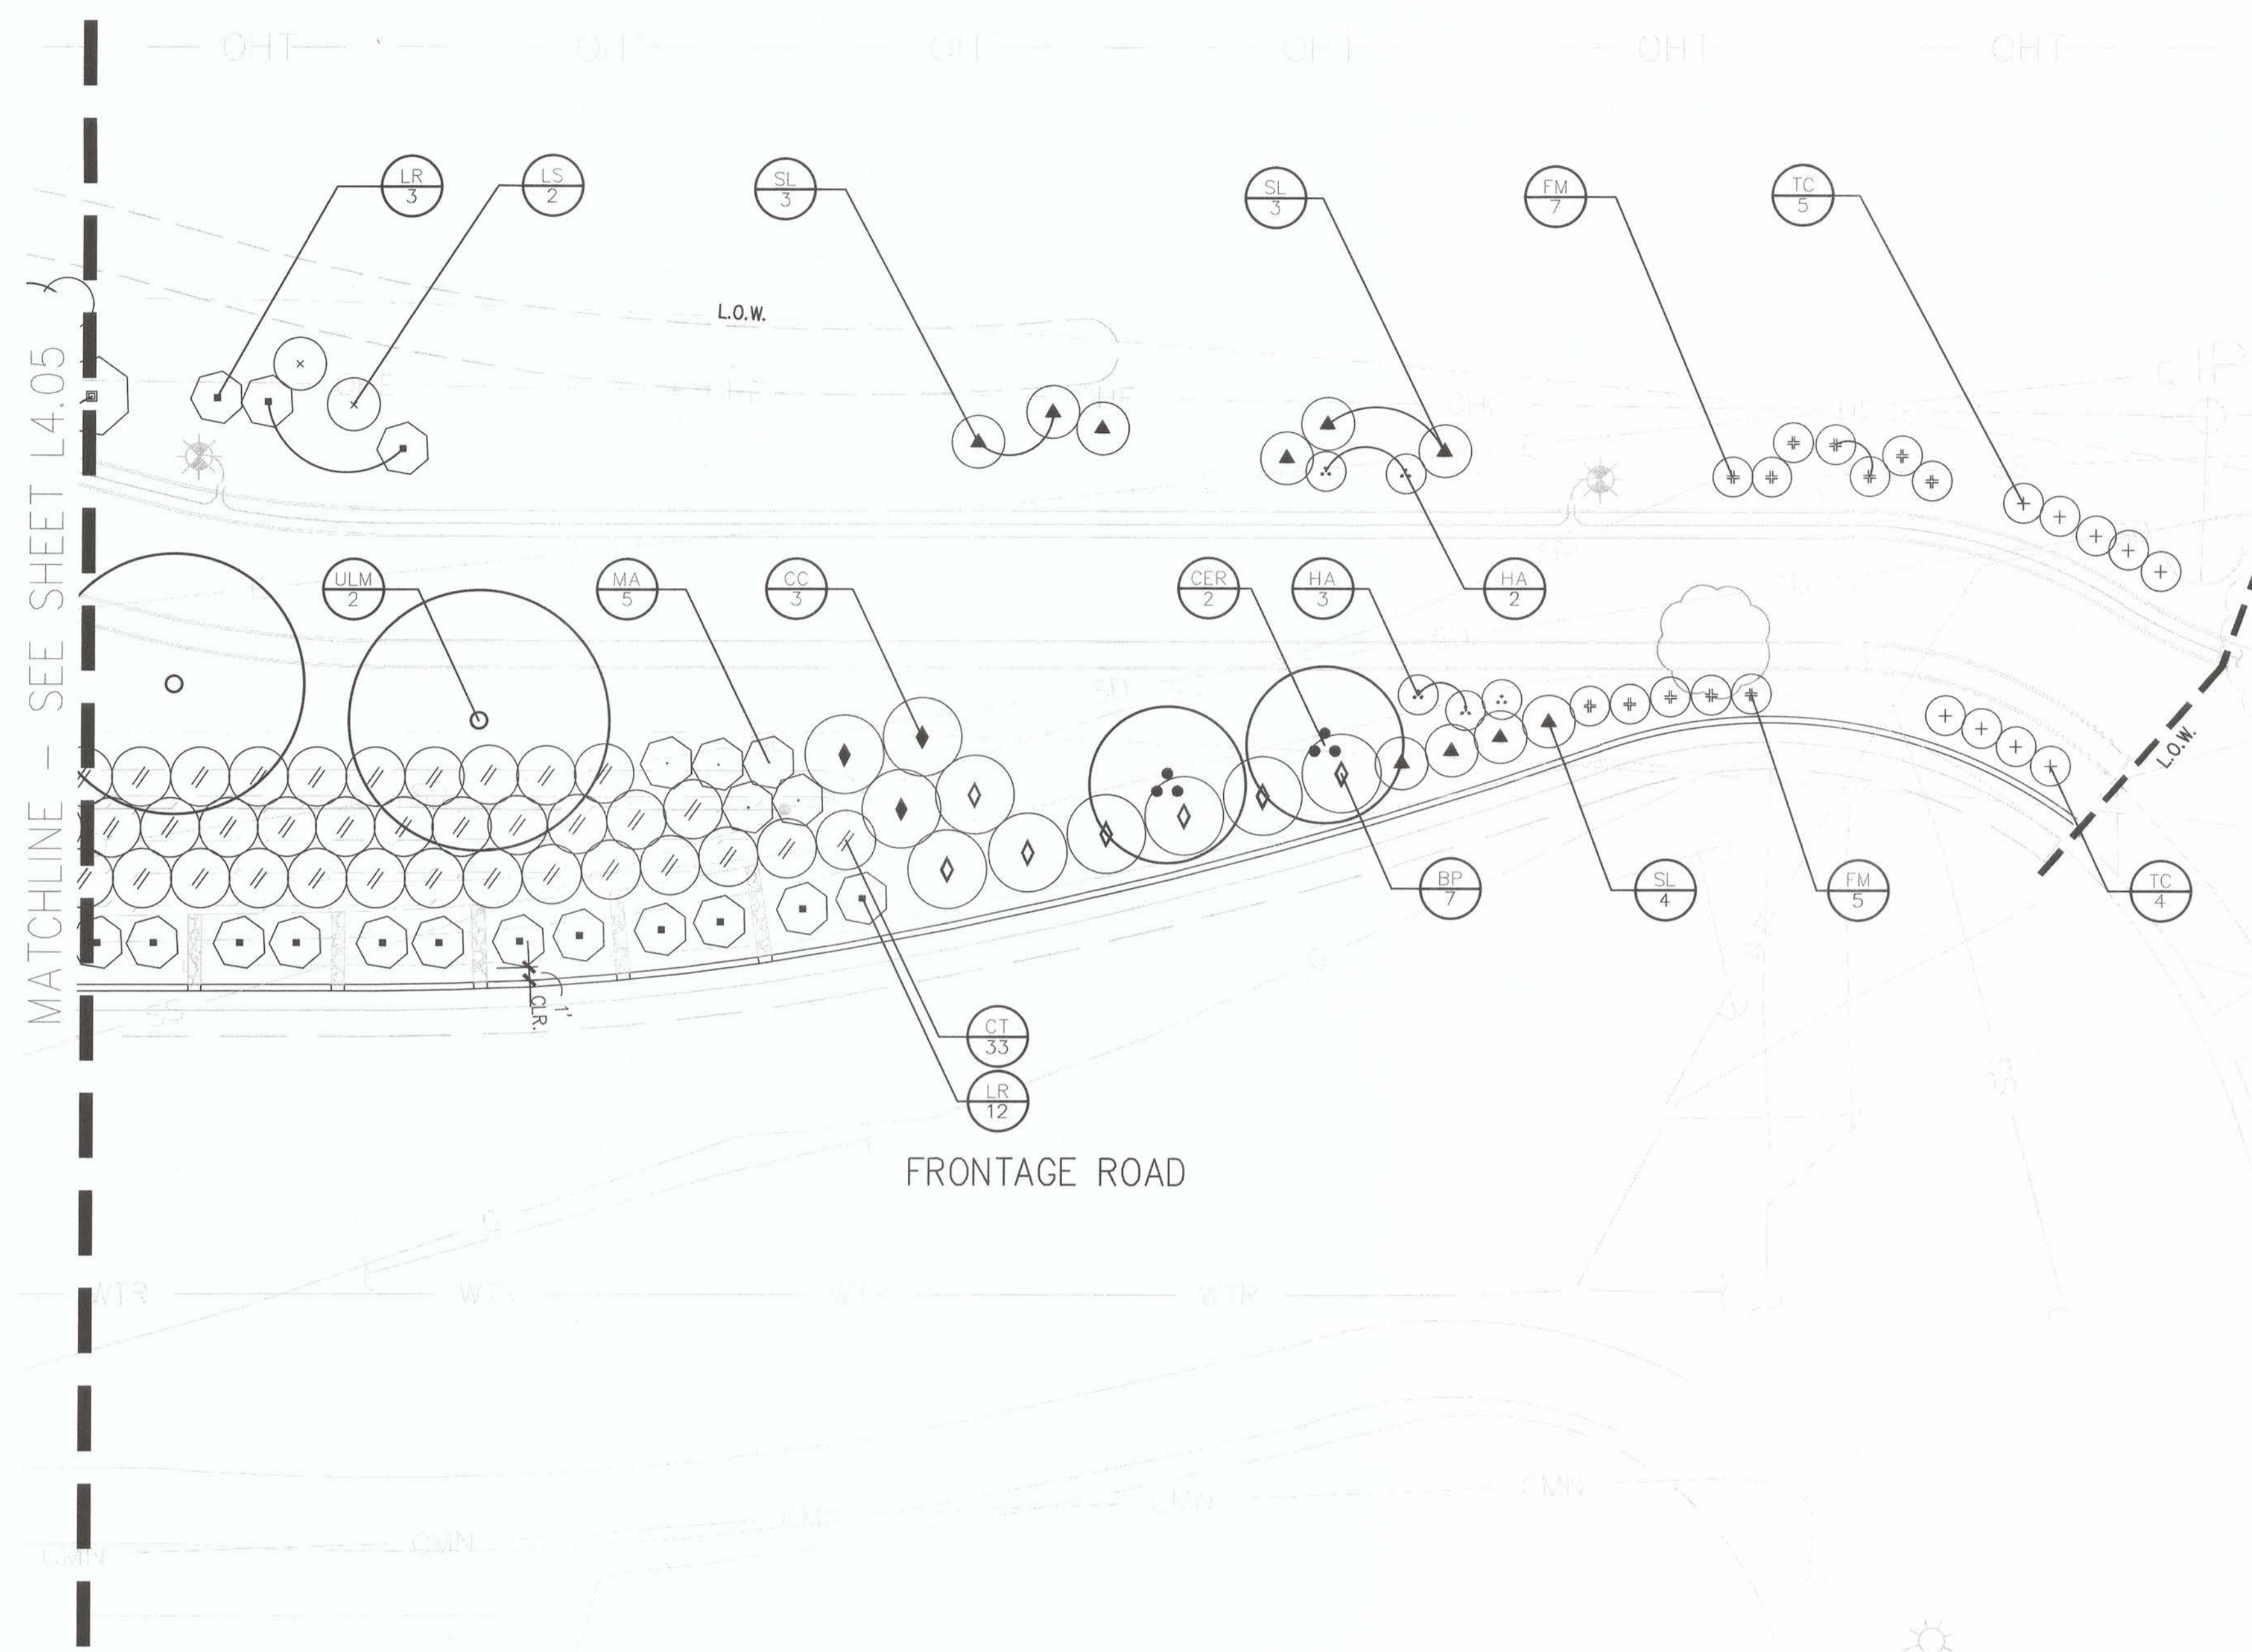


PLANTING SCHEDULE

TREES	BOTANICAL NAME	COMMON NAME	SIZE	WATER USE	SPACING	QTY
ACB	ACER BUERGERIANUM	TRIDENT MAPLE	24"BOX	L	AS SHOWN	10
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PIC	PISTACIA CHINENSIS	CHINESE PISTACHE	24"BOX	L	AS SHOWN	5
QL	QUERCUS LOBATA	VALLEY OAK	24"BOX	VL	AS SHOWN	7
ULM	ULMUS CARPINIFOLIA X PARVIFOLIA 'FRONTIER'	FRONTIER ELM	24"BOX	L	AS SHOWN	16


SHRUBS	BOTANICAL NAME	COMMON NAME	SIZE	WATER USE	SPACING	QTY
AE	ARCTOSTAPHYLOS X 'EMERALD CARPET'	EMERALD CARPET MANZANITA	1 GAL	L	72" o.c.	21
BP	BACCHARIS PILULARIS 'TWIN PEAKS'	DWARF COYOTE BRUSH	1 GAL	L	72" o.c.	93
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CT	CHONDROPETALUM TECTORUM 'EL CAMPO'	SMALL CAPE RUSH	5 GAL	L	54" o.c.	299
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TC	TEUCRIUM CHAMAEDRY'S	GERMANDER	1 GAL	L	36" o.c.	65
WM	WESTRINGIA FRUTICOSA 'MORNING LIGHT'	MORNING LIGHT COAST ROSEMARY	1 GAL	L	60" o.c.	11

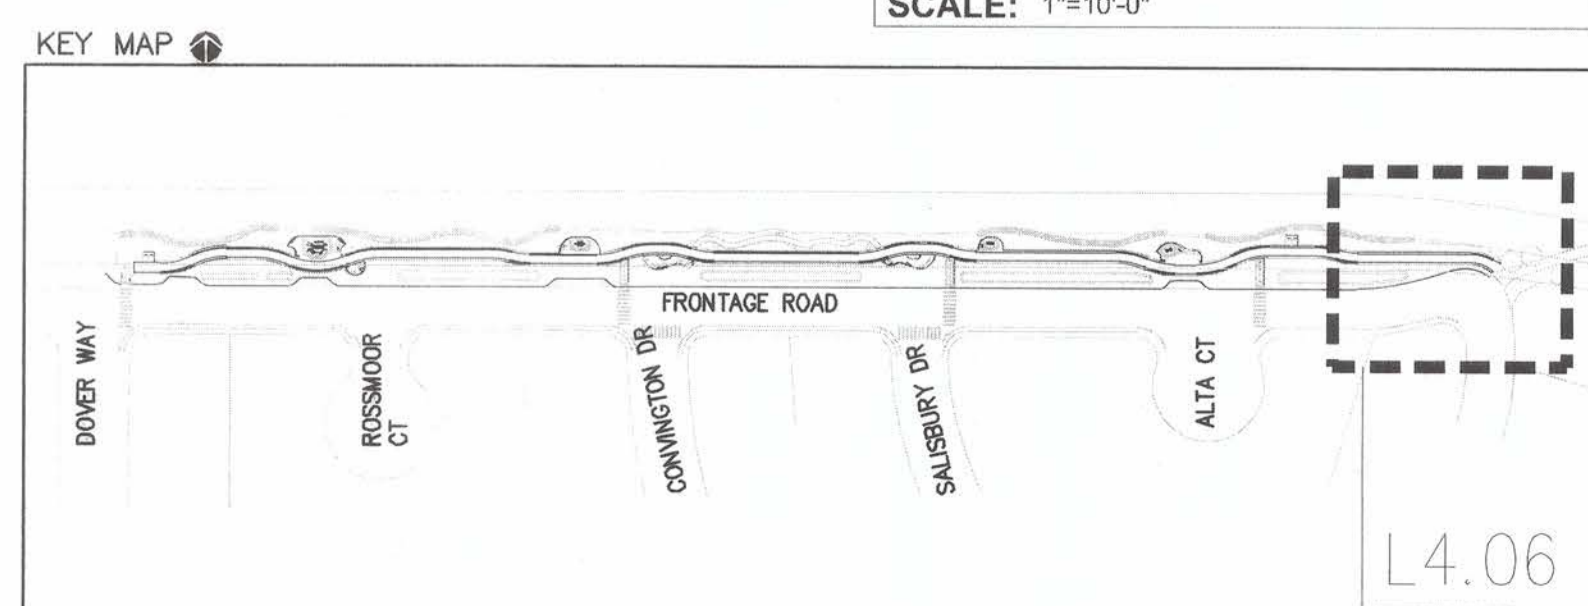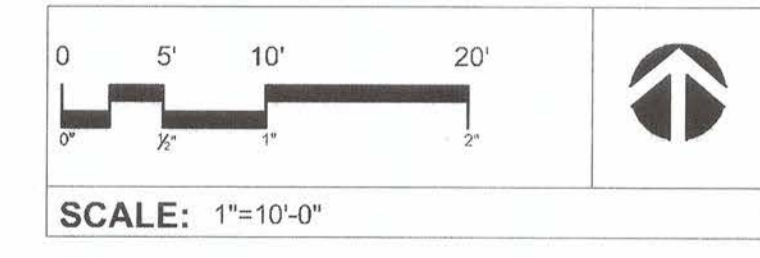


L4.06

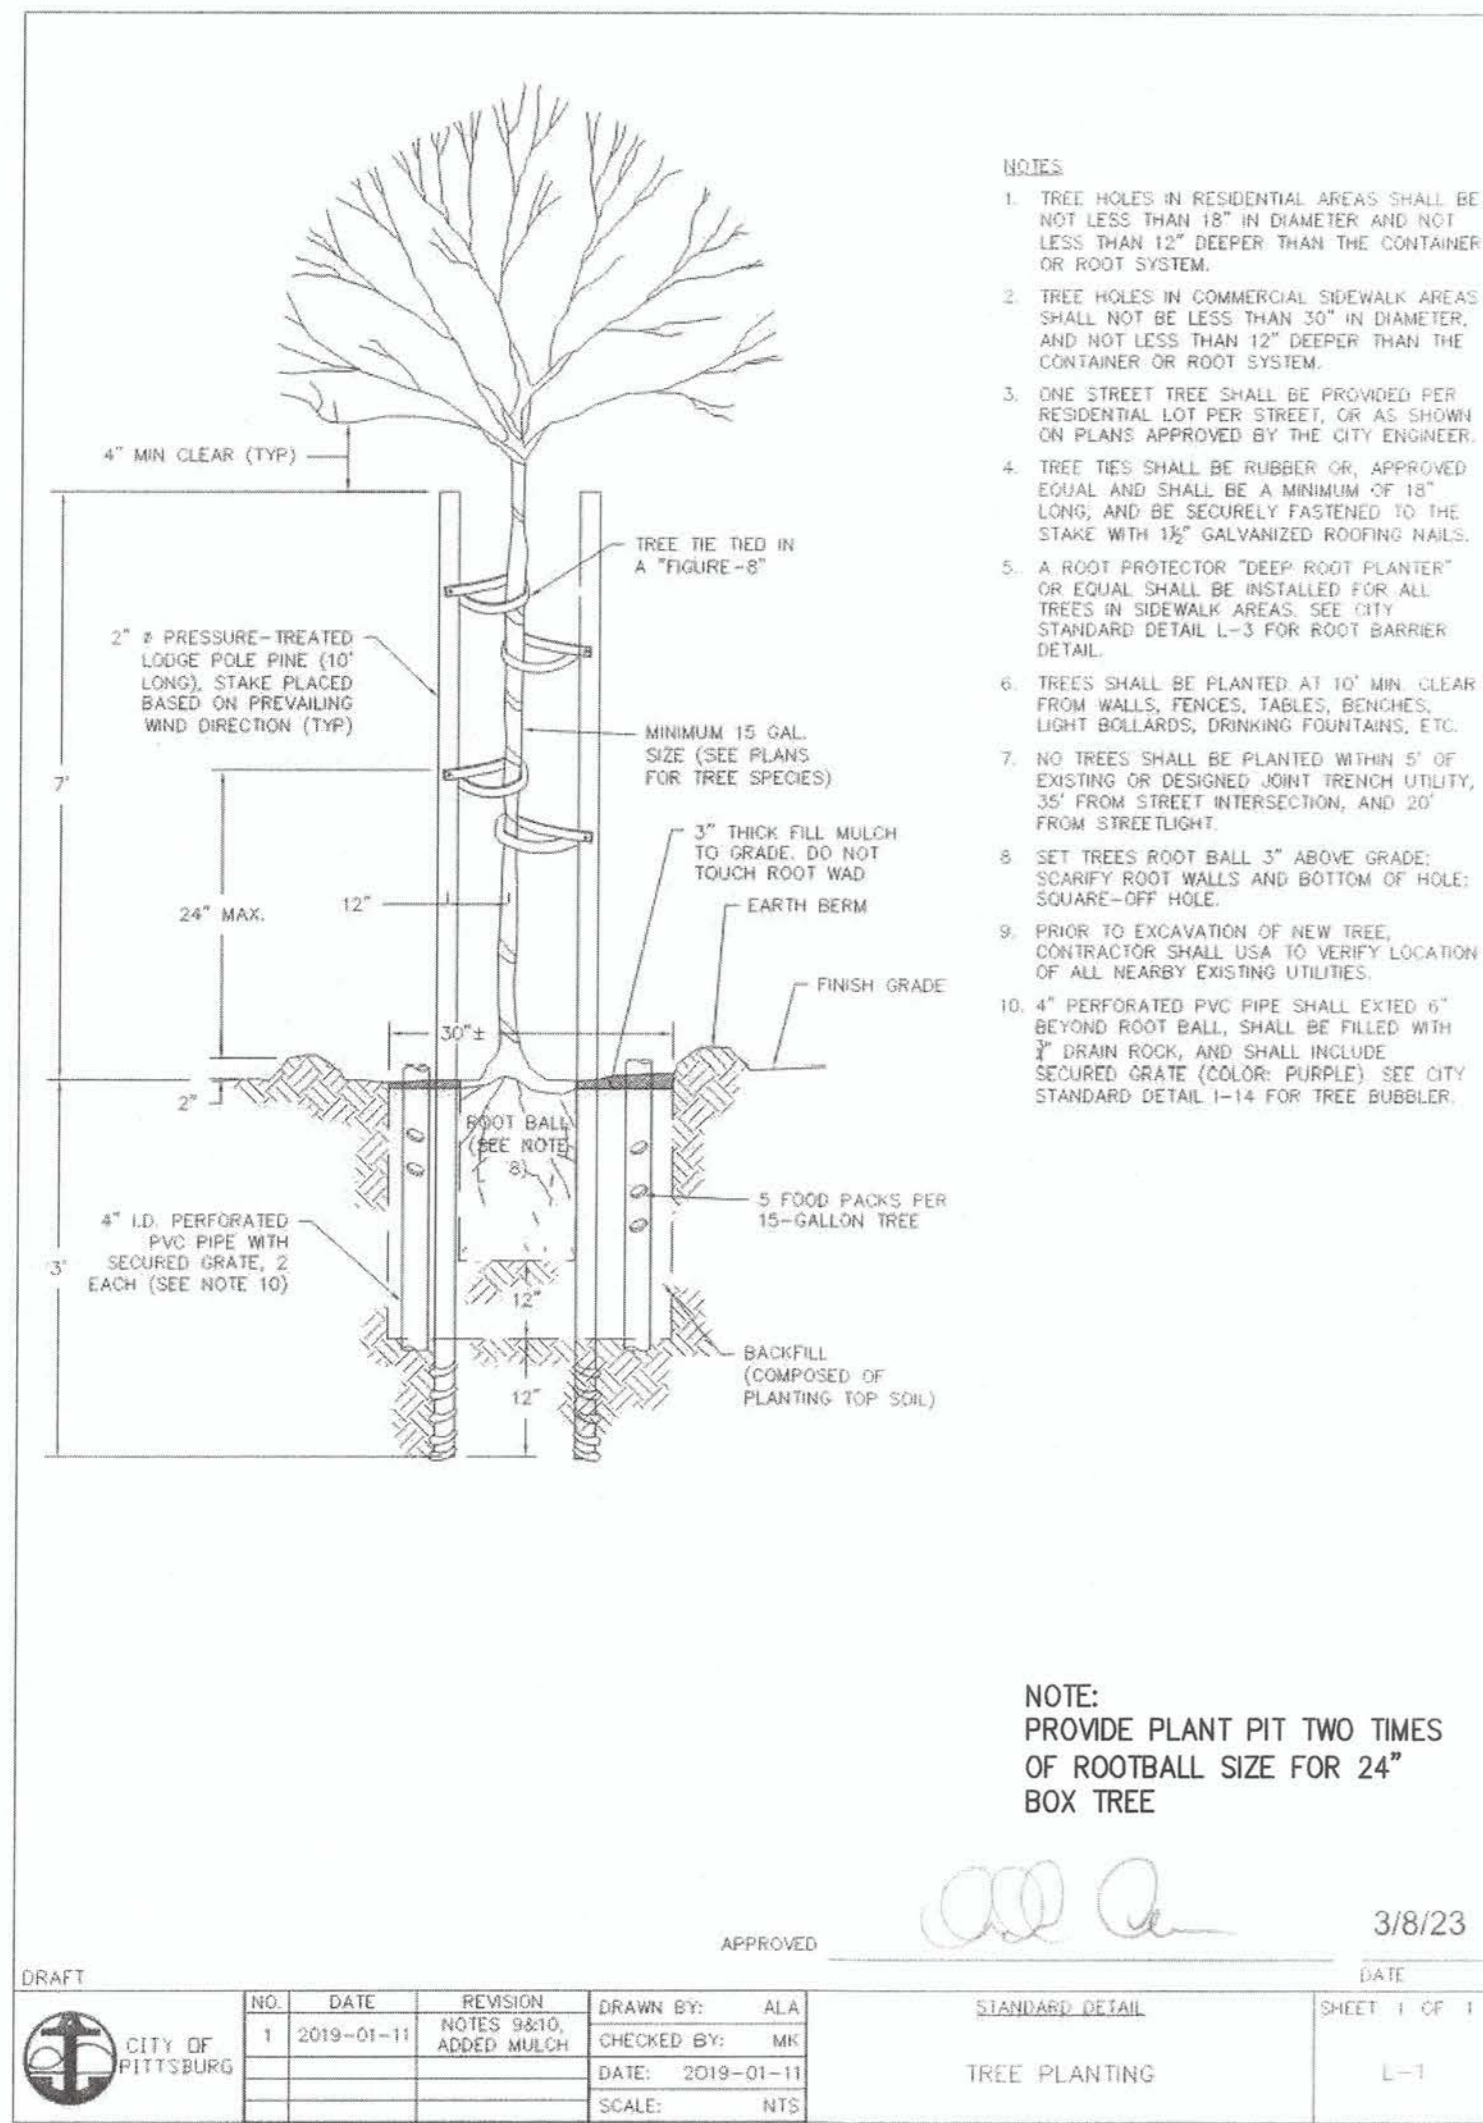

3 TREE PLANTING
SCALE: N.T.S.

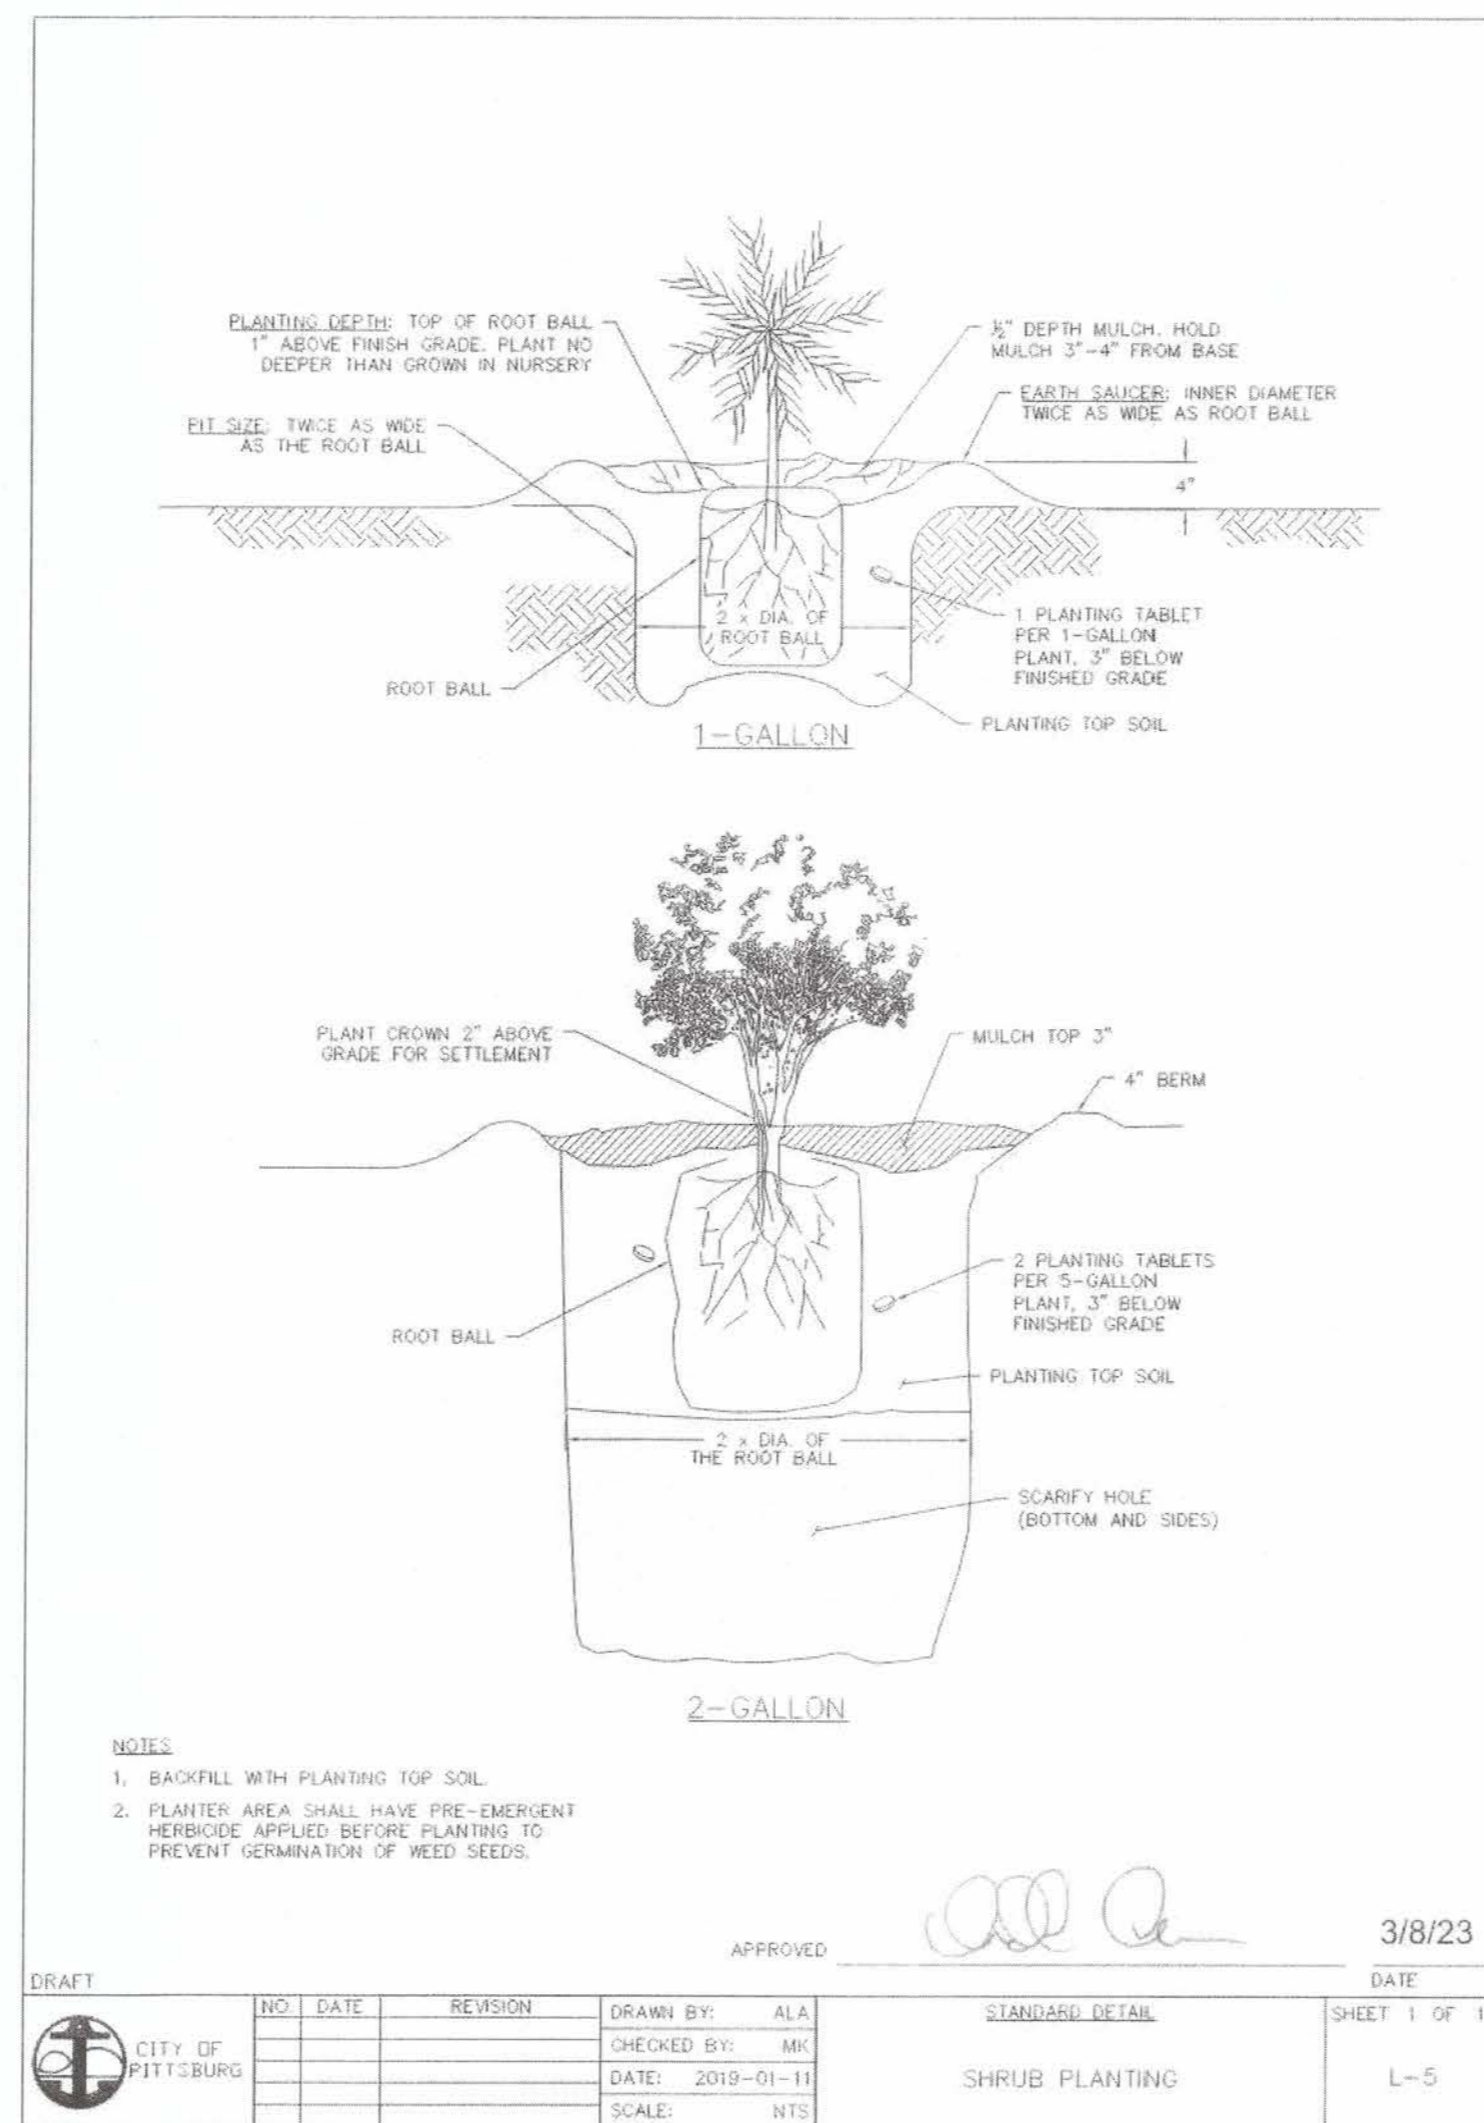

2 SHRUB PLANTING
SCALE: N.T.S.

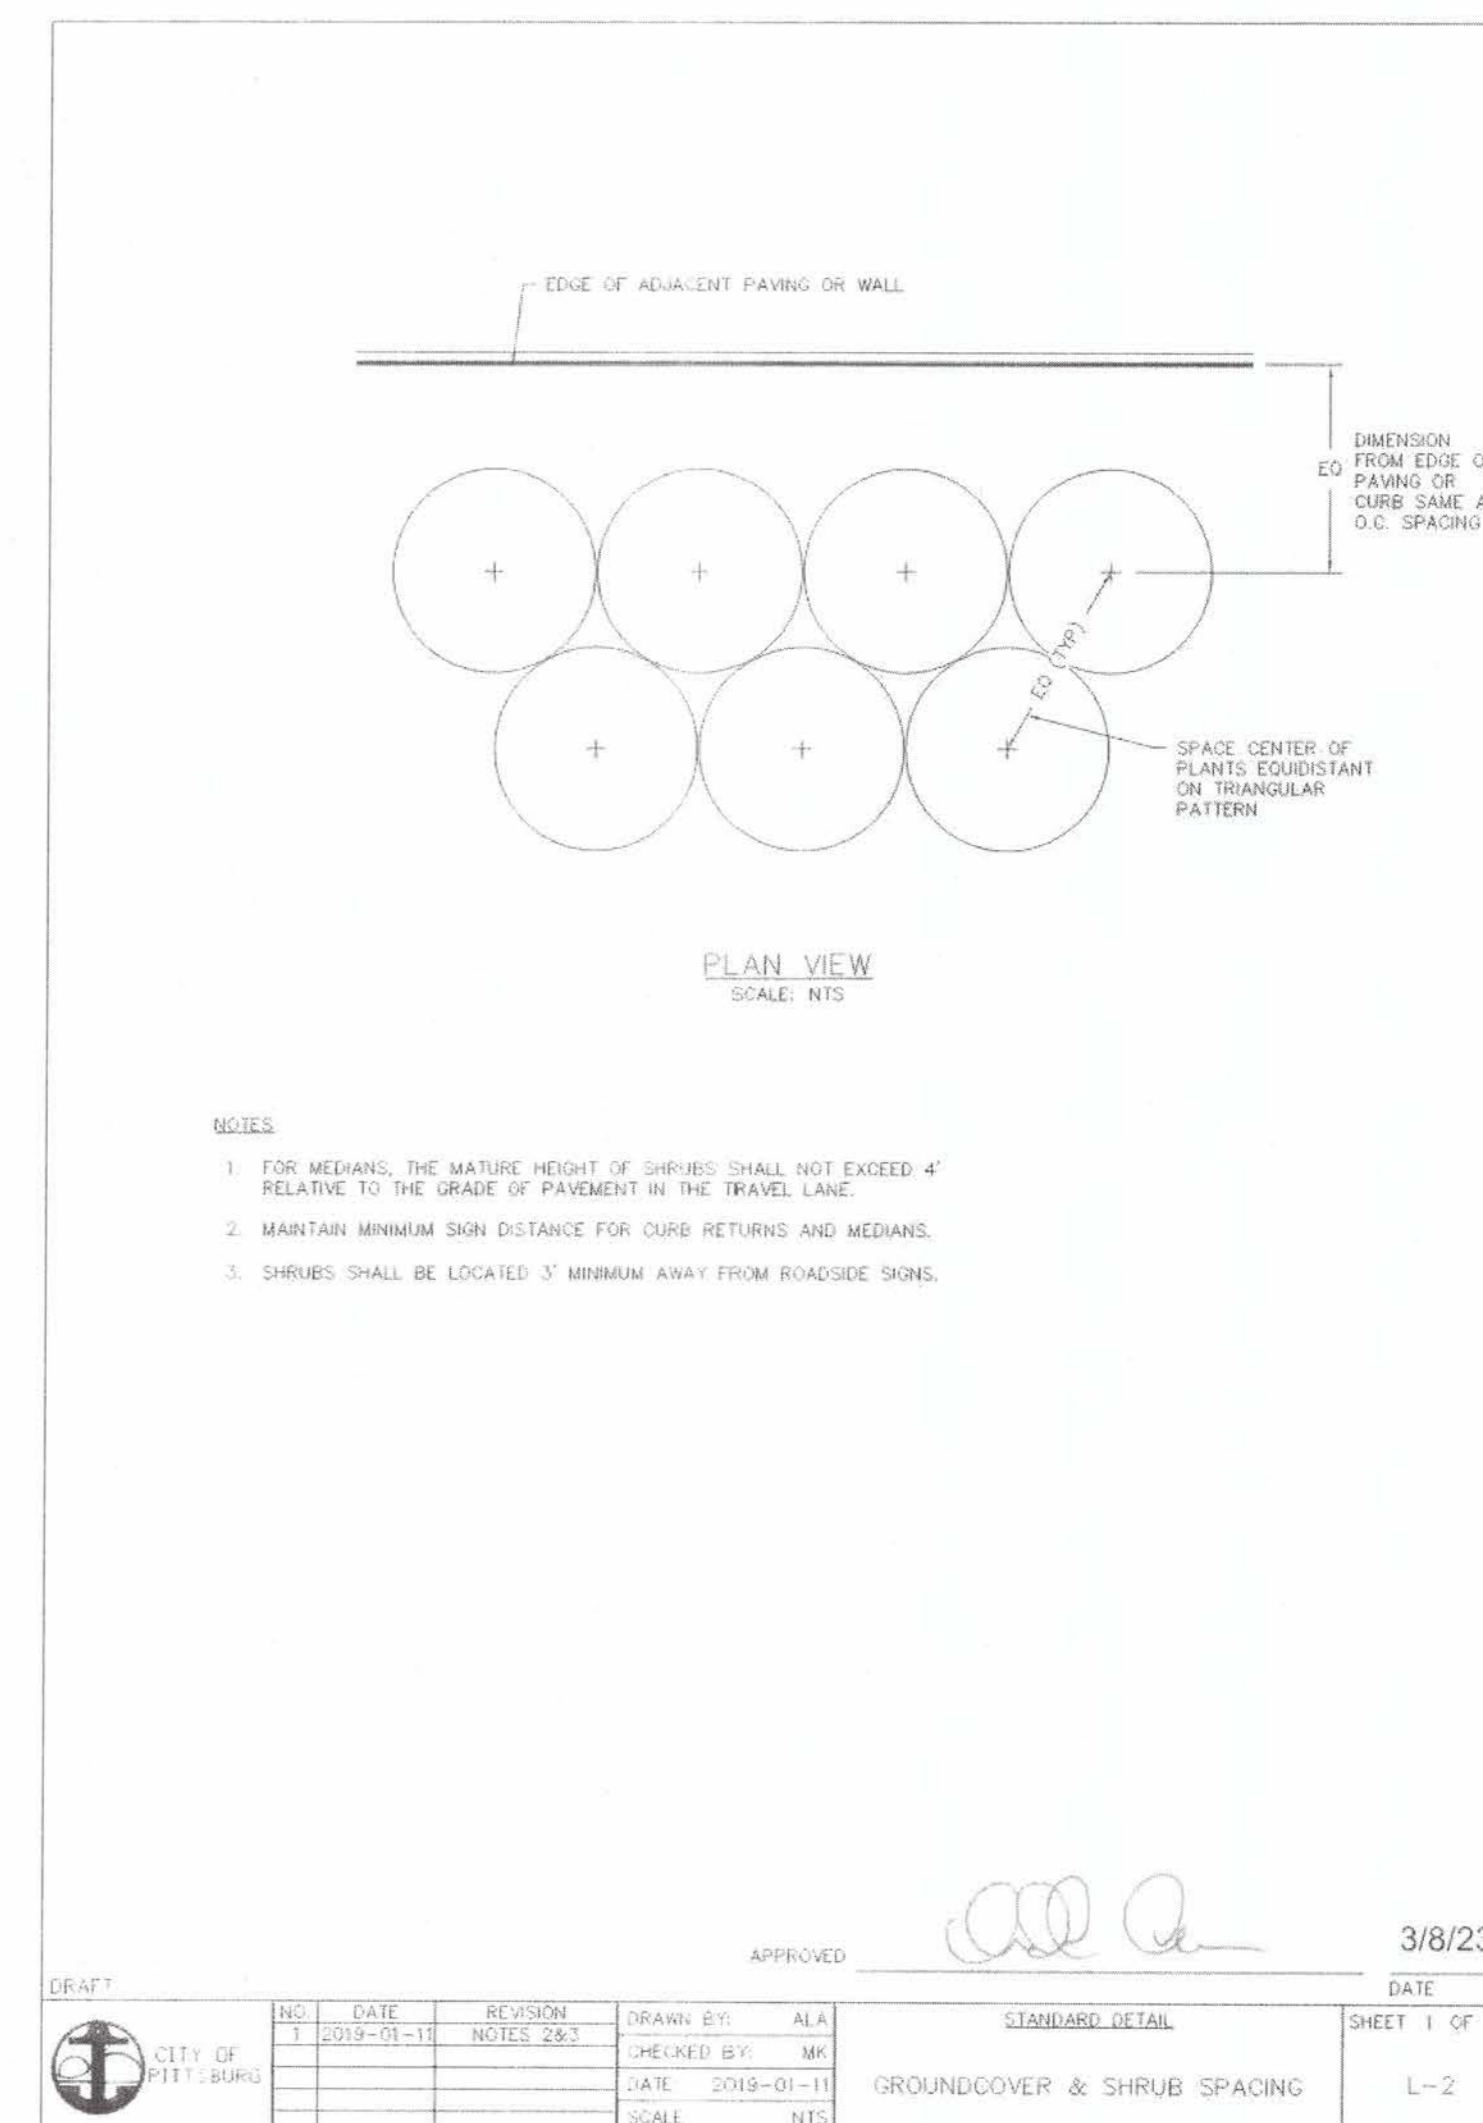

1 PLANT SPACING
SCALE: N.T.S.



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 1831 MARKET STREET, SUITE 200, CLEVELAND, OH 44115
 T: 216.231.8174 WWW.GATESA.COM


ACCEPTED FOR USE:
[Signature]
 JOHN SAMUELSON
 City Engineer
 Date: 9/26/23



FRONTAGE ROAD LIVING TRAIL
 PLANTING DETAILS

DATE	REV	DESCRIPTION	BY	DRAWN: TZ	CHECKED: KC	REVIEWED: KC, TZ	DATE: 09/05/23	SCALE: AS SHOWN

SHEET NO.
55 OF 59
 DWG. NO.
L5.01

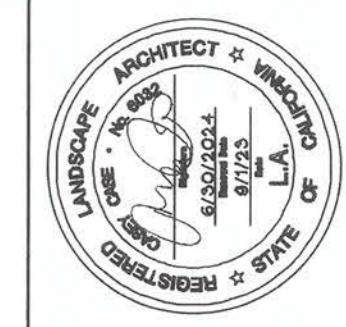

GATES + ASSOCIATES
 LANDSCAPE ARCHITECTURE
 LAND PLANNING URBAN DESIGN
 4850 W. 125th ST. SUITE 100
 LOS ANGELES, CA 90044
 T 310.336.8174 www.gatesla.com

ACCEPTED FOR USE:

 JOHN SAMUELSON
 City Engineer
 Date: 9/26/23




FRONTAGE ROAD LIVING TRAIL
 CONSTRUCTION DETAILS


BY	DRAWN: TZ	CHECKED: KC	REVIEWED: KC, TZ	DATE: 09/05/23	SCALE: AS SHOWN
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DATE	REV	DESCRIPTION


SHEET NO.
56 OF 59
 DWG. NO.
L5.02

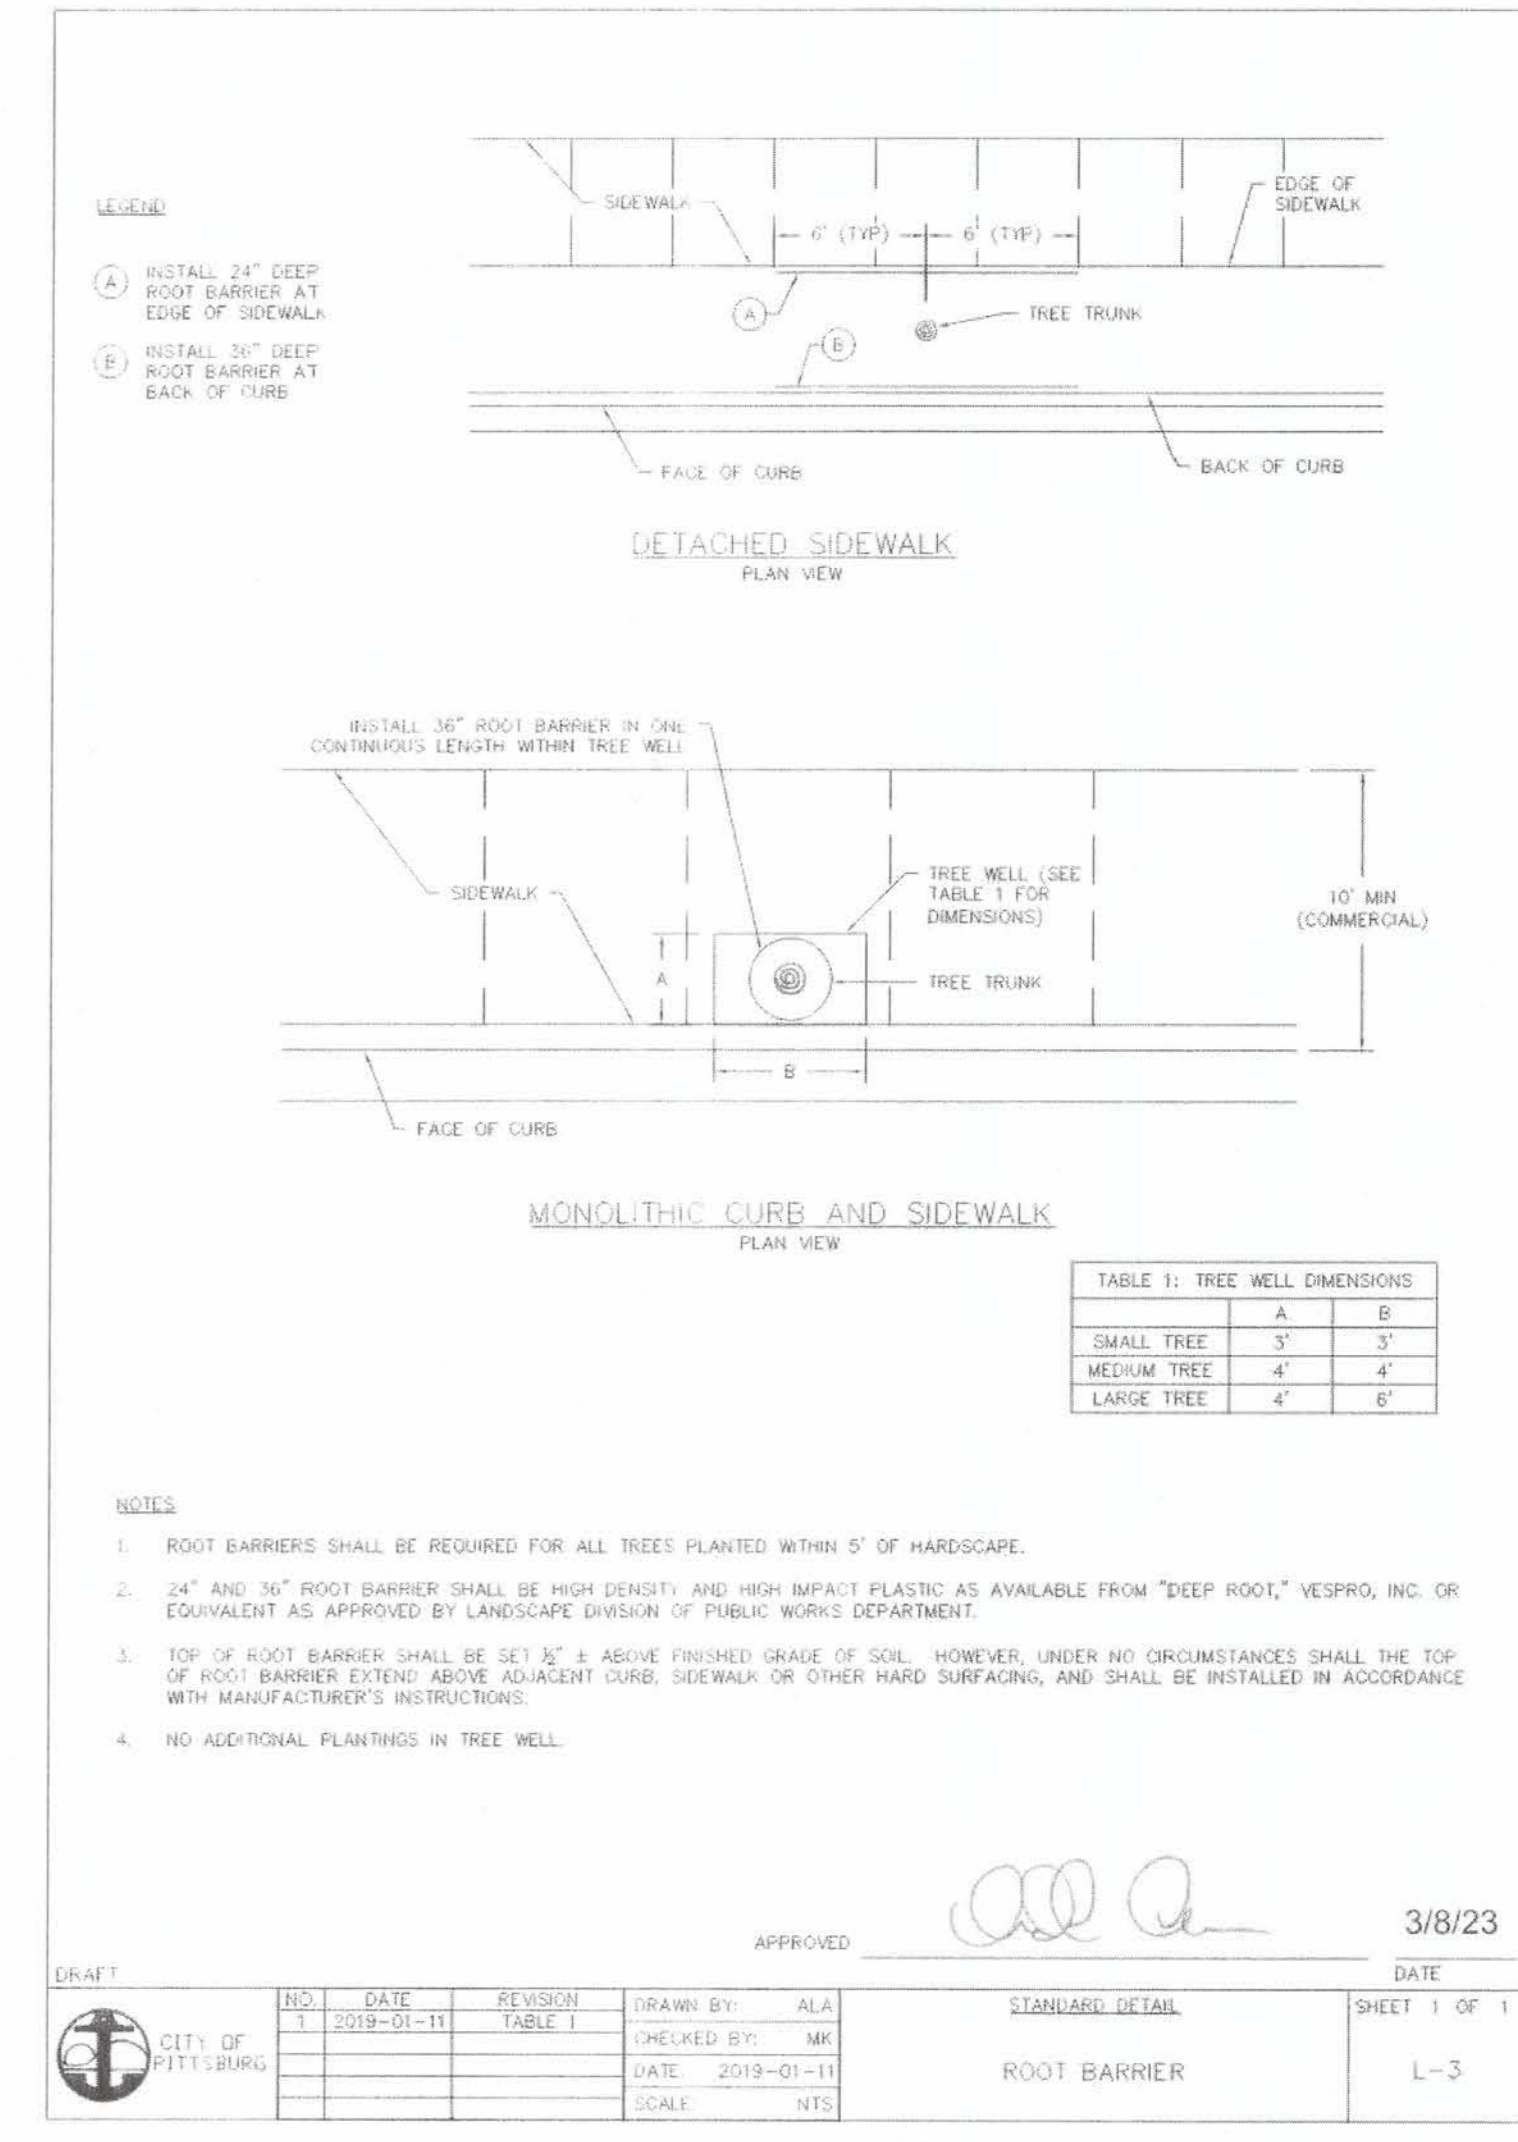

1 ROOT BARRIER
SCALE: N.T.S.

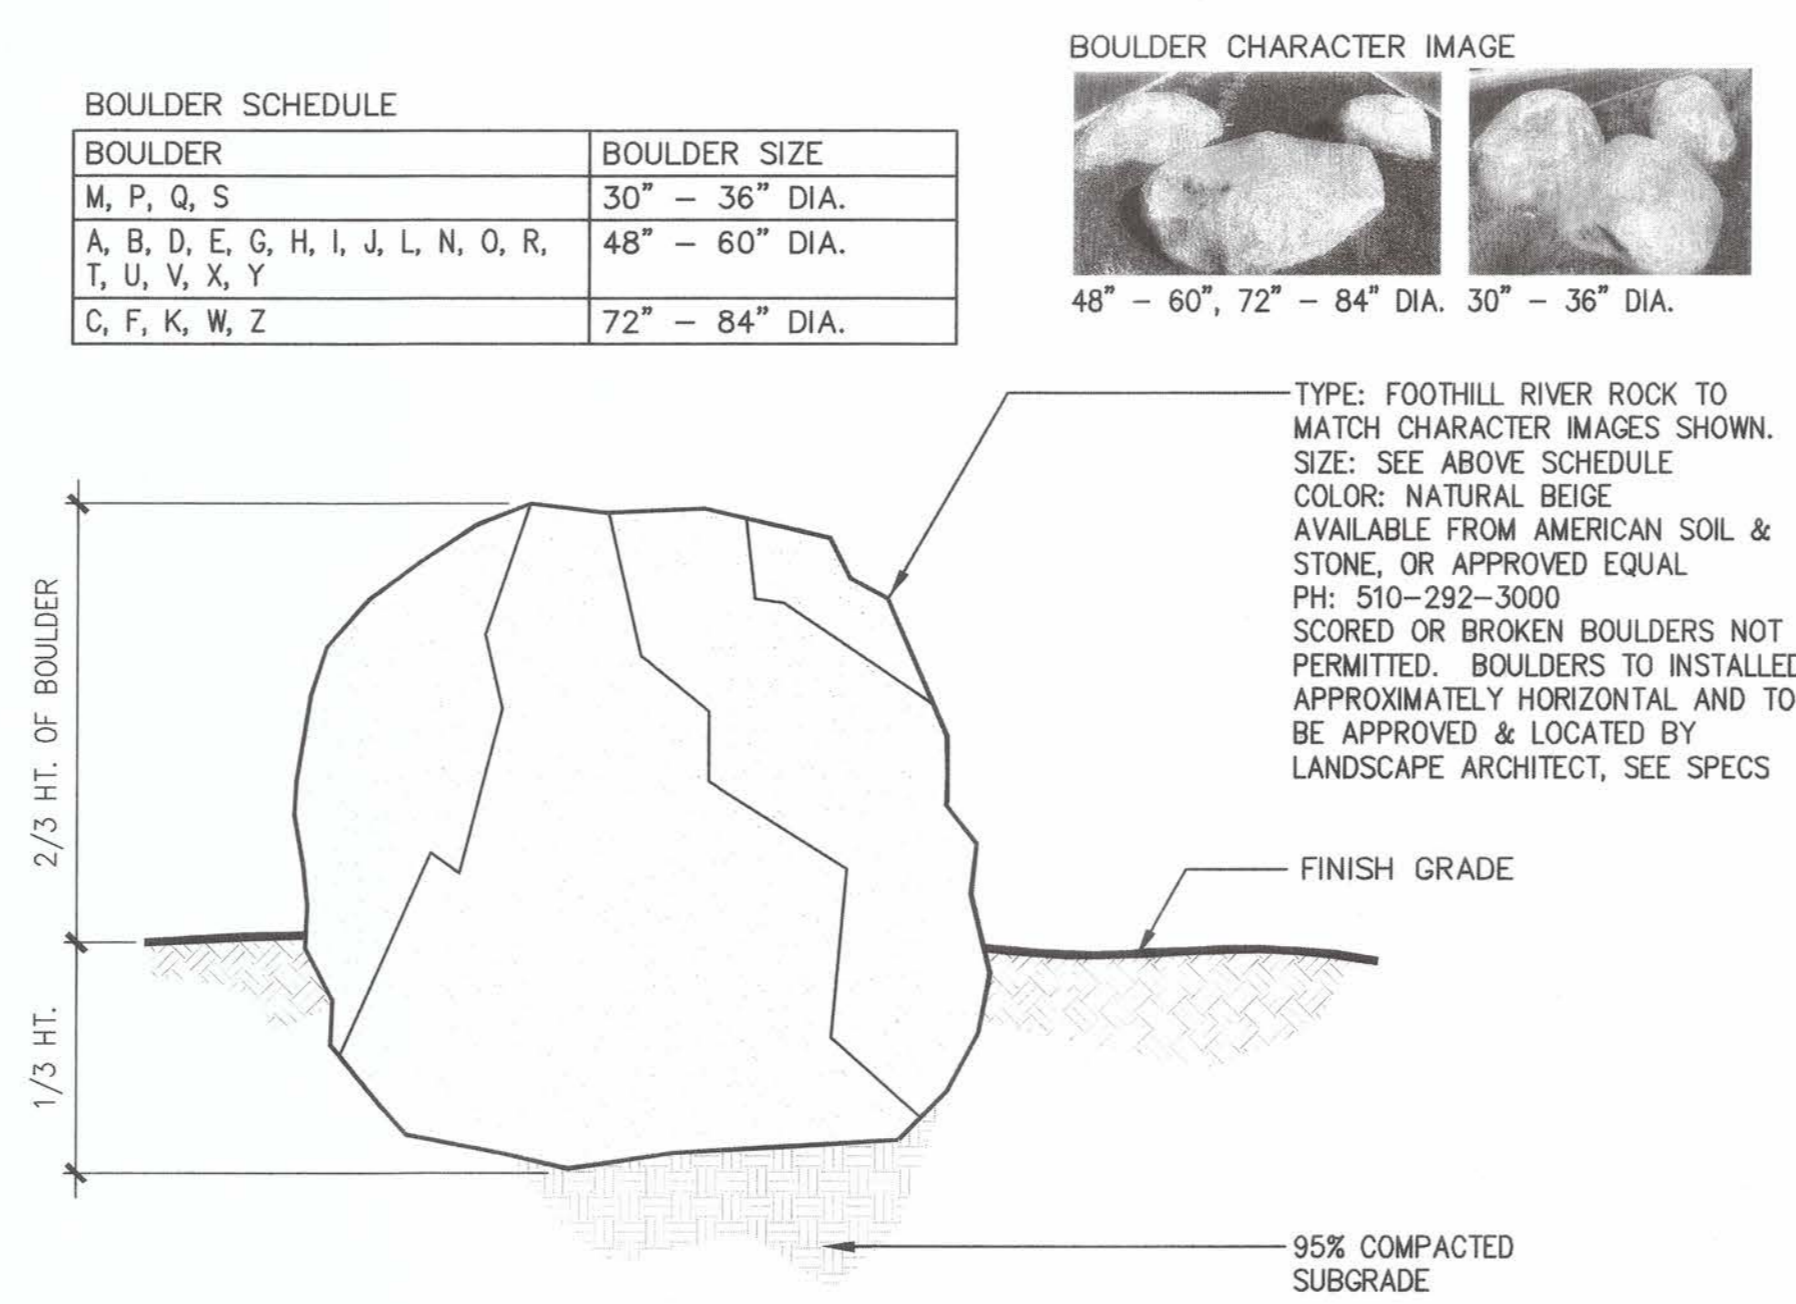


2 BOULDER PLACEMENT
SCALE: 1/2" = 1'-0"

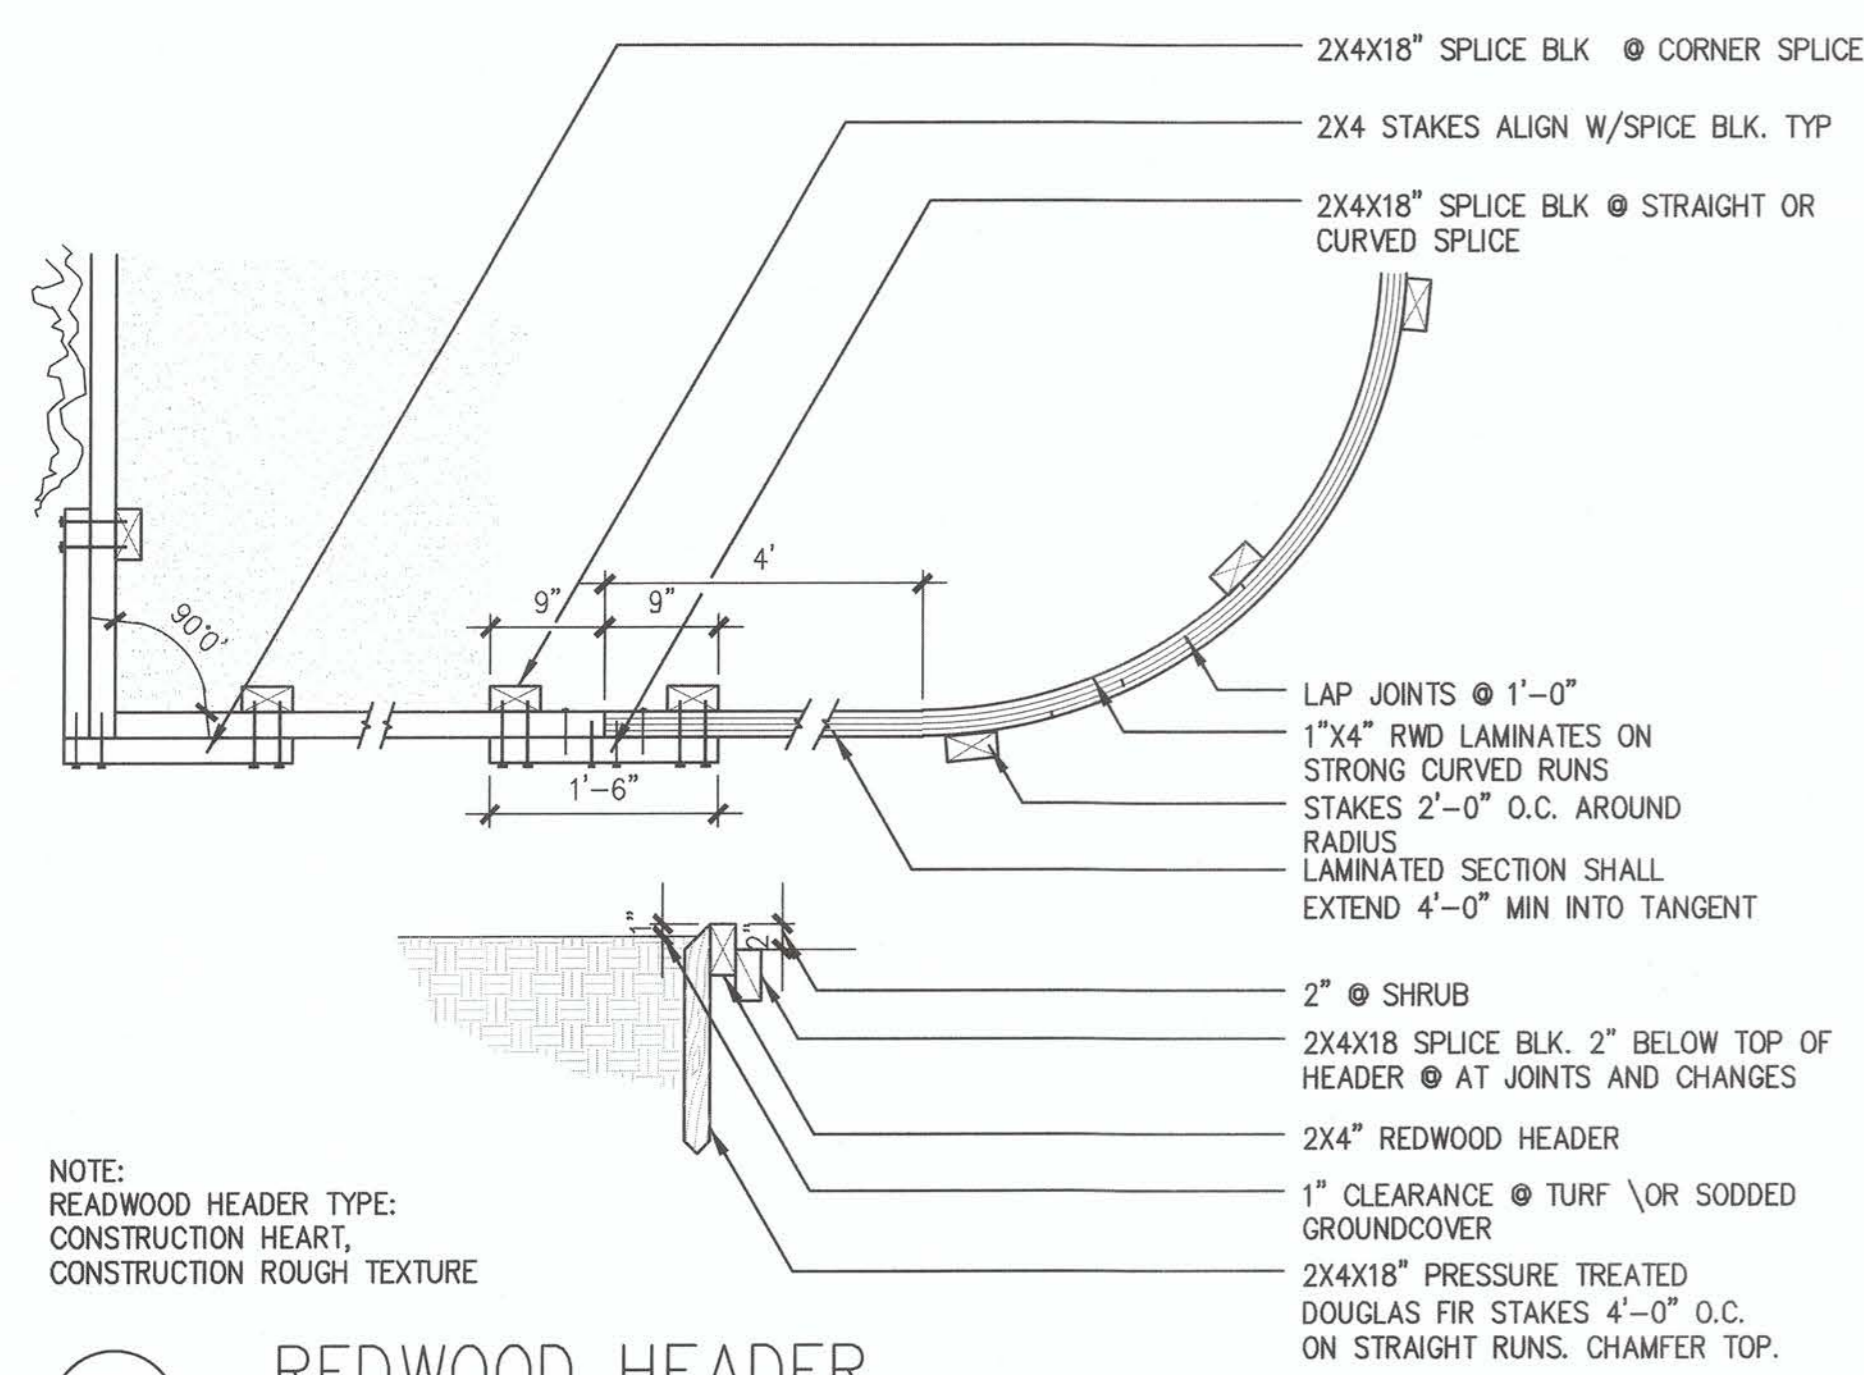


3 REDWOOD HEADER
SCALE: 3/4" = 1'-0"

PATH: P:\PITTSBURG\FRONTAGE ROAD LIVING TRAIL (P6108)\CAD\SHETS\DC-D-FRONTAGE ROAD LIVING TRAIL.DWG
 PLOT DATE: 8/31/2023 2:46 PM

- NOTES:**
- CONTRACTOR TO PROVIDE CPSI INSPECTION UPON COMPLETION.
 - CONTRACTOR SHALL PERFORM A COMPACTION TEST OF AGGREGATE BASE TO CONFIRM CONDITIONS MEET MFR'S SPECIFICATIONS PRIOR TO INSTALLATION OF POURED IN PLACE.
 - SURFACING SHALL MEET ALL REQUIREMENTS OF ASTM 1951F AND ASTM F1292
 - SYNTHETIC PLAY SURFACING, SEE LEGEND L1.01
 - SEE DETAIL 4/L5.05 FOR FITNESS EQUIPMENT SUBGRADE INFO

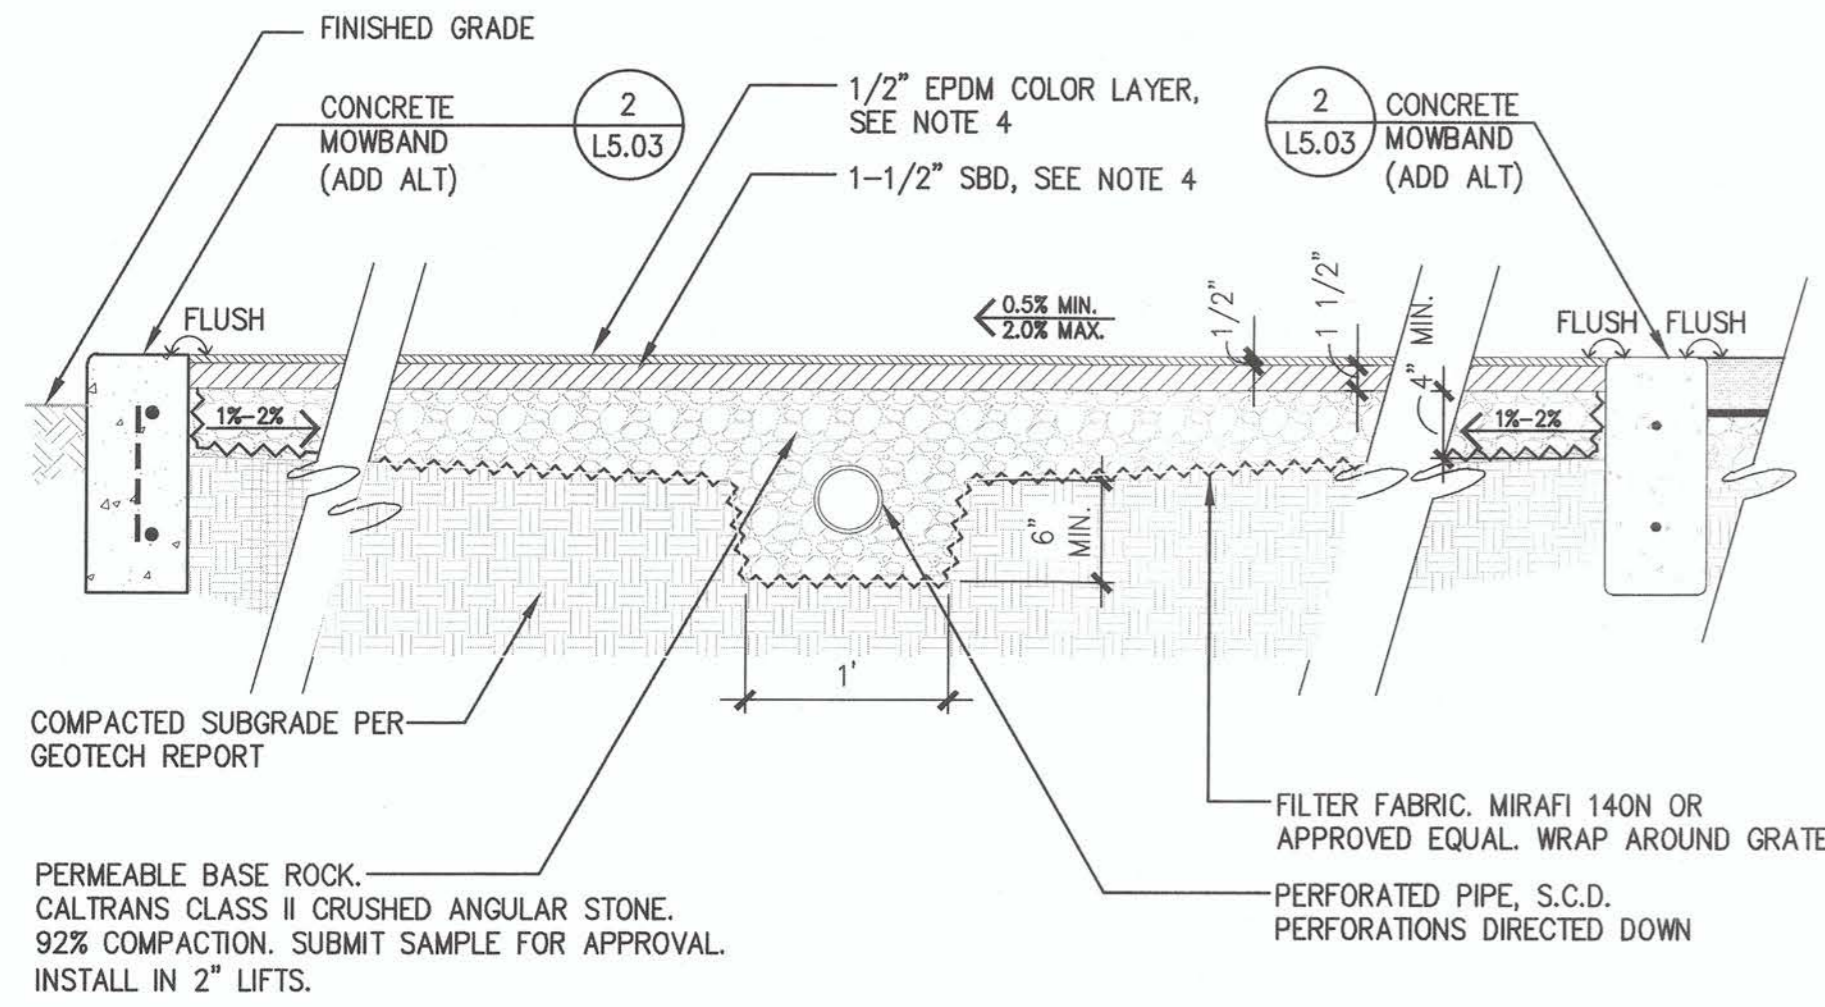


4 SYNTHETIC RUBBER SURFACING (ADD ALT)
SCALE: 1" = 1'-0"

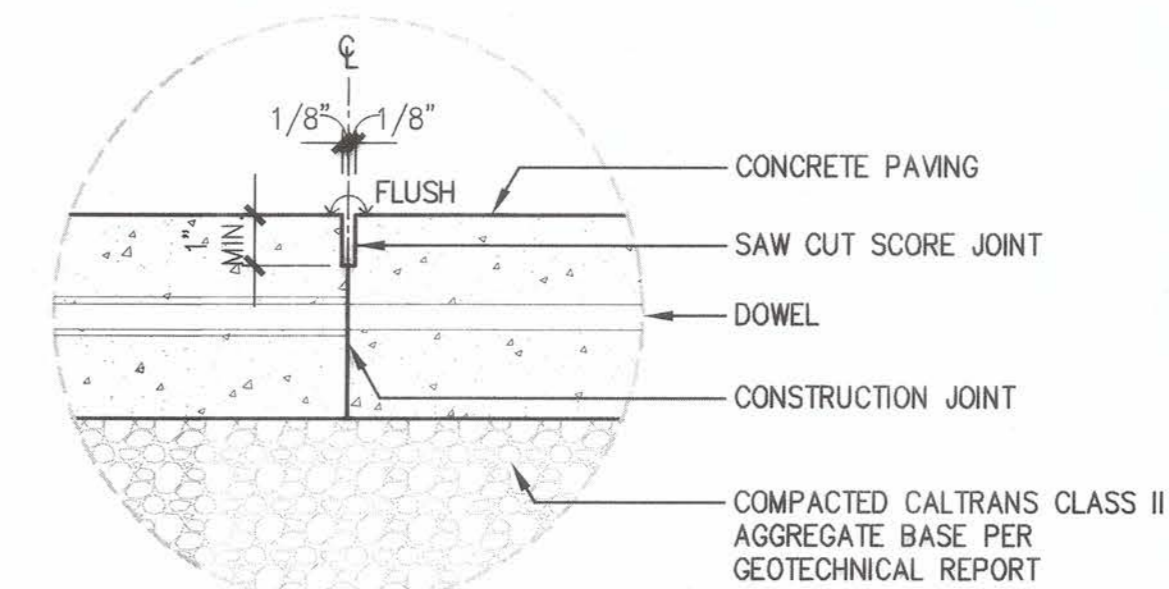


SECTION @ CONSTRUCTION JOINT
SCALE: 3" = 1'-0"

- NOTES:**
- DOWEL INTO EXISTING CURB SHALL BE INSTALLED PER CITY STANDARD DETAIL ST-9A

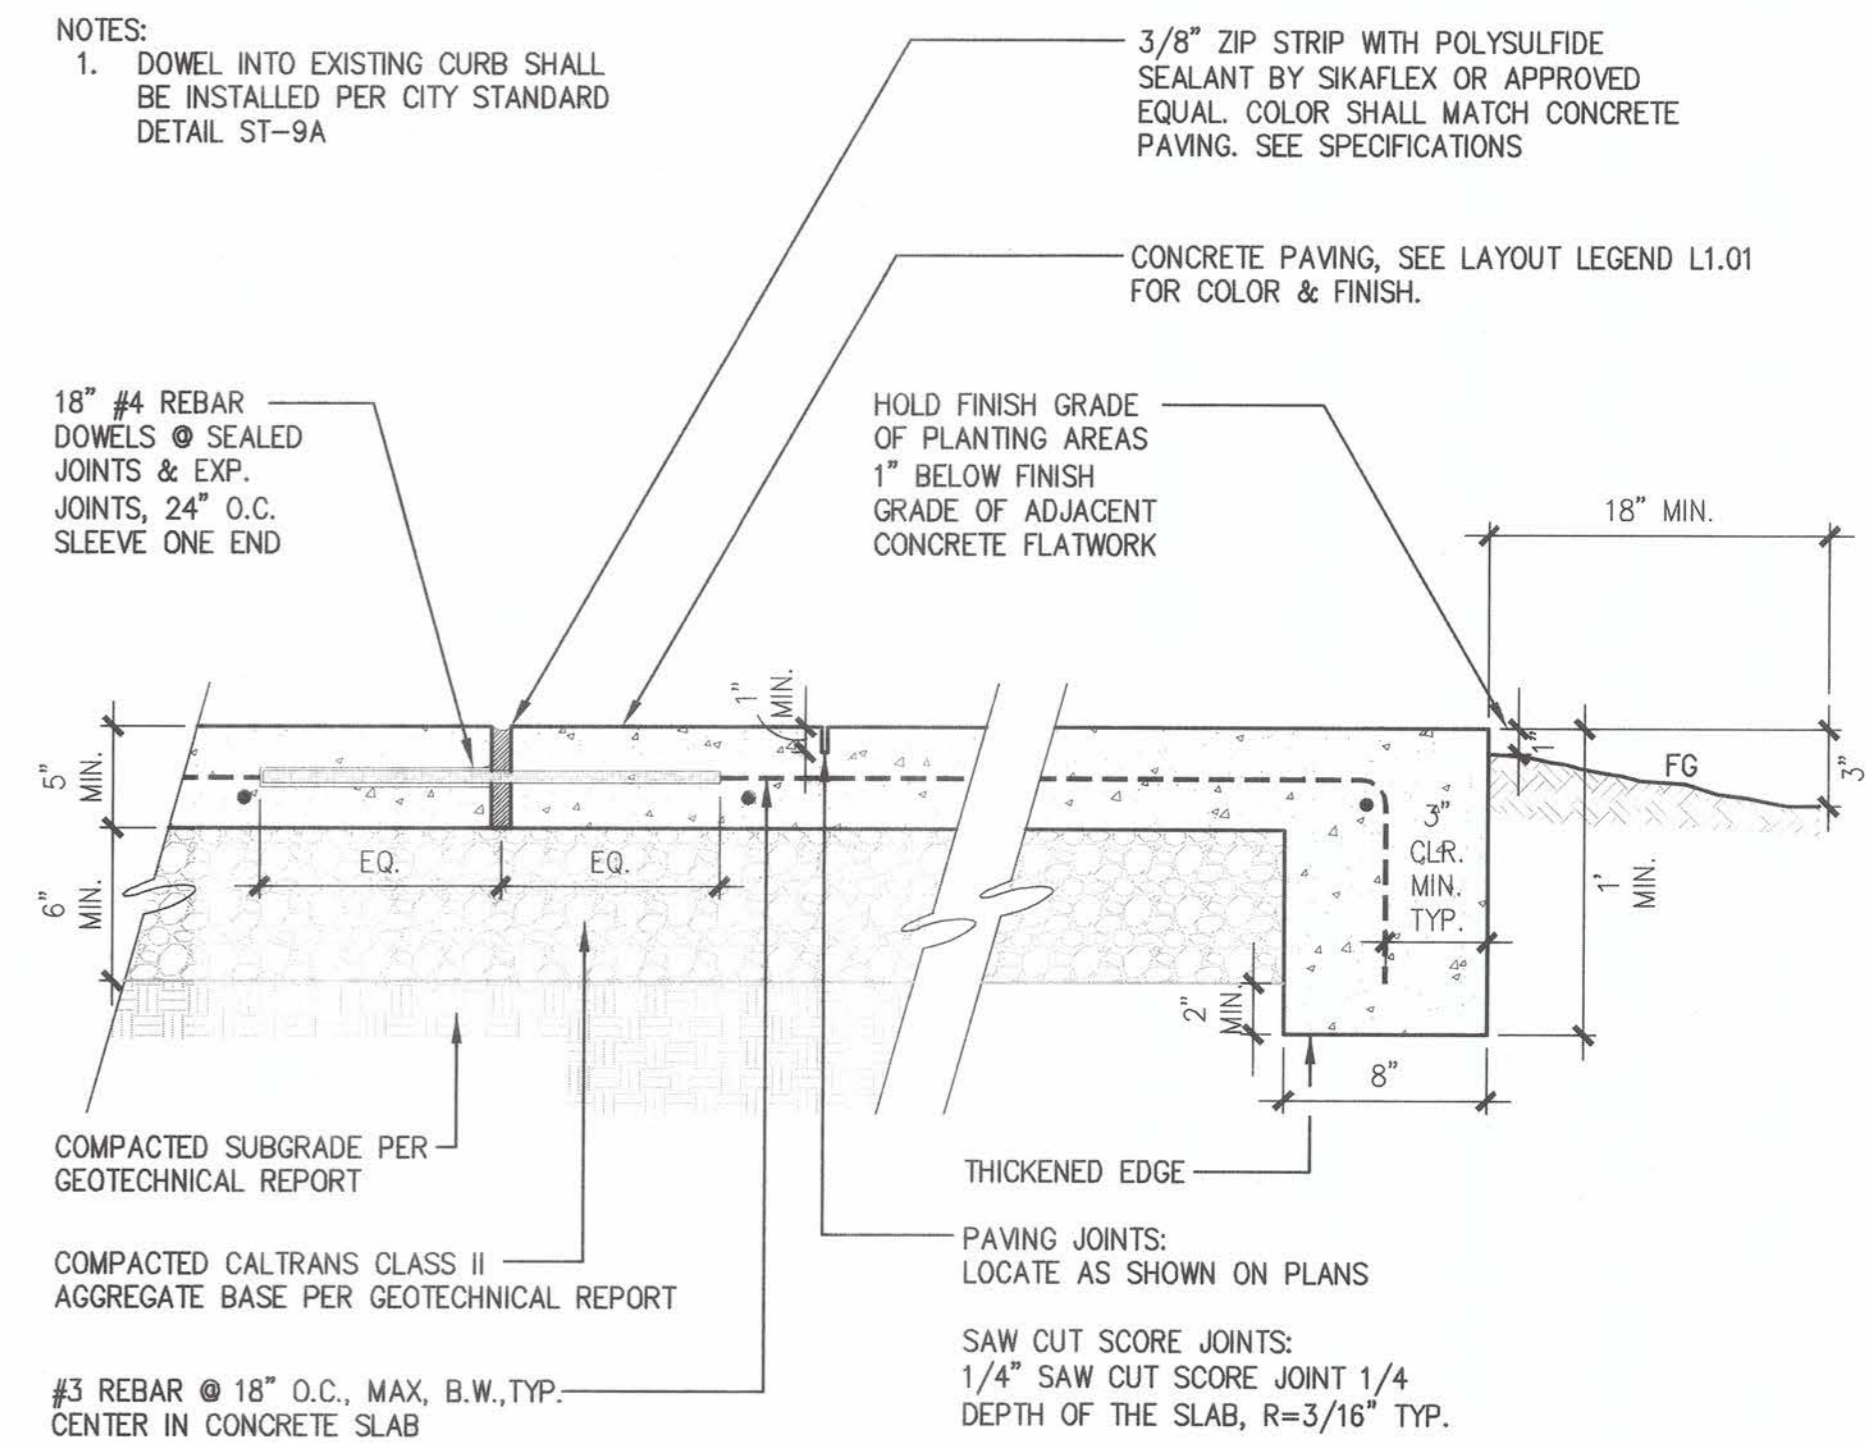


SECTION
SCALE: 1-1/2" = 1'-0"

1 PEDESTRIAN CONCRETE PAVING
SCALE: 1-1/2" = 1'-0"

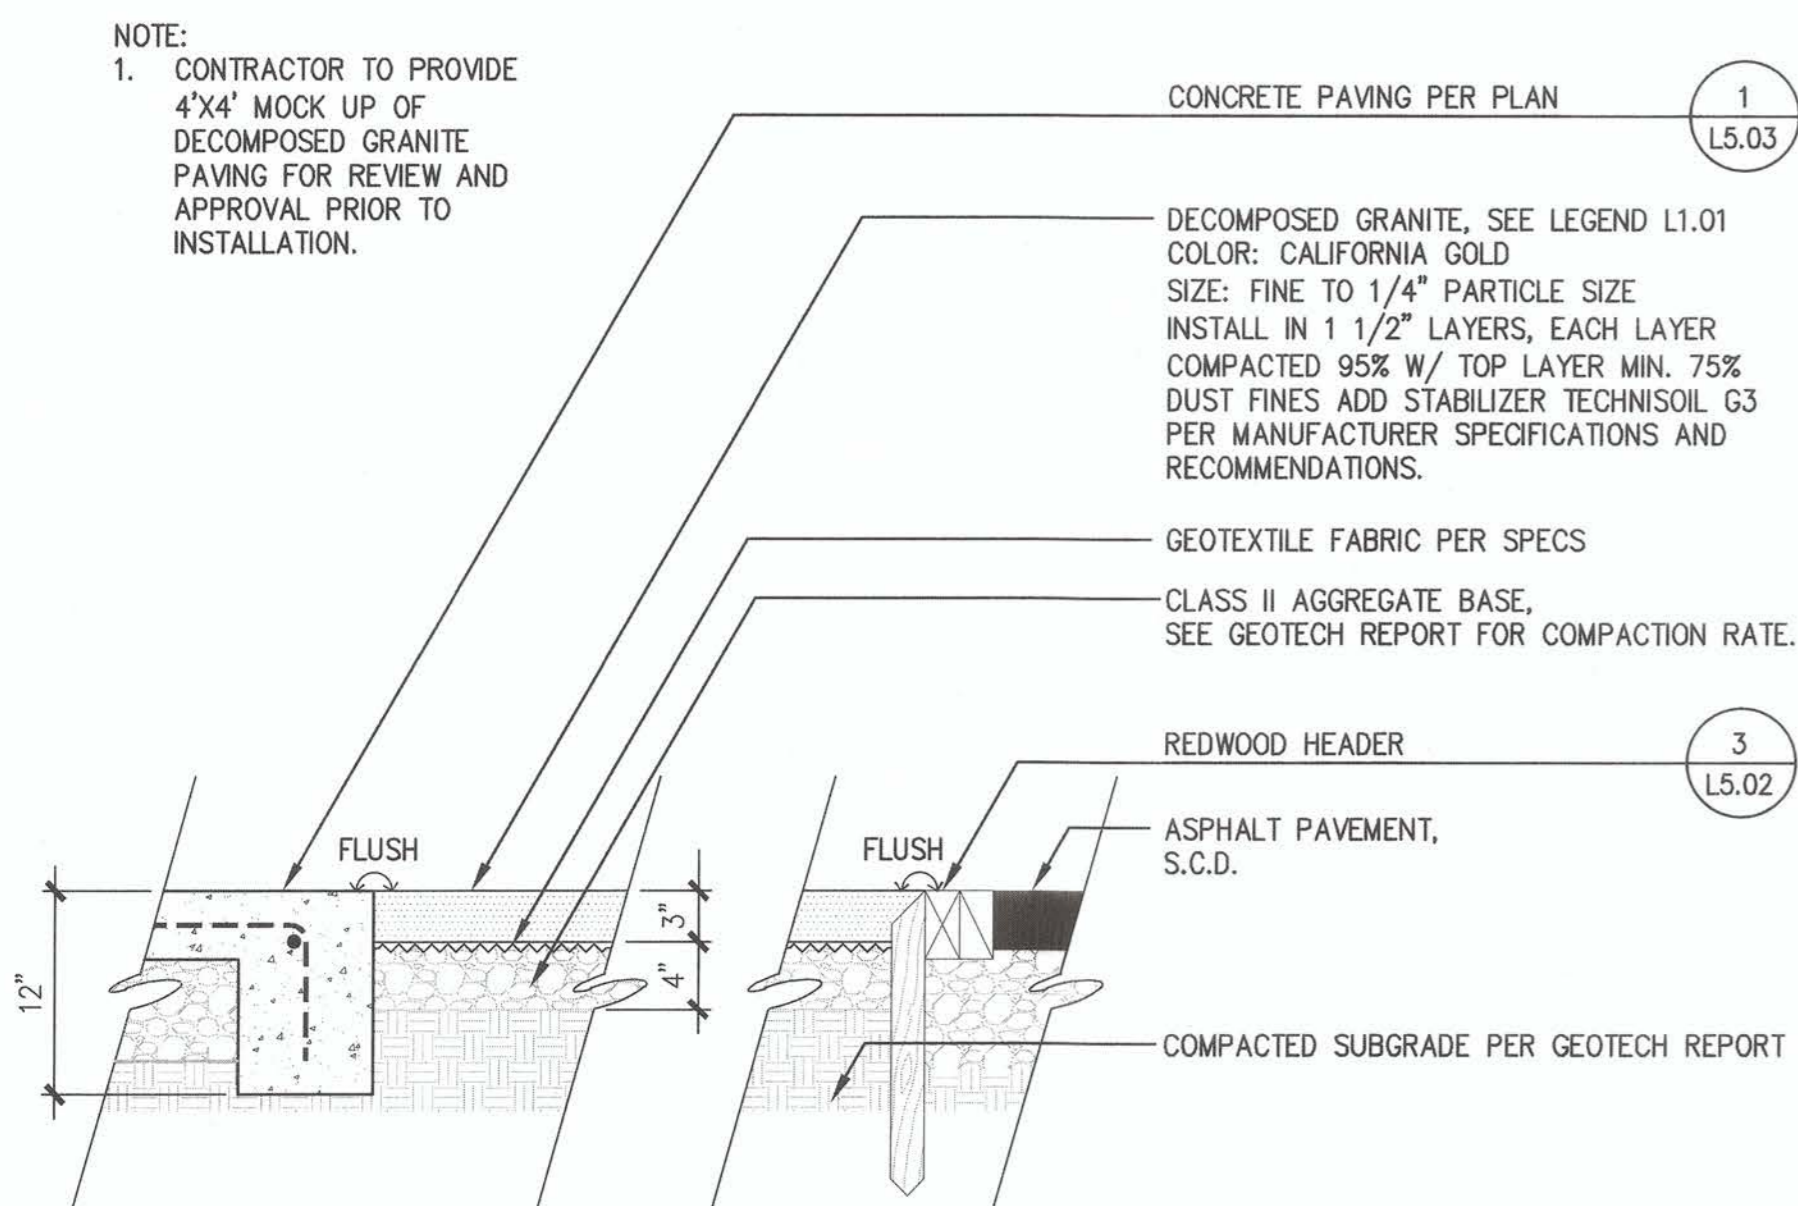

3 DECOMPOSED GRANITE PAVING
SCALE: 1" = 1'-0"

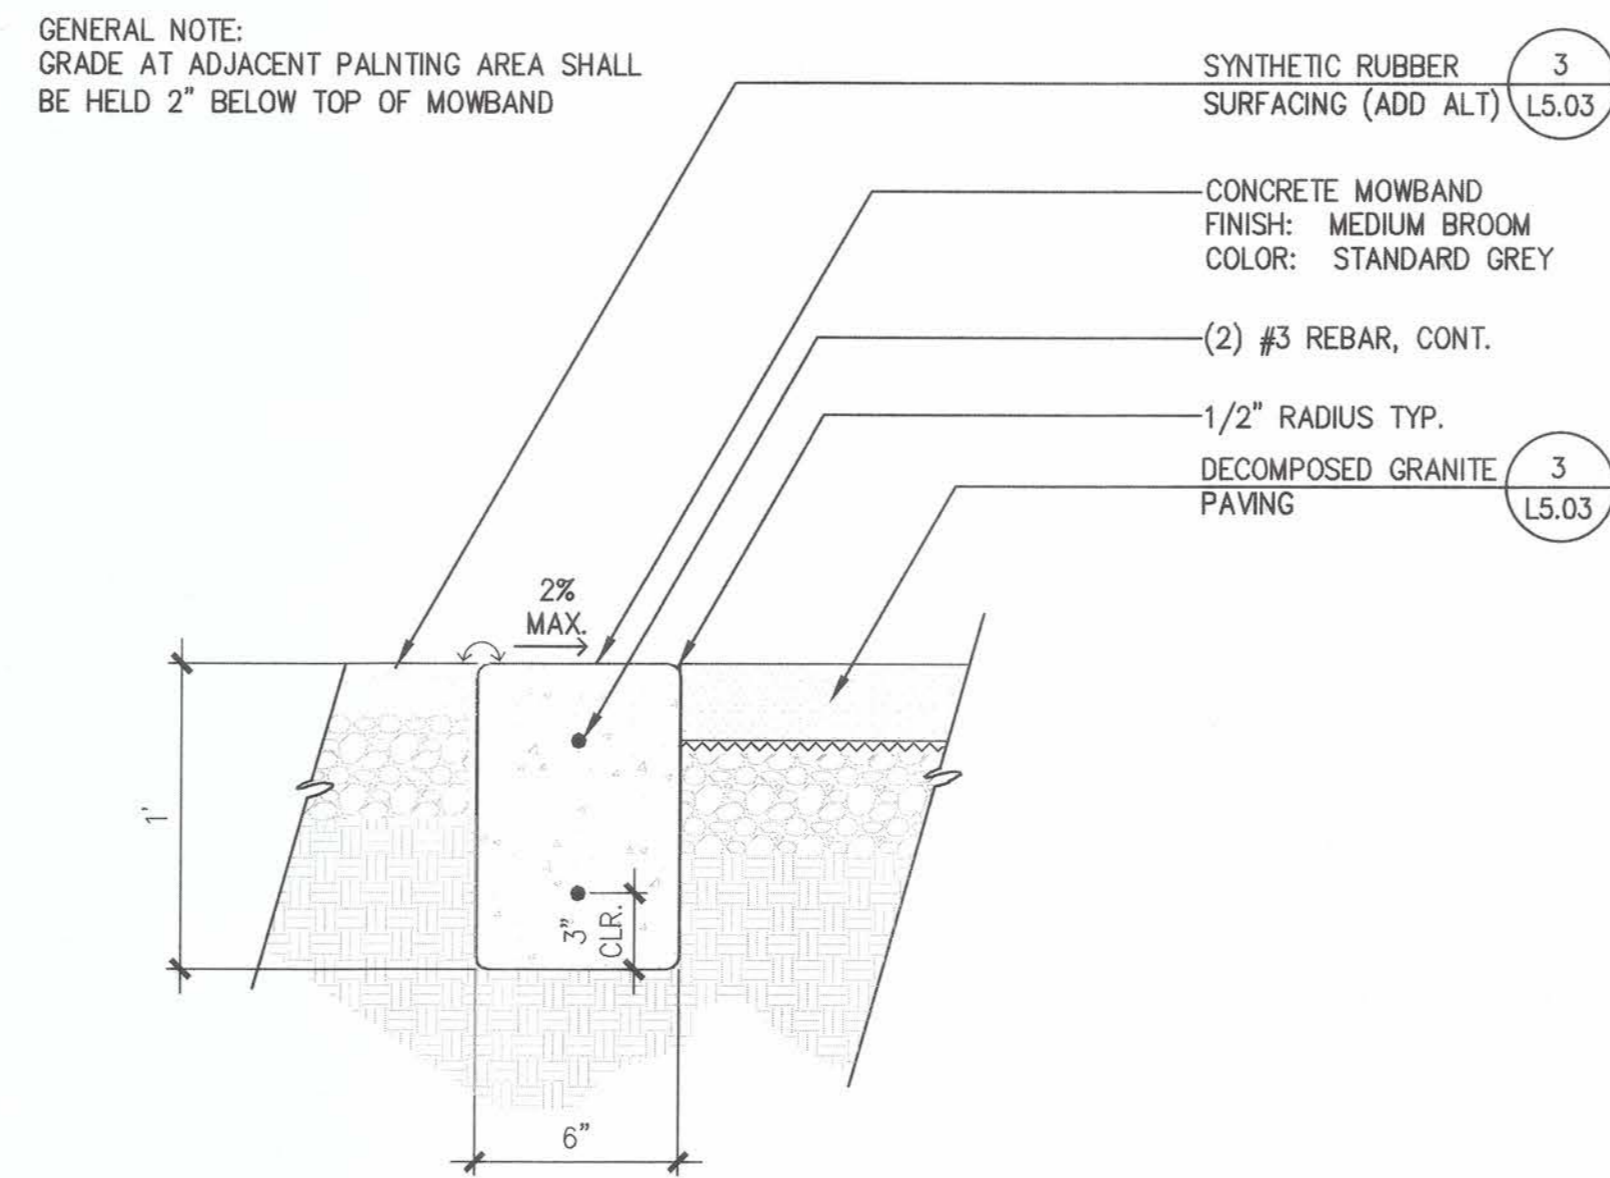

2 CONCRETE MOWBAND (ADD ALT)
SCALE: 1-1/2" = 1'-0"



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LANDSCAPE ARCHITECTURE
URBAN PLANNING - URBAN DESIGN
1800 PARKET STE 300 WILMINGTON, DE 19806
T 302.771.8174 www.gates.com

ACCEPTED FOR USE:
JOHN SAMUELSON
City Engineer
Date: 9/24/23



City of Pittsburgh


FRONTAGE ROAD LIVING TRAIL
CONSTRUCTION DETAILS

BY: DRAWN: TZ
CHECKED: KC
REVIEWED: KC, TZ
DATE: 09/05/23
SCALE: AS SHOWN


DATE	REV	DESCRIPTION

SHEET NO.
57 OF 59
DWG. NO.
L5.03


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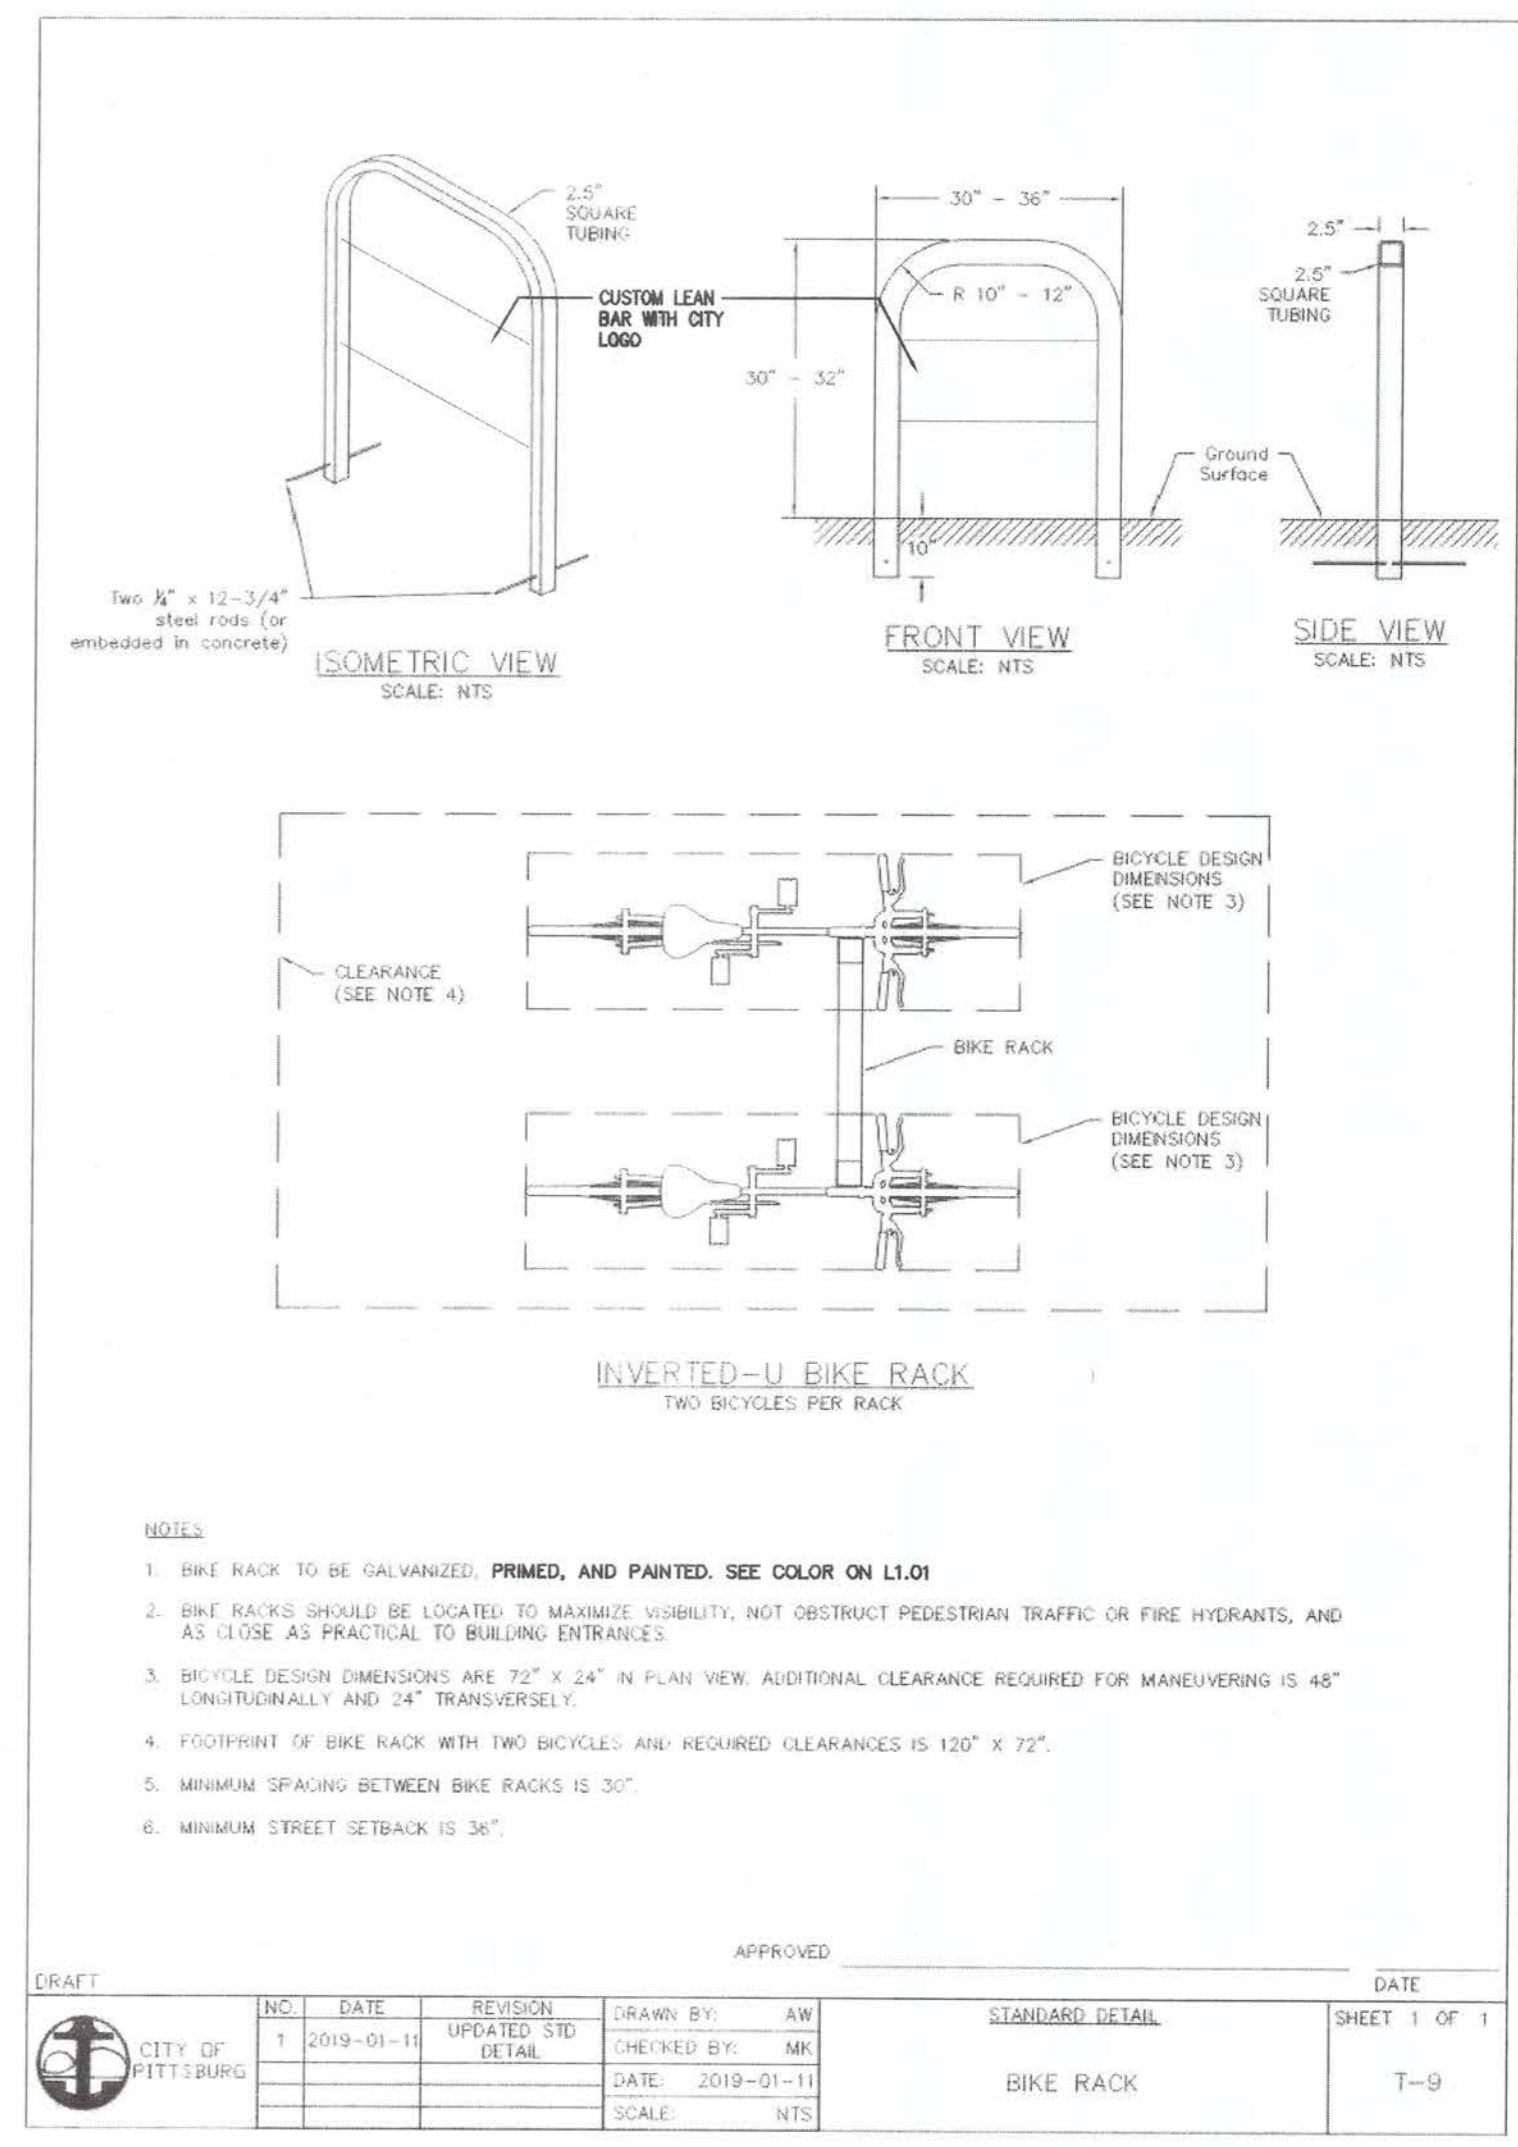
4 DOG WASTE DISPENSER
 SCALE: 3/4" = 1'-0"

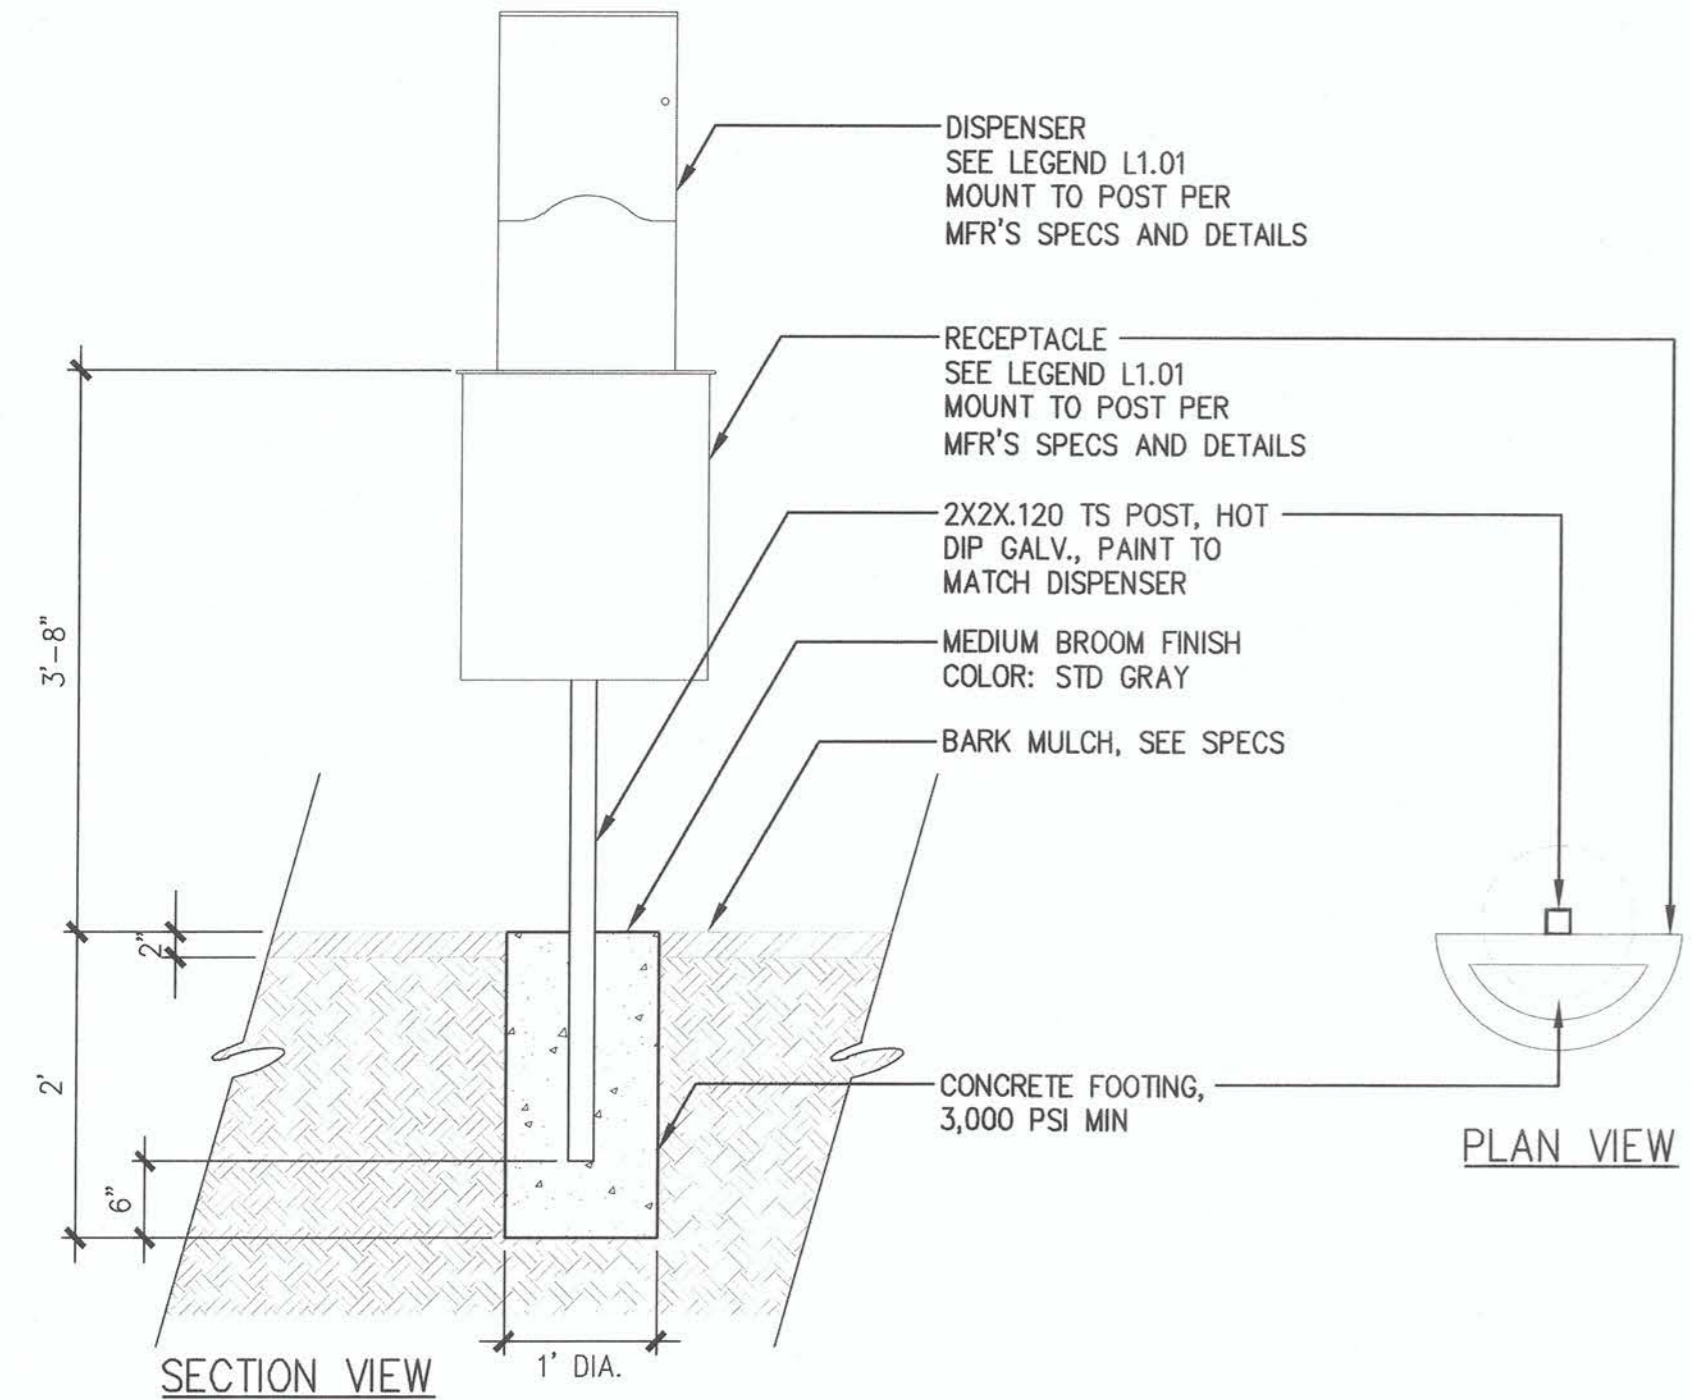


3 BIKE REPAIR STATION AND BOTTLE FILLER
 SCALE: 1" = 1"

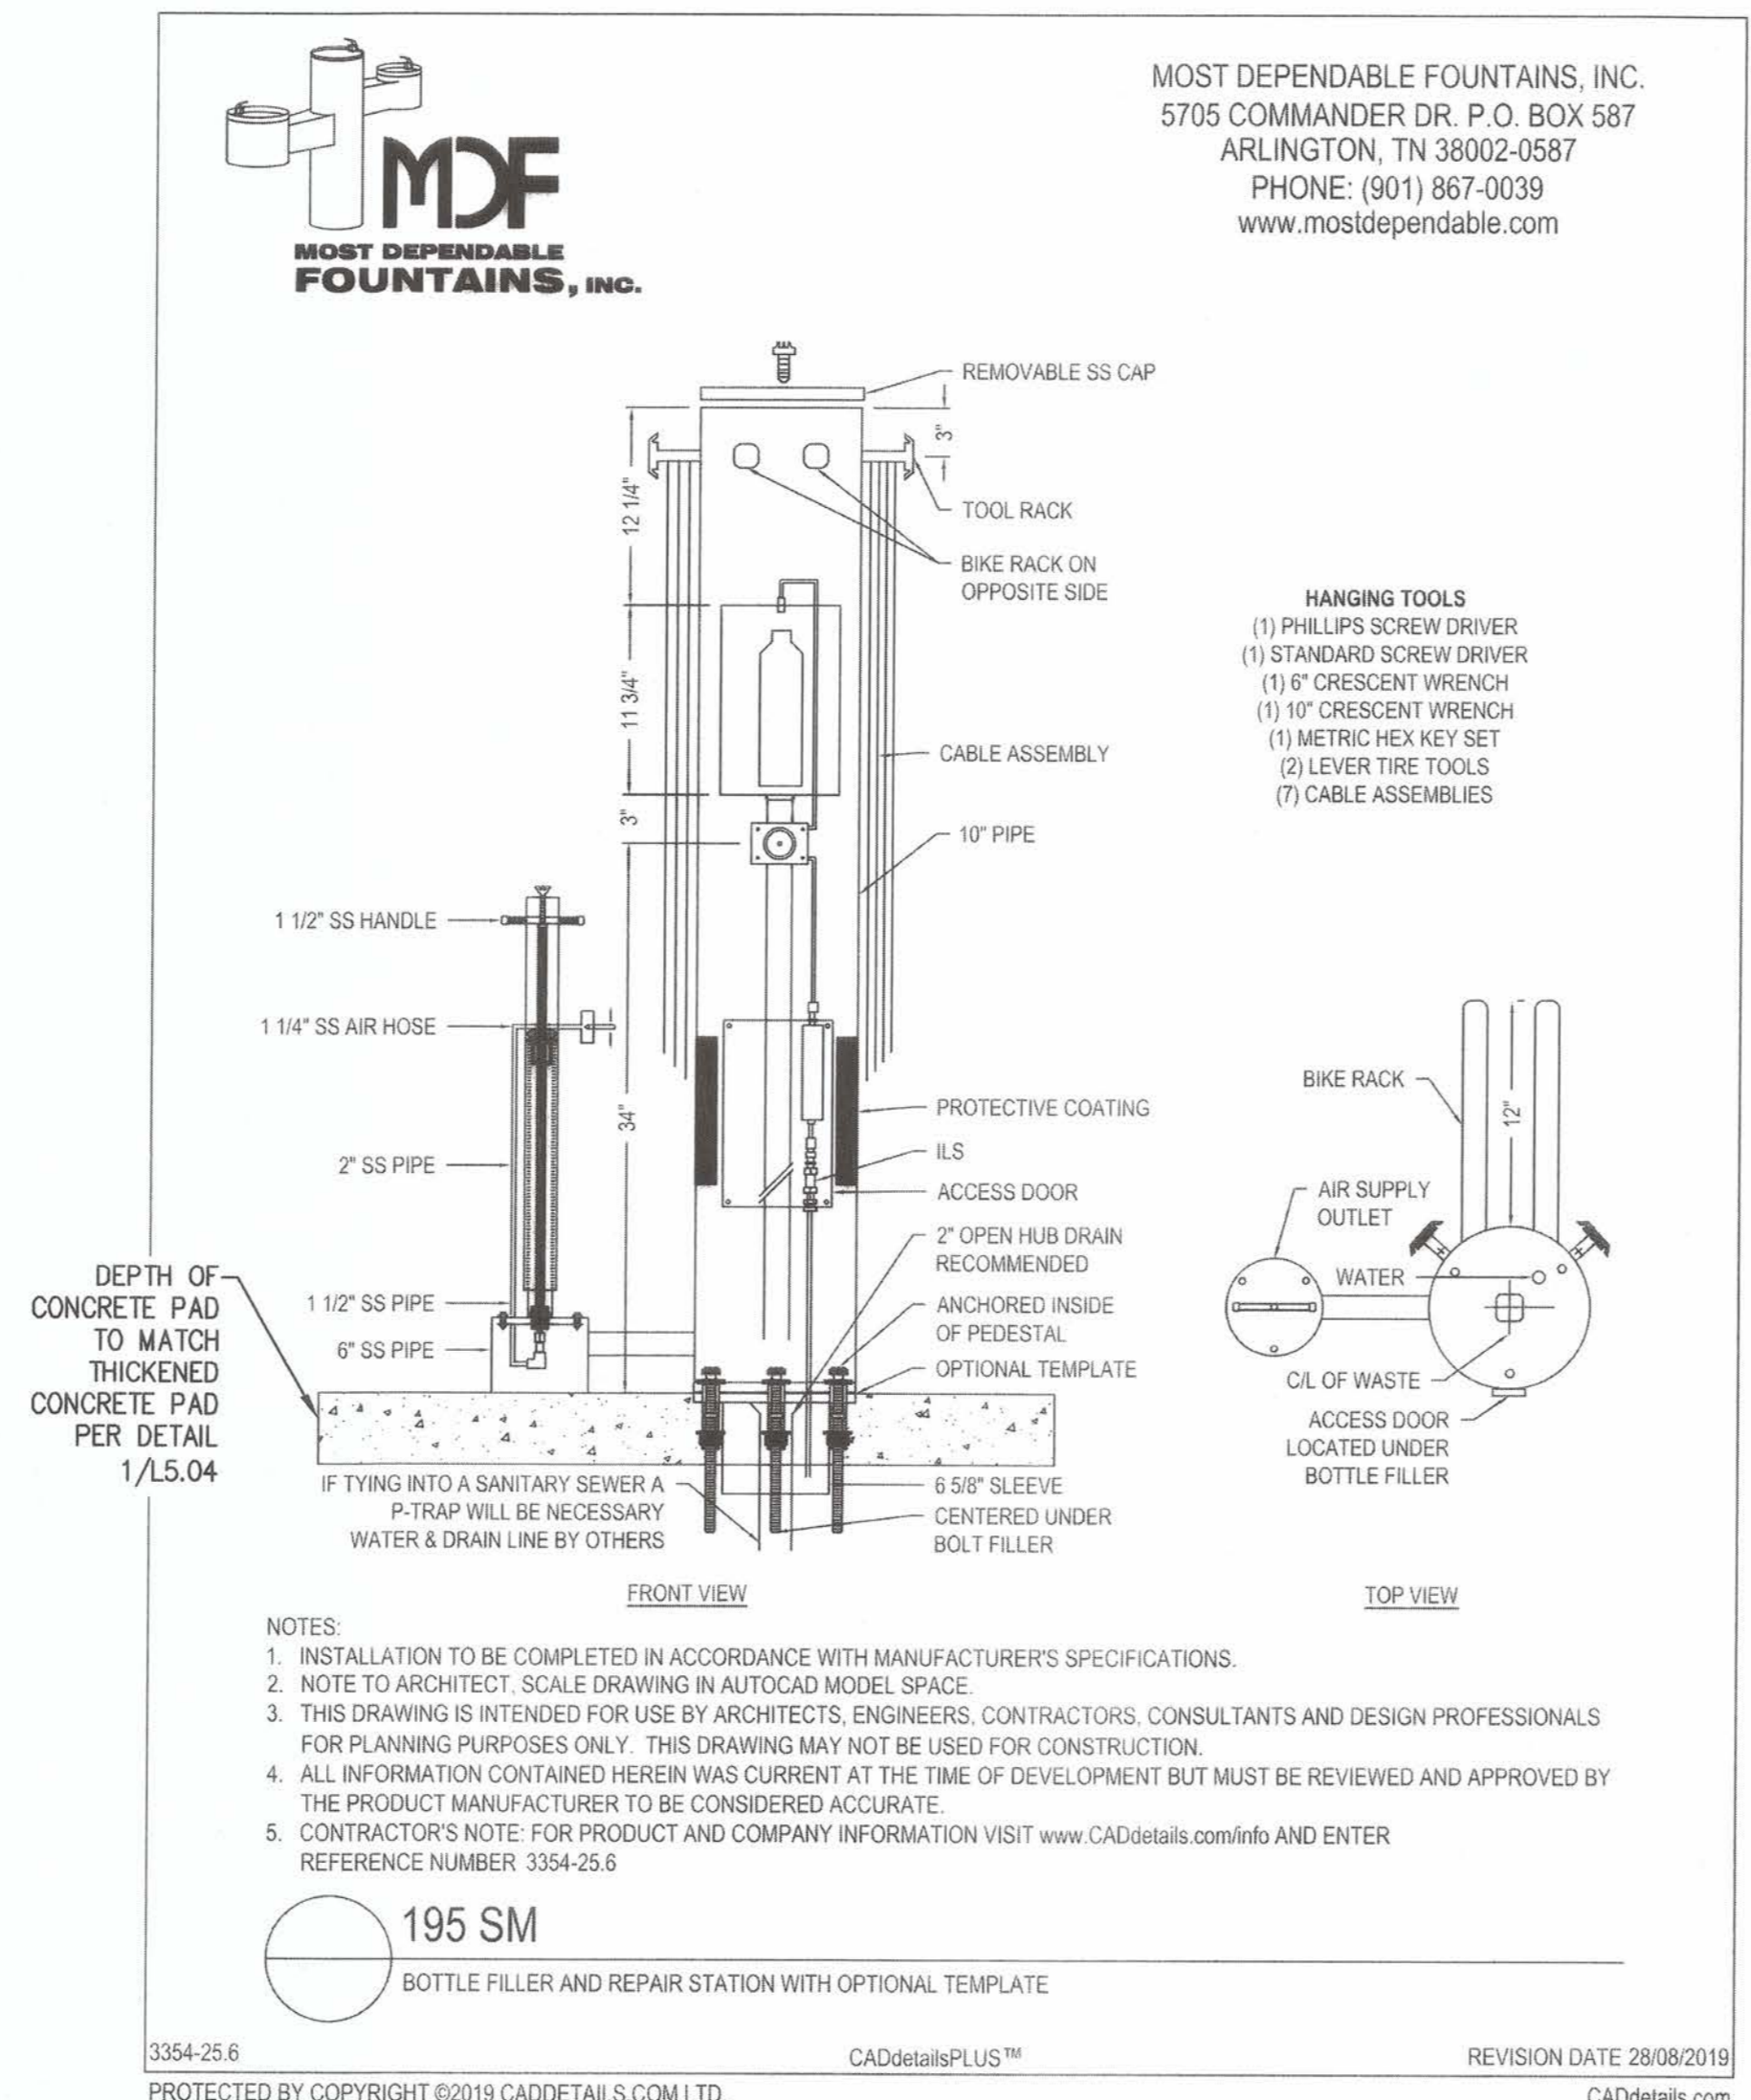

2 BIKE RACK ELEVATION SECTION
 SCALE: 1" = 1'-0"

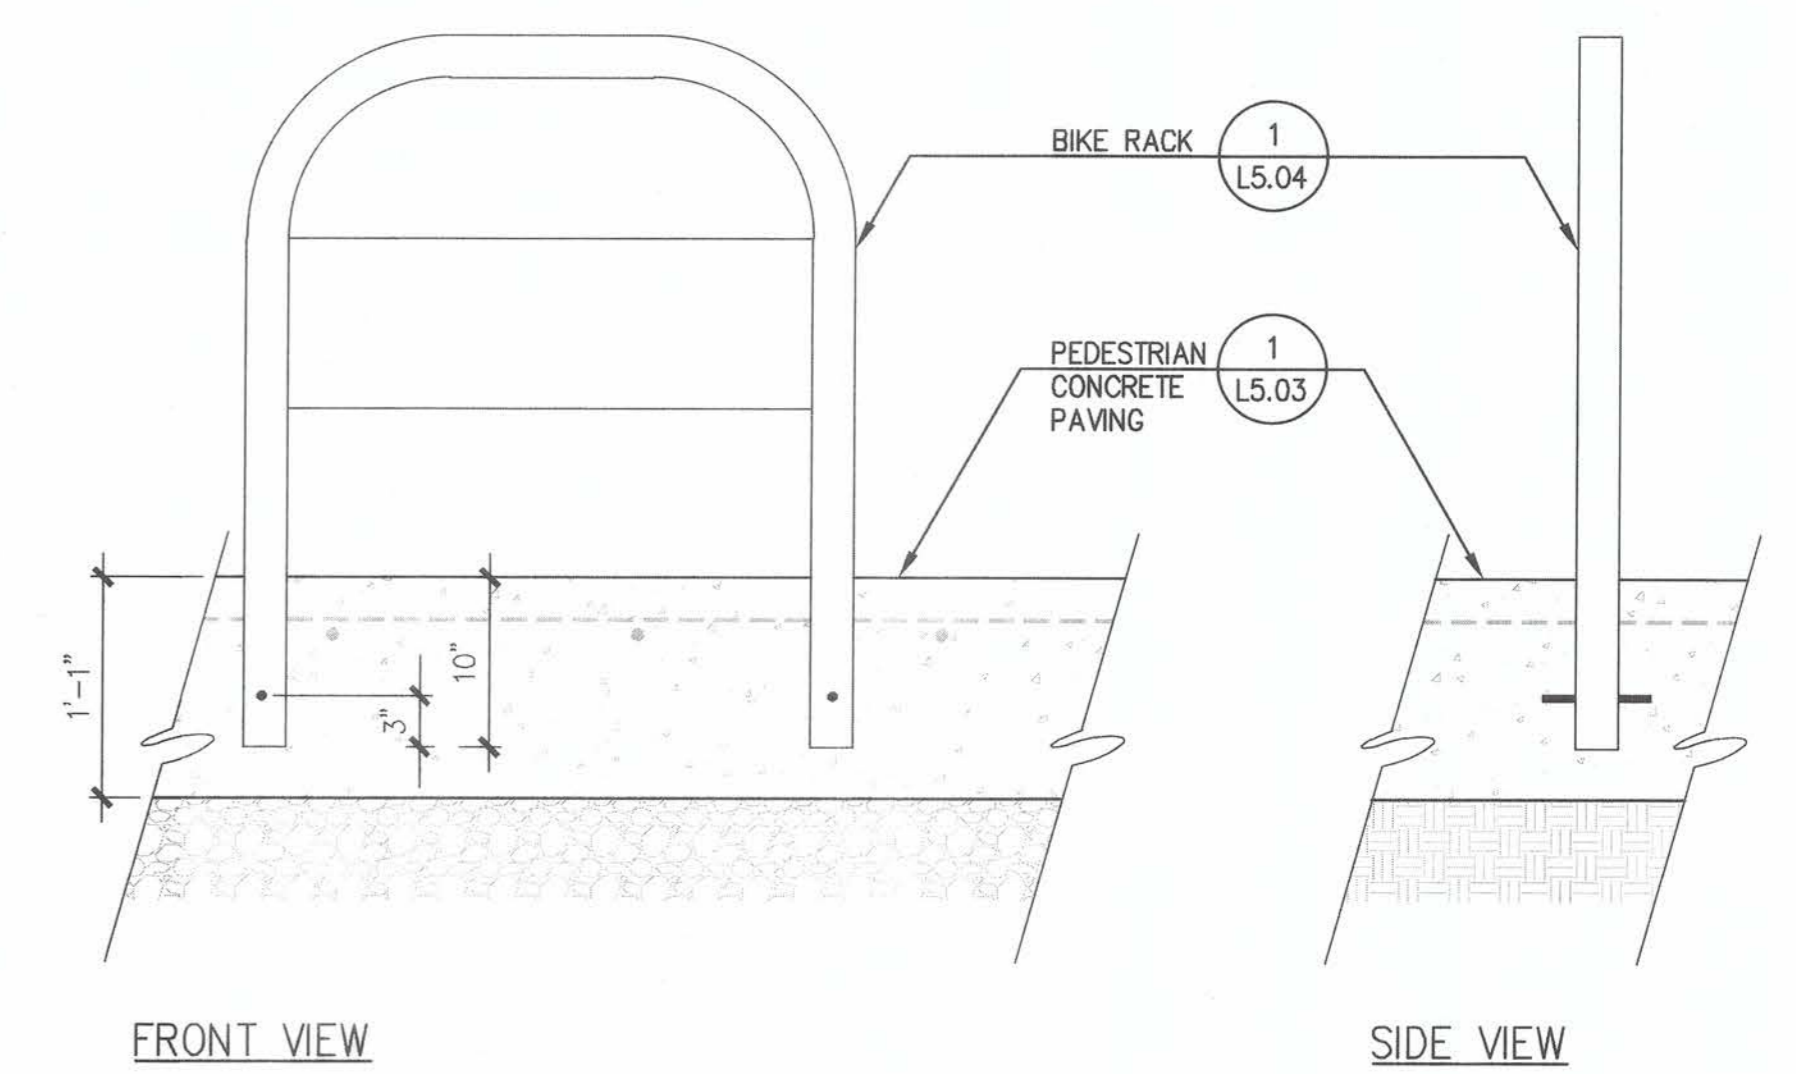

1 BIKE RACK
 SCALE: N.T.S.

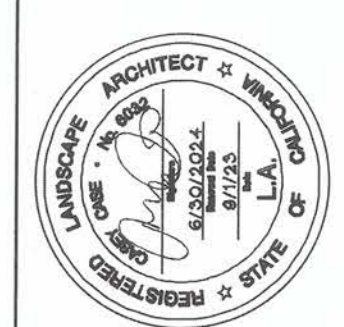

GATES + ASSOCIATES
 LANDSCAPE ARCHITECTURE
 LAND PLANNING · URBAN DESIGN
 1831 N. PARKER ST. SUITE 100, PITTSBURGH, PA 15203
 T 724.731.8174 WWW.GATESA.COM

ACCEPTED FOR USE:
 JOHN SAMUELSON
 City Engineer
 Date: 7/26/23



FRONTAGE ROAD LIVING TRAIL
 CONSTRUCTION DETAILS

BY: DRAWN: TZ
 CHECKED: KC
 REVIEWED: KC, TZ
 DATE: 09/05/23
 SCALE: AS SHOWN

DATE	REV	DESCRIPTION

SHEET NO.
 58 OF 59
 DWG. NO.
L5.04

PATH: P:\PITTSBURGH\FRONTAGE ROAD LIVING TRAIL (95108)\CAD\SHETS\LD-D-FRONTAGE ROAD LIVING TRAIL.DWG
 PLOT DATE: 8/31/2023 2:46 PM

PROJECT NAME FITNESS ZONE

The fitness equipment is designed for your enjoyment.
 For your safety, we ask you to comply with the following:

- 1 You assume all risk and responsibility for use of the exercise equipment at this facility.
- 2 You must be at least 14 years old to use this equipment.
- 3 Parents/Guardians: To avoid injuries, do not let your underage children use the equipment.
- 4 Consult your physician prior to starting any physical fitness training program.
- 5 The city does not provide any supervision for the use of the equipment.
- 6 Any potential users with known adverse health conditions should not use this equipment.
- 7 Before using the equipment, check for loose parts, breaks, cracks or other conditions needing attention. If any abnormalities are noticed, do not use the equipment. Please call 888-315-9037.
- 8 Only use equipment for the intended exercise. Perform exercises according to instructions on each piece of equipment.
- 9 Breathe normally during physical activity.
- 10 Perform resistance exercises according to instructions in a slow, controlled manner over the full range of motion. Performing the movements too quickly may result in an injury.
- 11 During exercise, pay attention to how your body feels. If pain or discomfort occurs, STOP THE EXERCISE IMMEDIATELY.
- 12 Rest and recovery are important between sets and exercises. Please allow 2 minutes of rest between exercises.
- 13 Keep a safe distance from exercise equipment when in use by others. Keep clear of moving part and be aware of the presence of others when using equipment.
- 14 Remove helmets, drawstrings, or accessories around the neck.
- 15 Be aware of the possibility of hot surfaces and/or surfacing, when applicable.
- 16 Do not climb or allow climbing on the equipment or structures unless the intended use involves climbing on the equipment.
- 17 Do not attach straps, bands or similar items to the equipment unless the intended use specifically allows it.
- 18 Equipment is designed to support users up to 300 lbs.

NOTE:
 1. ANNOUNCEMENT BOARD DESCRIPTION SHALL BE REVIEWED AND APPROVED BY THE CITY OF PITTSBURGH PRIOR TO FABRICATION.

Installation Instructions:
 SHP520
 12-Person Challenge Fitness Rig
 This unit ships in 18 separately wrapped components.





Parts List:

13x Extensions for In Ground



22x Pegs

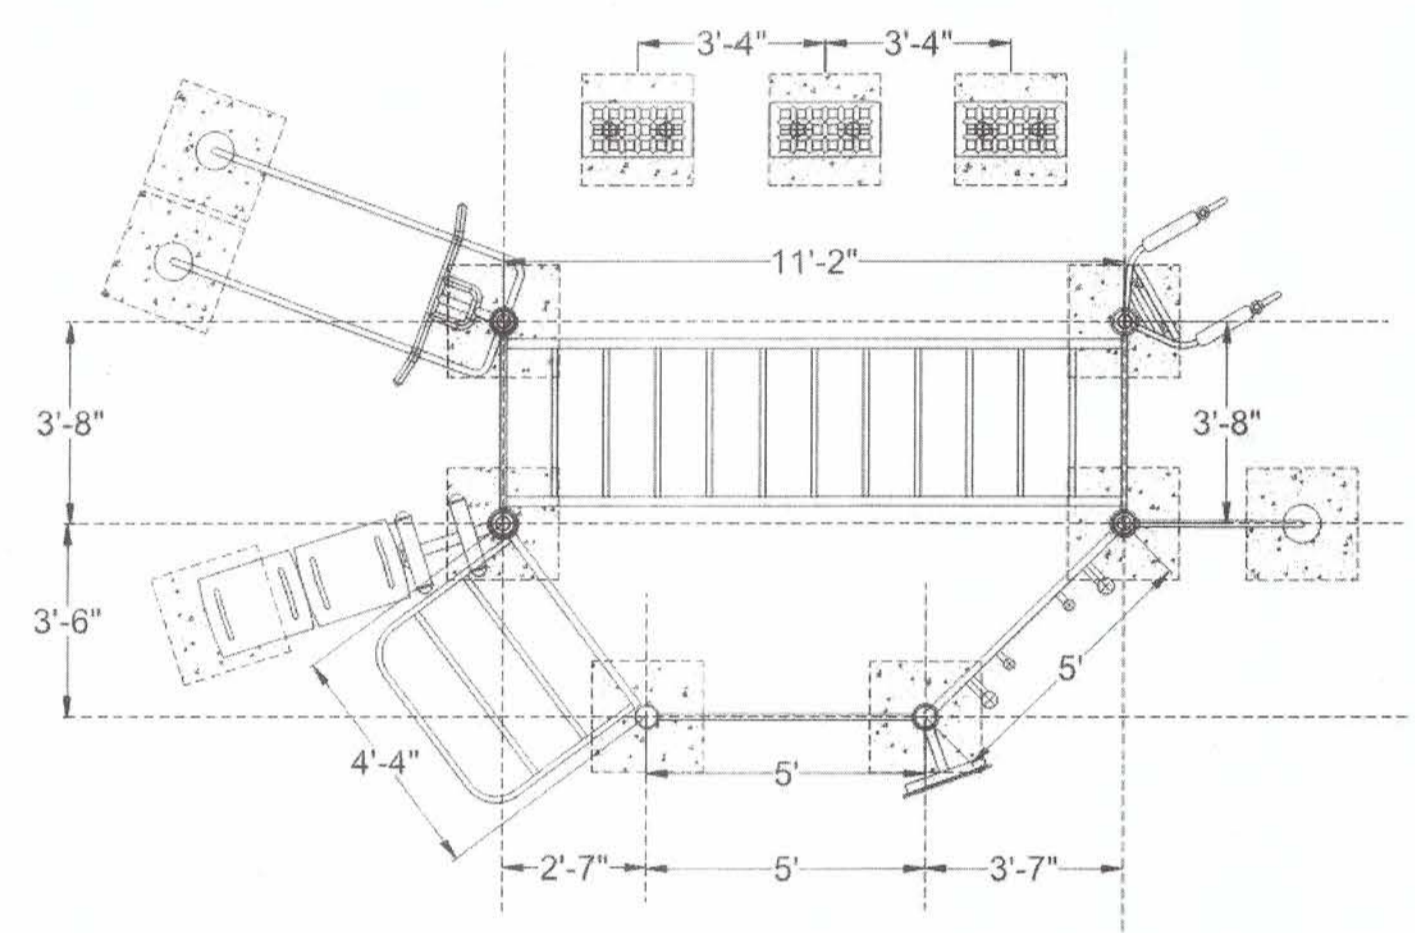
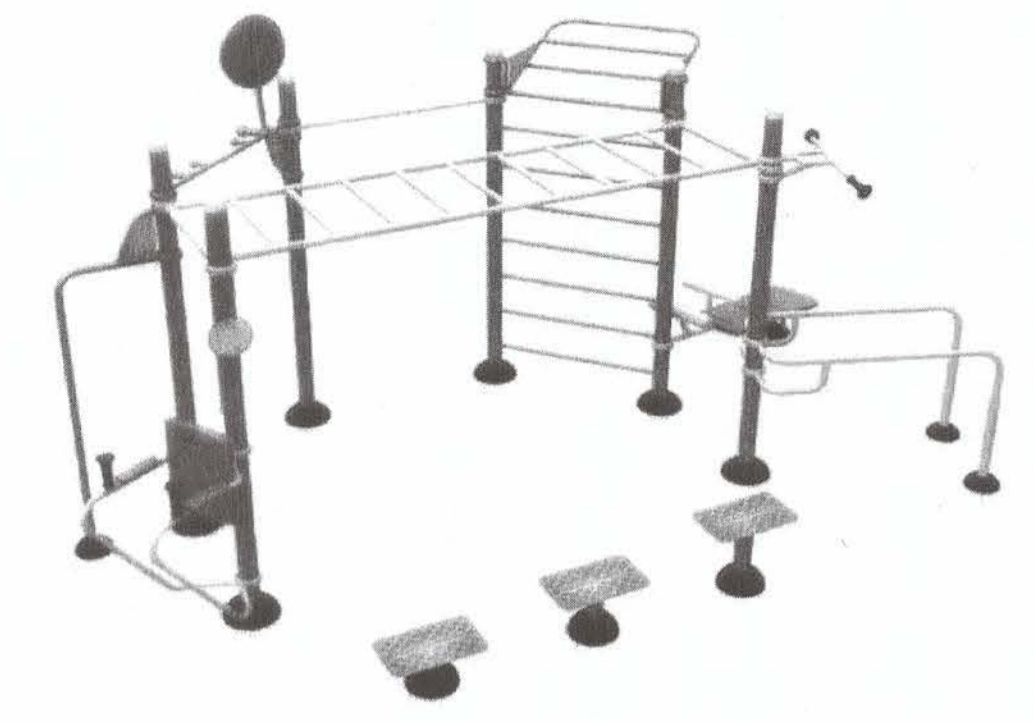


During installation, please be sure to also refer to the general installation instructions.
In order to honor our commitment to quality and safety, Greenfields Outdoor Fitness reserves the right to make changes and revise the design specifications without notice. Greenfields units are designed to accommodate the majority of users age 14 and above. Greenfields units are designed to accommodate the majority of users age 14 and above. Greenfields units are designed to accommodate the majority of users age 14 and above.

Installation Instructions:


SGR2005-1-105
 Announcement Board

This unit ships in 1 separately wrapped component.

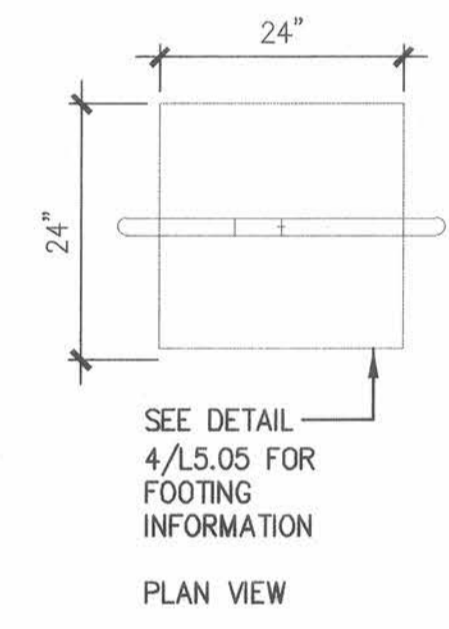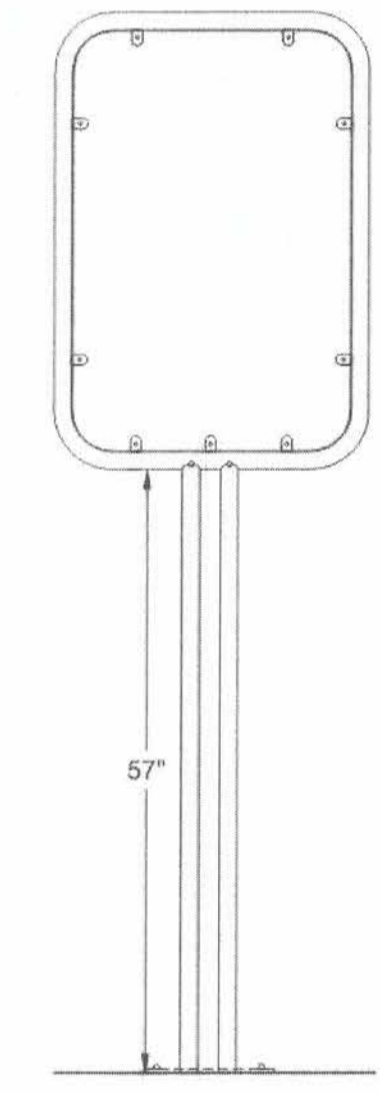

NOTE:
 1. ANNOUNCEMENT BOARD DESCRIPTION SHALL BE REVIEWED AND APPROVED BY THE CITY OF PITTSBURGH PRIOR TO FABRICATION.


During installation, please be sure to also refer to the general installation instructions for surface mount.
In order to honor our commitment to quality and safety, Greenfields Outdoor Fitness reserves the right to make changes and revise the design specifications without notice. © 2018 Greenfields Outdoor Fitness, Inc.

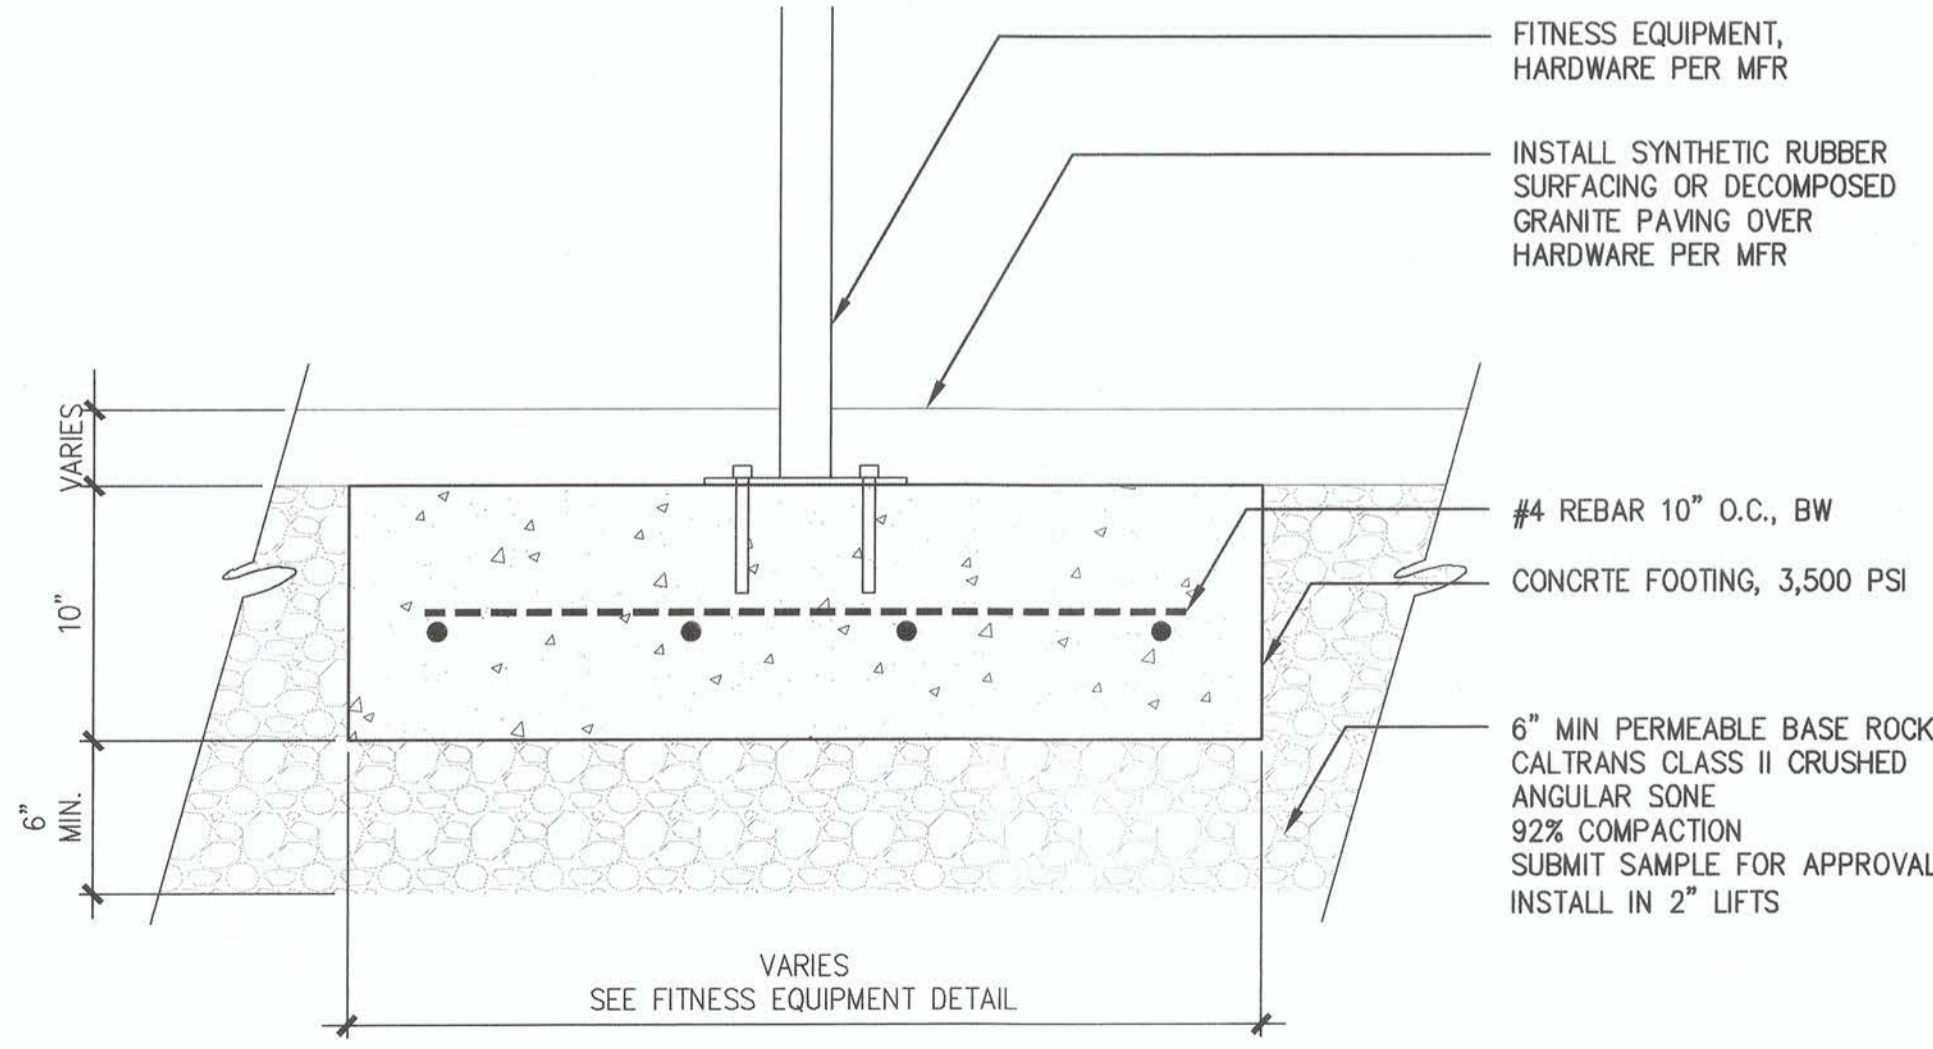

4 FITNESS EQUIPMENT FOOTING AND ATTACHMENT (ADD ALT)
 SCALE: 1-1/2" = 1'-0"

3 ANNOUNCEMENT BOARD (ADD ALT)
 SCALE: N.T.S.

2 FITNESS EQUIPMENT – GROUP FITNESS (ADD ALT)
 SCALE: N.T.S.

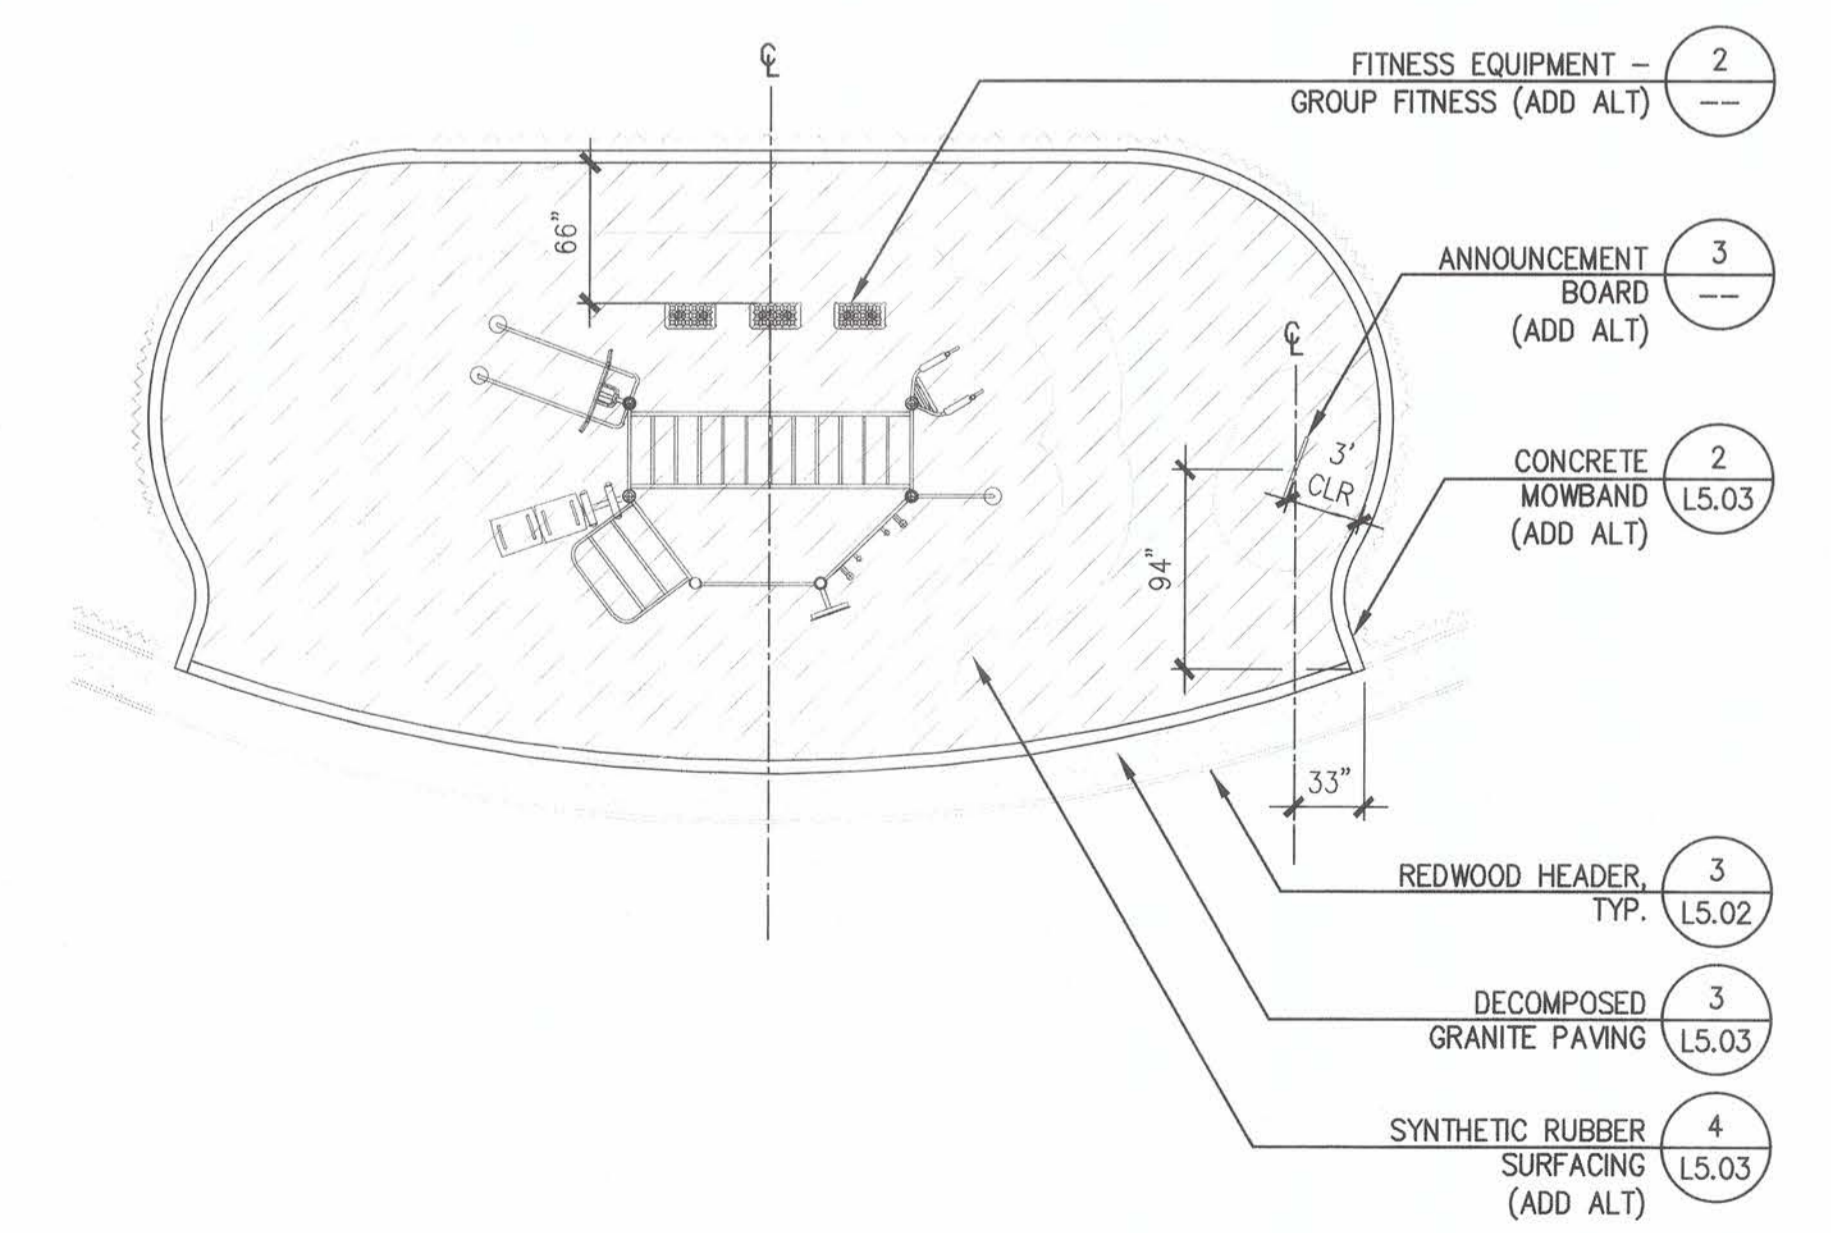

1 FITNESS EQUIPMENT LAYOUT (ADD ALT)
 SCALE: 1/8" = 1'-0"



GATES + ASSOCIATES
 LANDSCAPE ARCHITECTURE
 LAND PLANNING & URBAN DESIGN
 1000 W. 10TH AVE. SUITE 100
 PITTSBURGH, PA 15222
 TEL: 412.324.5174 WWW: GATESA.COM

ACCEPTED FOR USE:
 JOHN SAMUELSON
 City Engineer
 Date: 9/24/23



FRONTAGE ROAD LIVING TRAIL
 CONSTRUCTION DETAILS

BY	DRAWN: TZ	CHECKED: KC	REVIEWED: KC, TZ	DATE: 09/05/23	SCALE: AS SHOWN
DESCRIPTION					
REV					
DATE					
SHEET NO. 59 OF 59					
DWG. NO. L5.05					